


LIST NO.	TA	FED. AID NO.	YEAR	SHET NO.	DATE
UTAH UTAH	I-15-7(58)332	I-15-8(20)334	1		IG-15-8(18)334

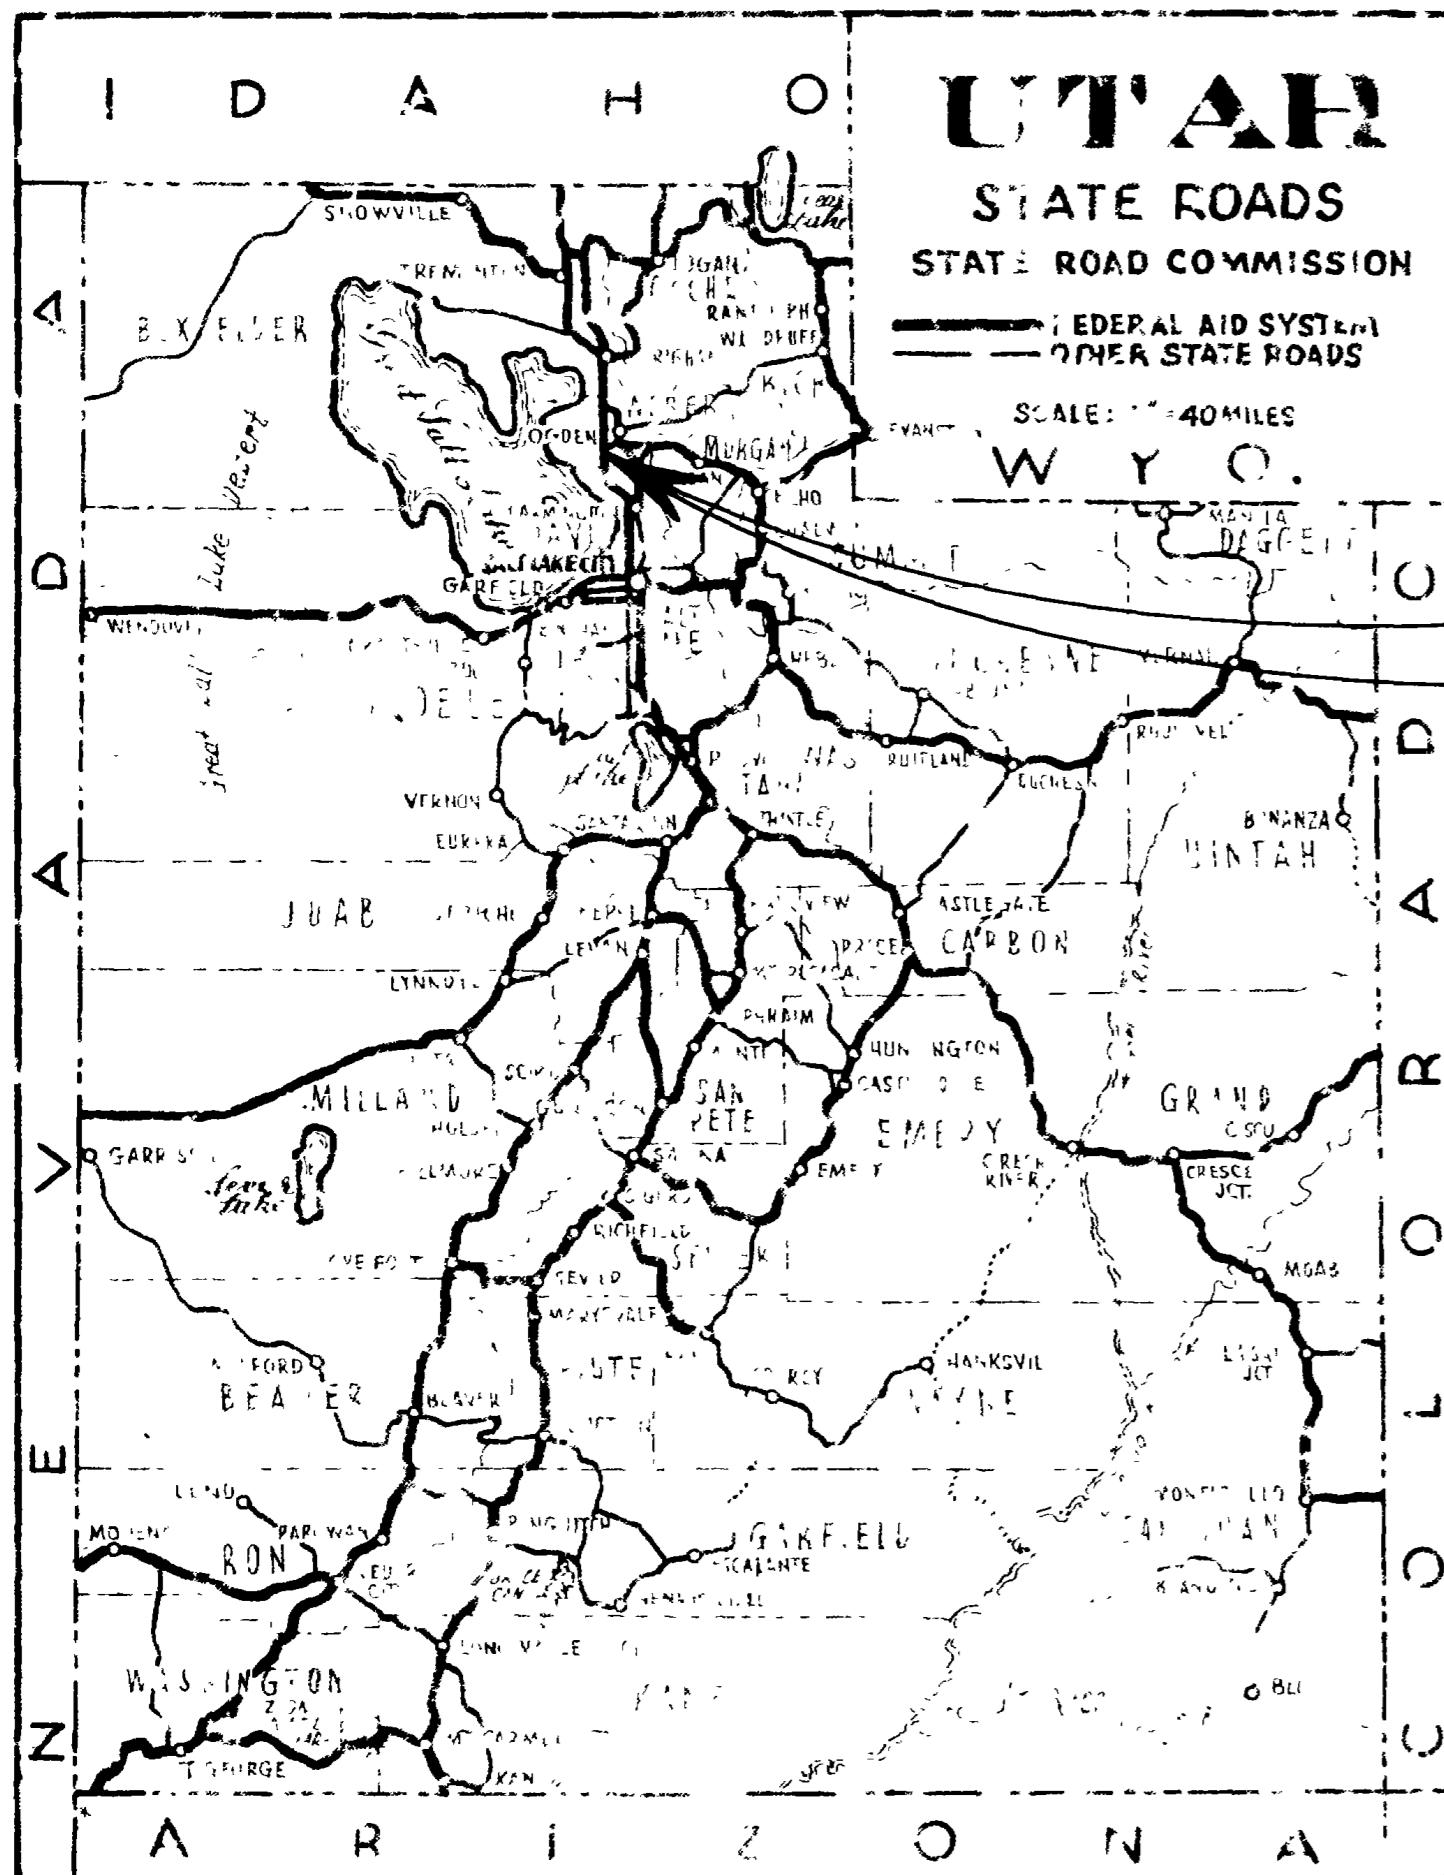

STATE OF UTAH STATE ROAD COMMISSION

I-15-7(58) 332
I-15-8(20) 334
IG-15-8(18) 334

PLANS OF PROPOSED STATE ROAD

FEDERAL AID PROJECT


I-15-7 (58) 332
LENGTH = 2.585 MILES
DAVIS COUNTY

I-15-8 (20) 334
LENGTH = 2.043 MILES
WEBER COUNTY

IG-15-8(18) 334
LENGTH = 0.380 MILES
WEBER COUNTY

INDEX TO SHEETS

DESCRIPTION	DRAWING NO.	SCALE
1 TITLE SHEET		
2,4-C TYPICAL SECTIONS & MATLS. SH.		
3,4-E SUMMARY SHEETS		
4-31 PLAN AND PROFILE		
32-44 HILL FIELD OVERPASS	D-719	1/294621"
45-69 UPRR. OVERPASS	F-80	1/54470
70-95 5600 SOUTH OVERPASS	F-66	1/6546730"
96-101 5600 SOUTH CANAL X-ING	D-744	1/217073600"
102-131 RIVERDALE ROAD UNDERPASS	C-453	1/04143.80
132-145 4400 SOUTH UNDERPASS	D-735	1/55128.04
146 STD. RAILING DETAILS	MR-1	
147 CONCRETE PILES	SP-1	
148 STD. STEEL DETAILS	SS-3	
149 STD. CATCH BASINS	V-752	
150 STD. CATCH BASINS	V-753	
151 STD. CLEANOUT BOXES	V-777	
152-160 STD. ROAD SIGNS	500-1-5	
157 STD. FLARED END SEC. RCP.	B-160-1	
158 RIGHT OF WAY MARKERS	B-164	
159 SUPERELEVATION & WIDENING	202	
160 LEFT TURN MEDIANES	211	
161 CONCRETE CURB & GUTTER	220	
162 DEEP BEAM GUARD RAIL	230	
163 RCP. CULVERTS	320	
164 DROP INLETS	346	
165 CONSTRUCTION IDENT SIGNS	504	
166 CHAIN LINK FENCE	523	

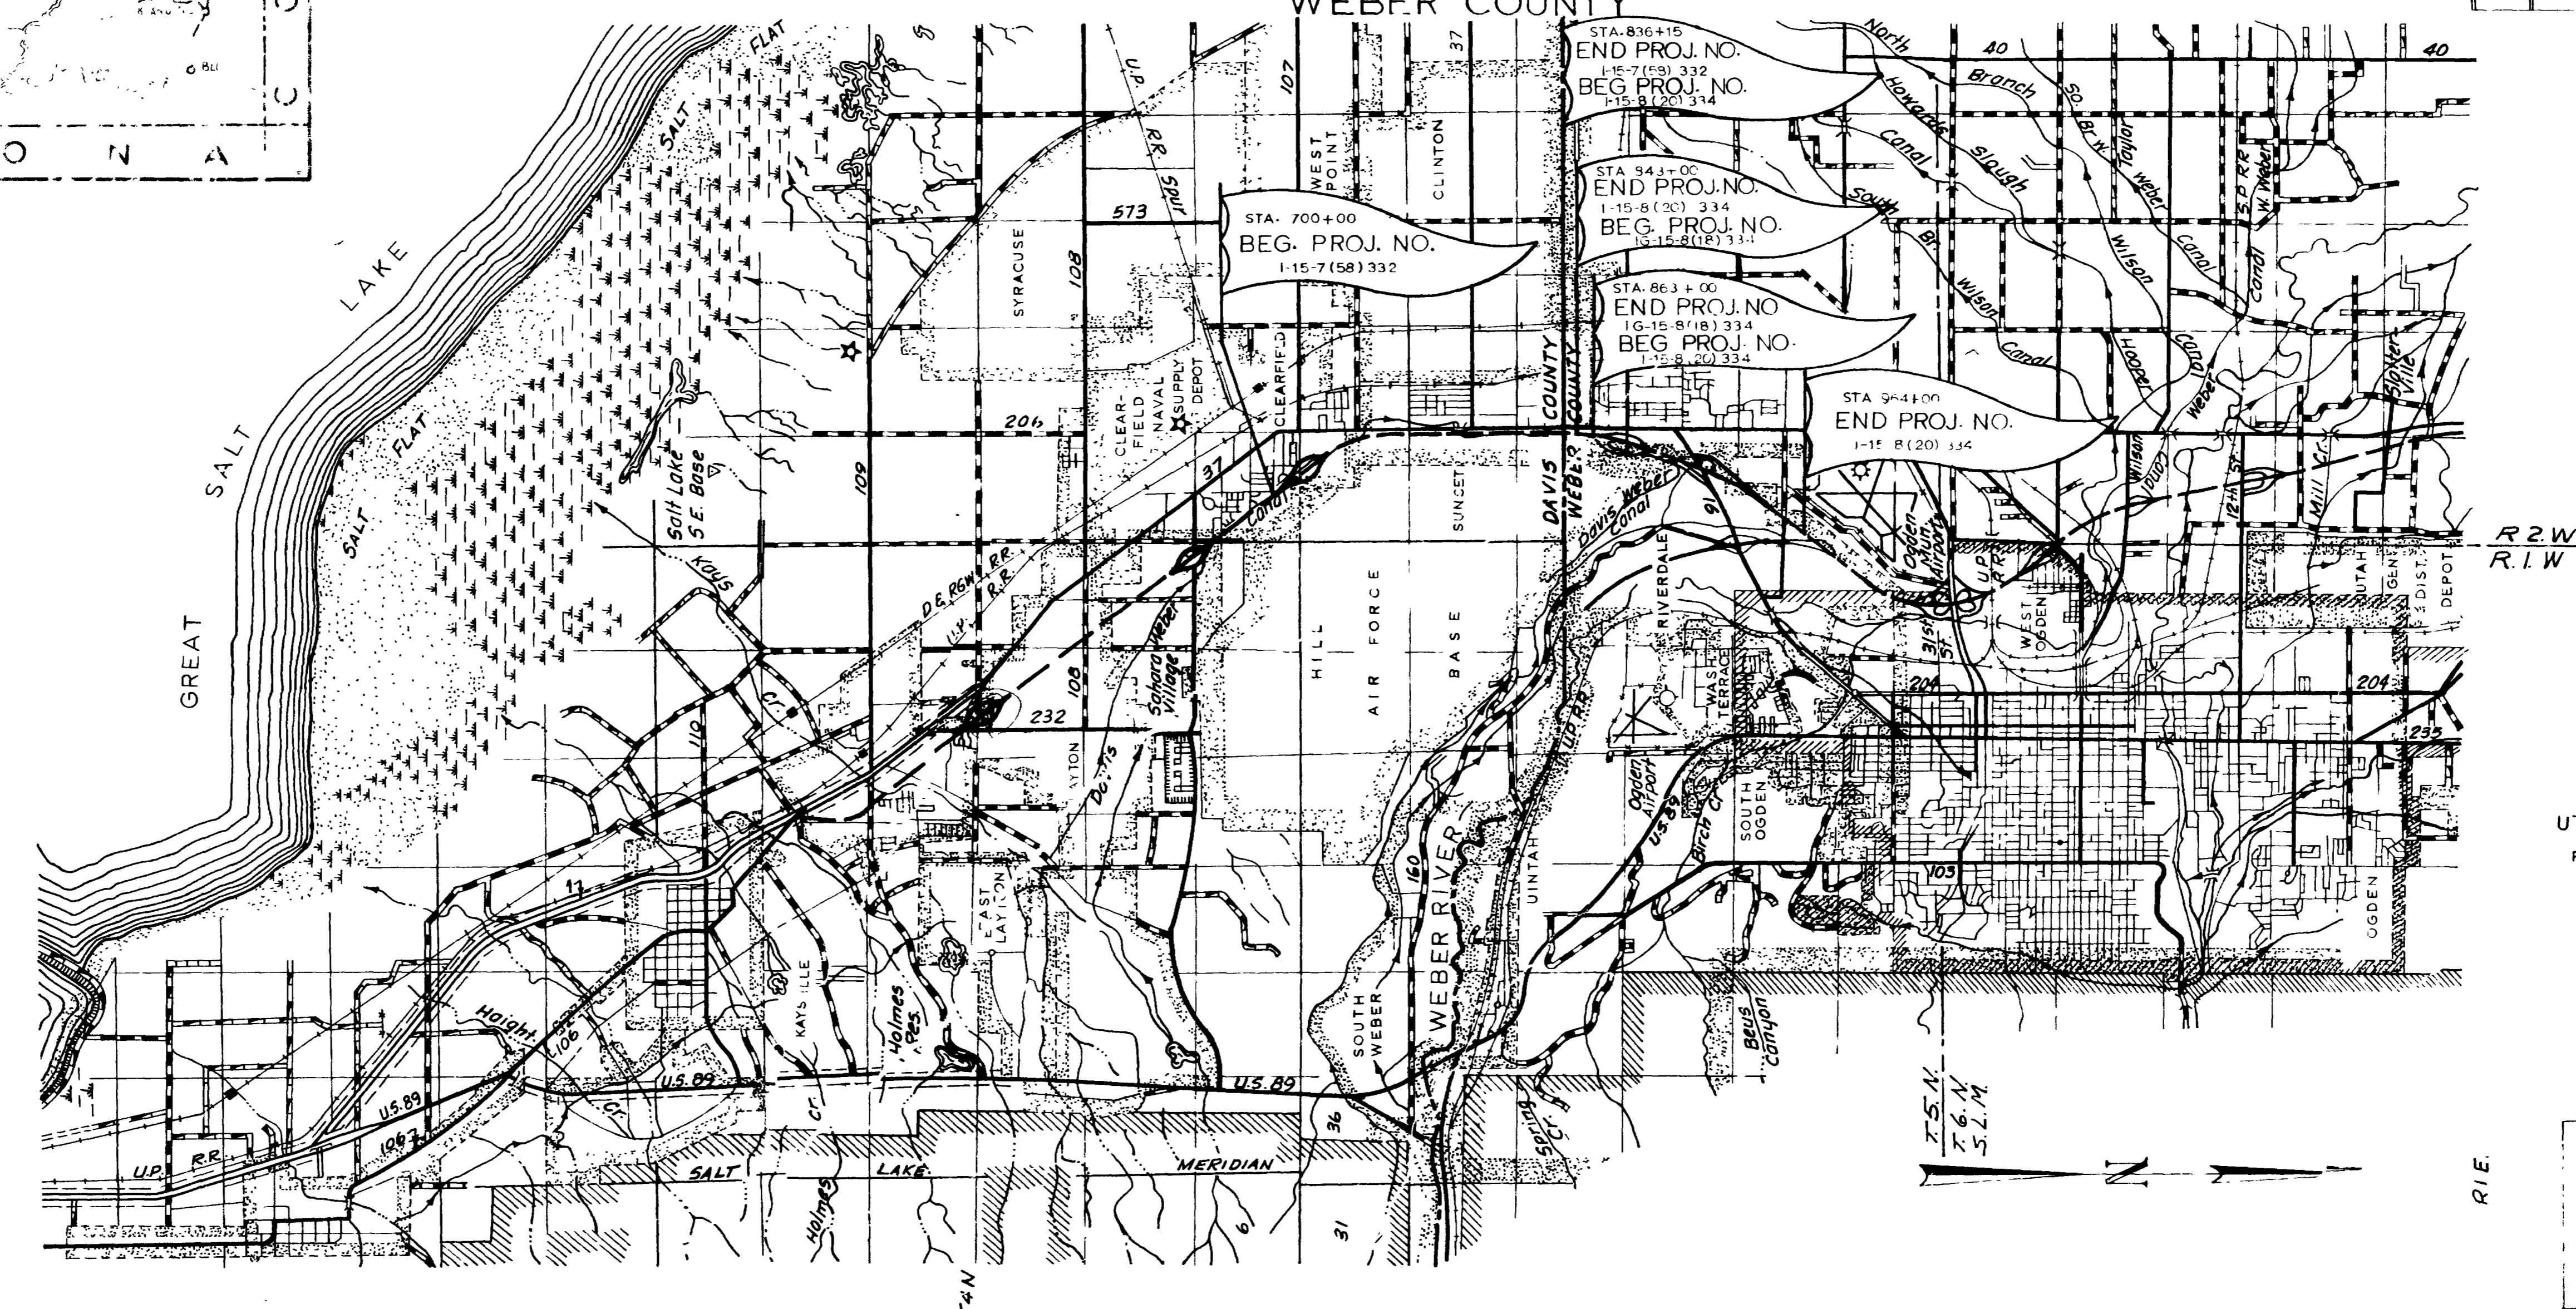

UTAH STATE DEPARTMENT OF HIGHWAY
RECOMMENDED FOR APPROVAL AUG. 1963


C. L. Morelly
ENGINEER OF ROADWAY DESIGN
RECOMMENDED FOR APPROVAL AUG. 1963

Blaine J. Kay
ENGINEER OF PLANS AND CONTRACTS
APPROVED AUG. 1963


James E. Sanderson
ACT. DIRECTOR OF HIGHWAYS

DEPARTMENT OF COMMERCE
BUREAU OF PUBLIC ROADS


APPROVED:
DIVISION ENGINEER DATE
IG-15-8(18)334

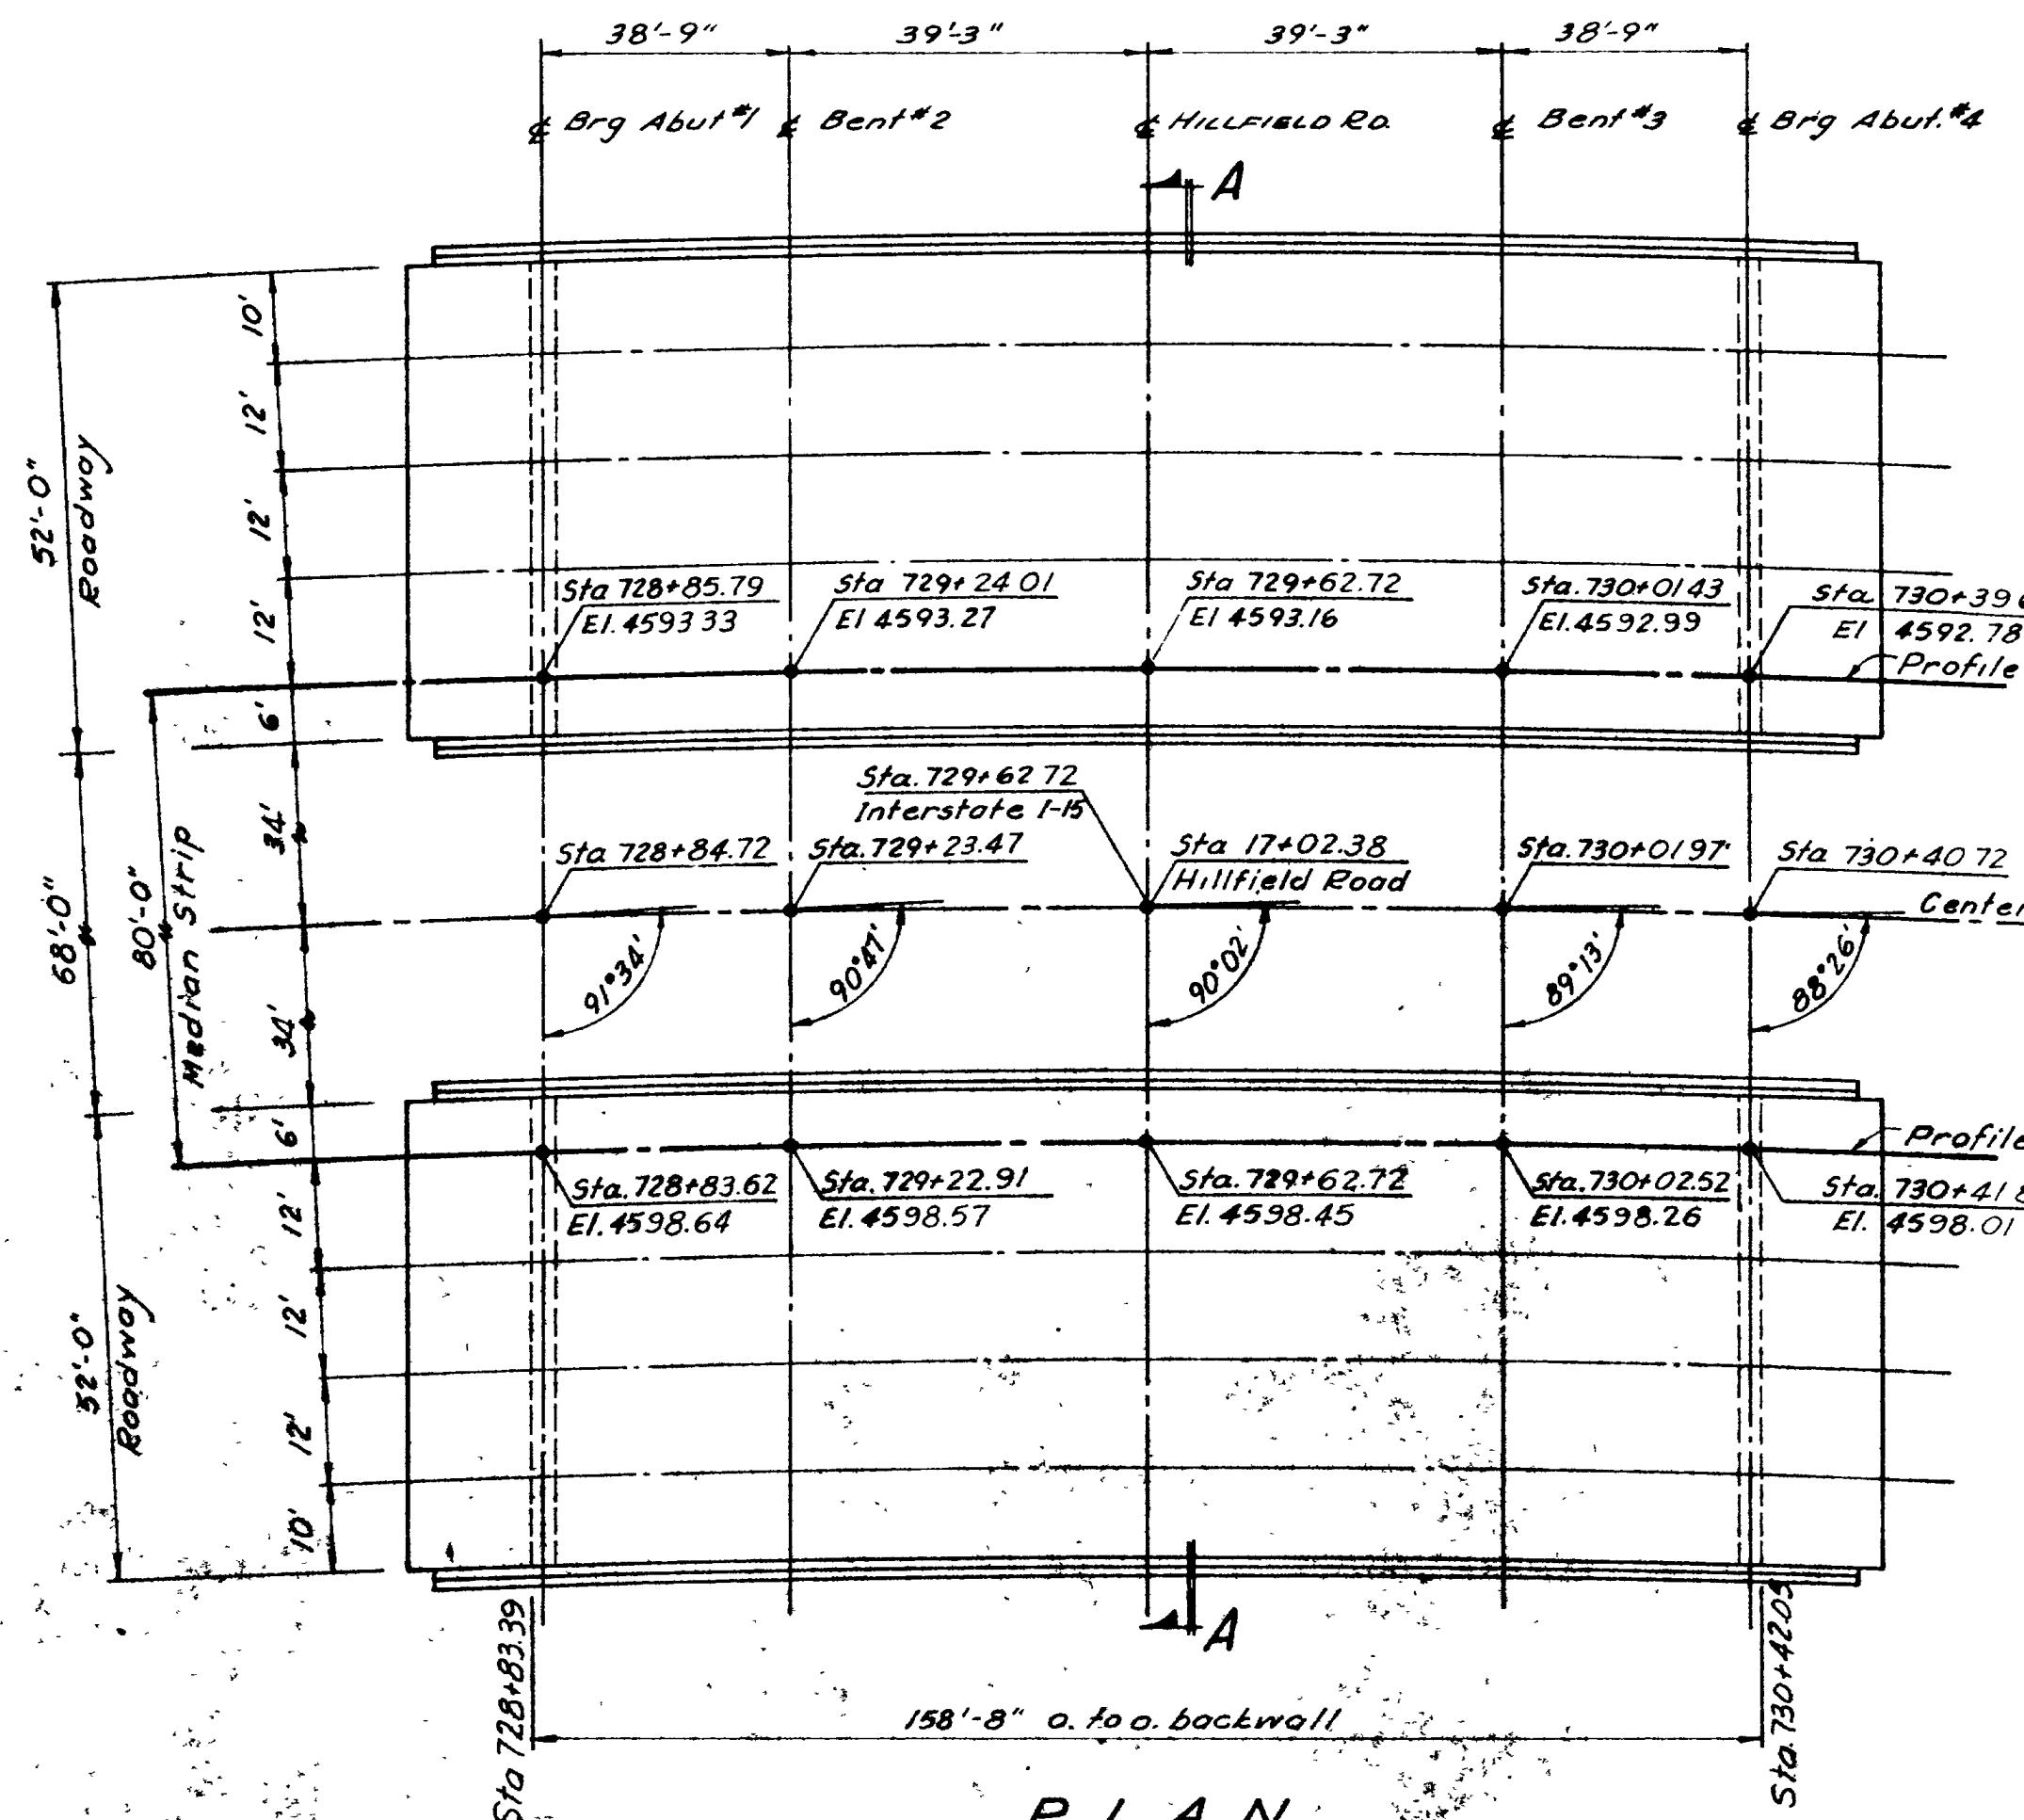


PLA

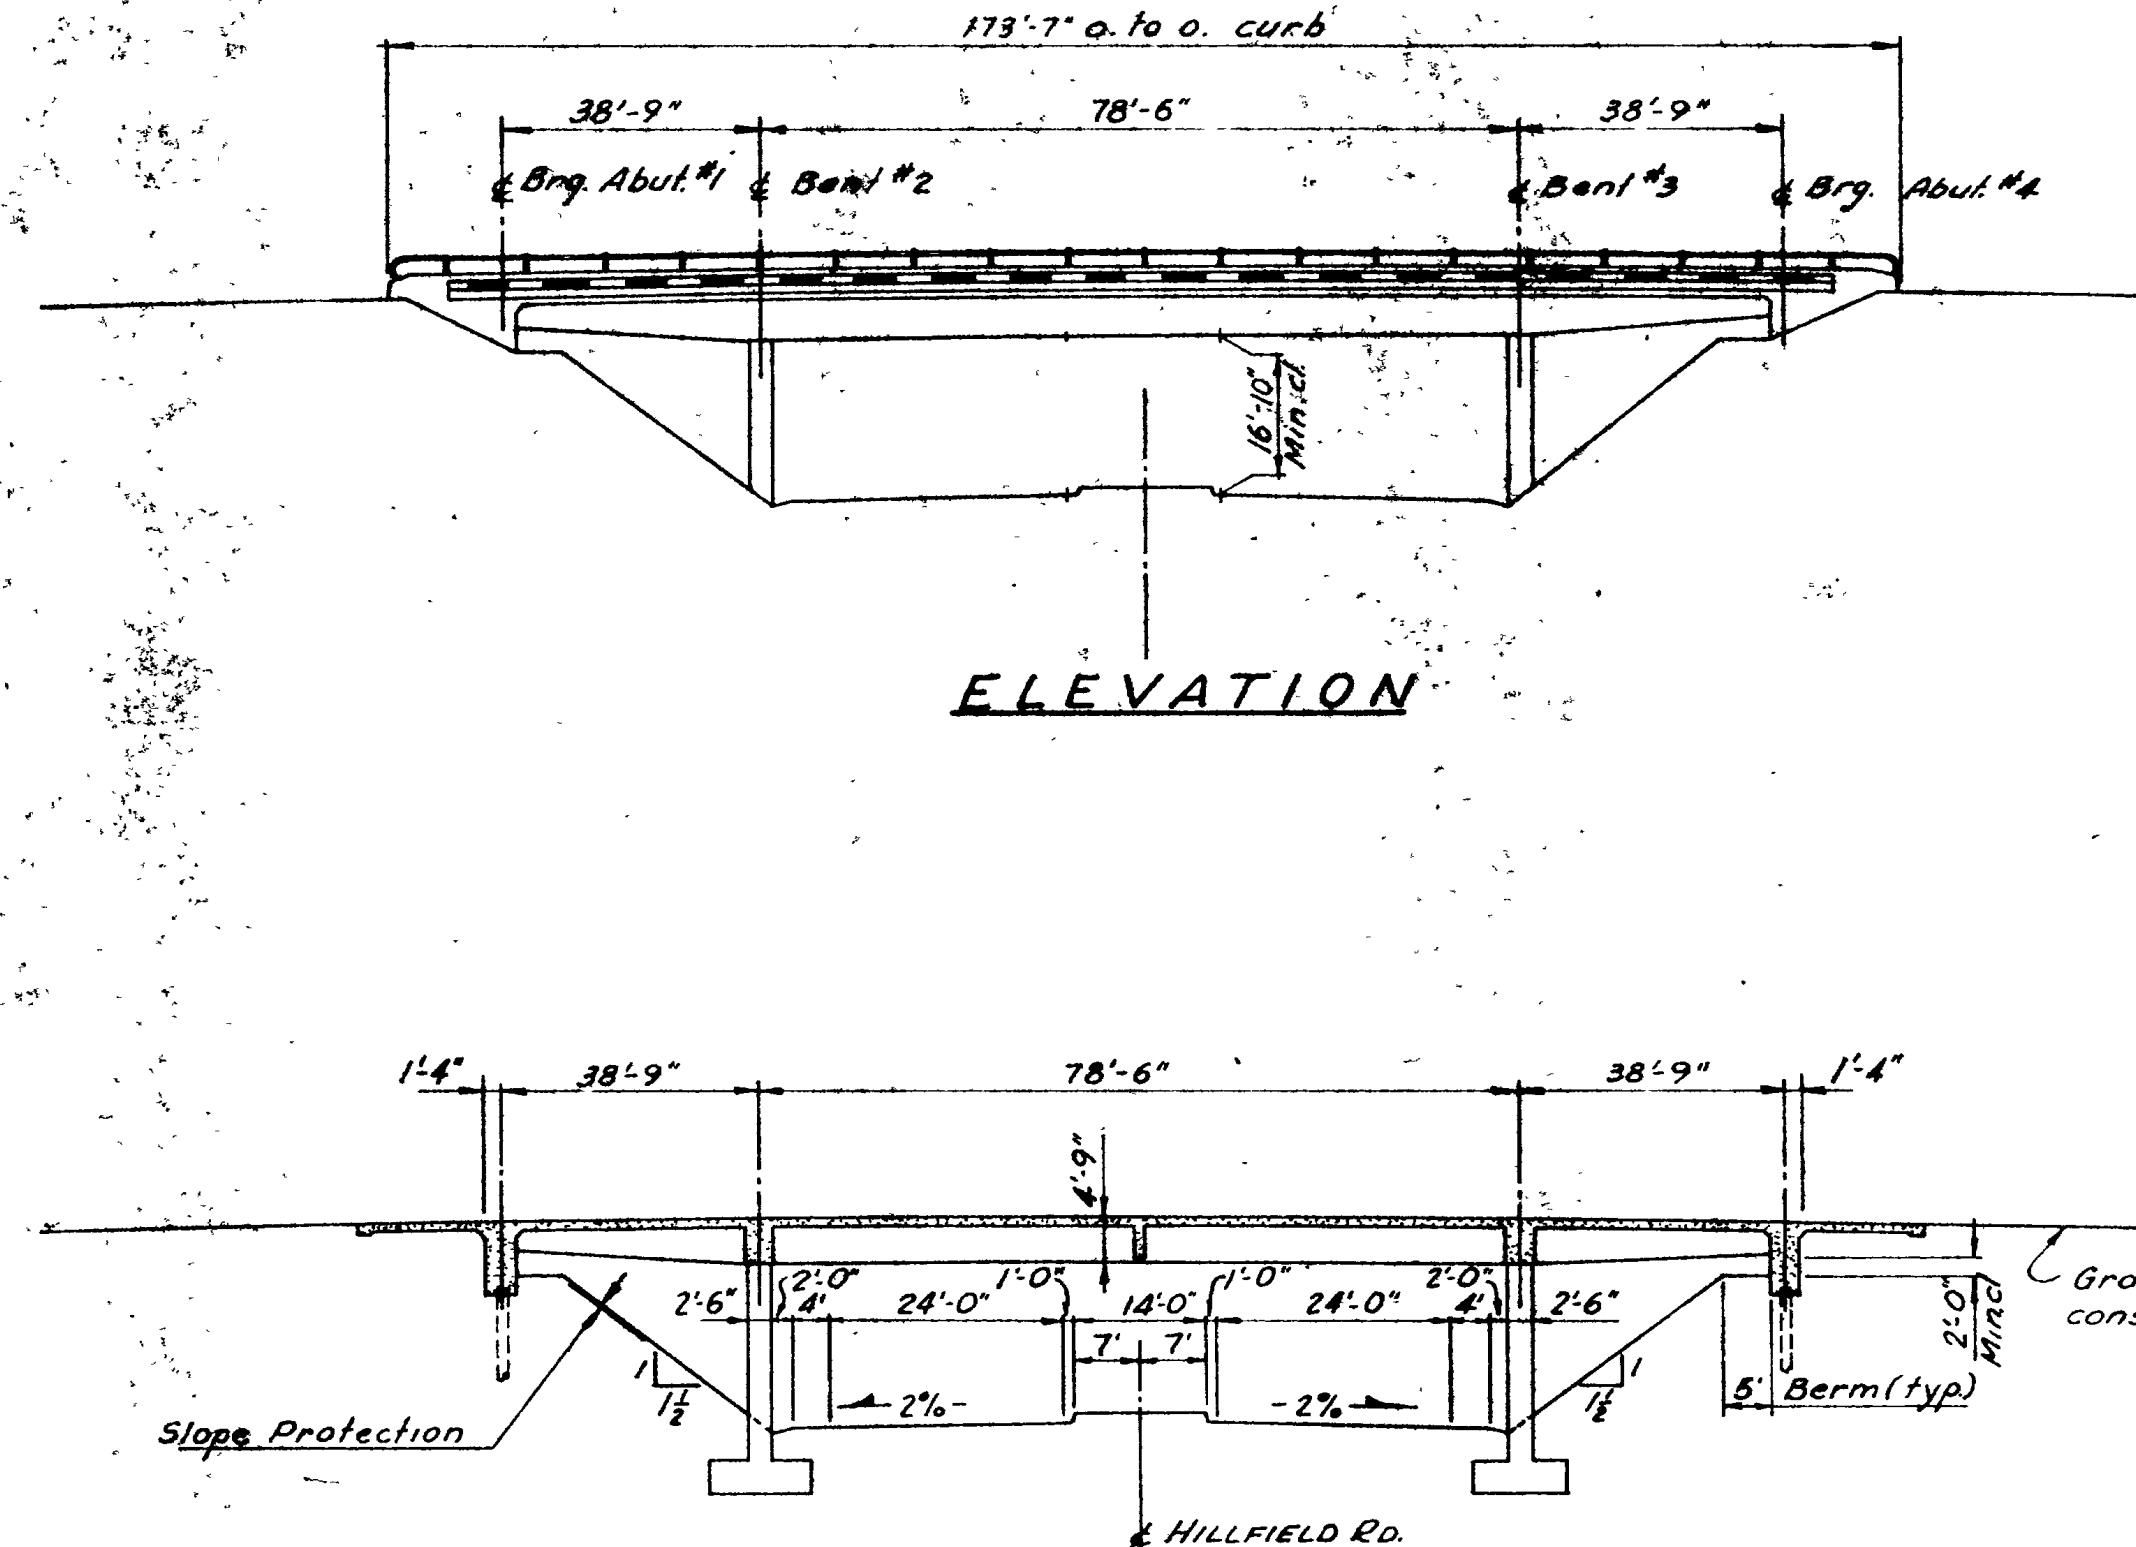

SECTION NORMAL TO HILLFIELD RD.

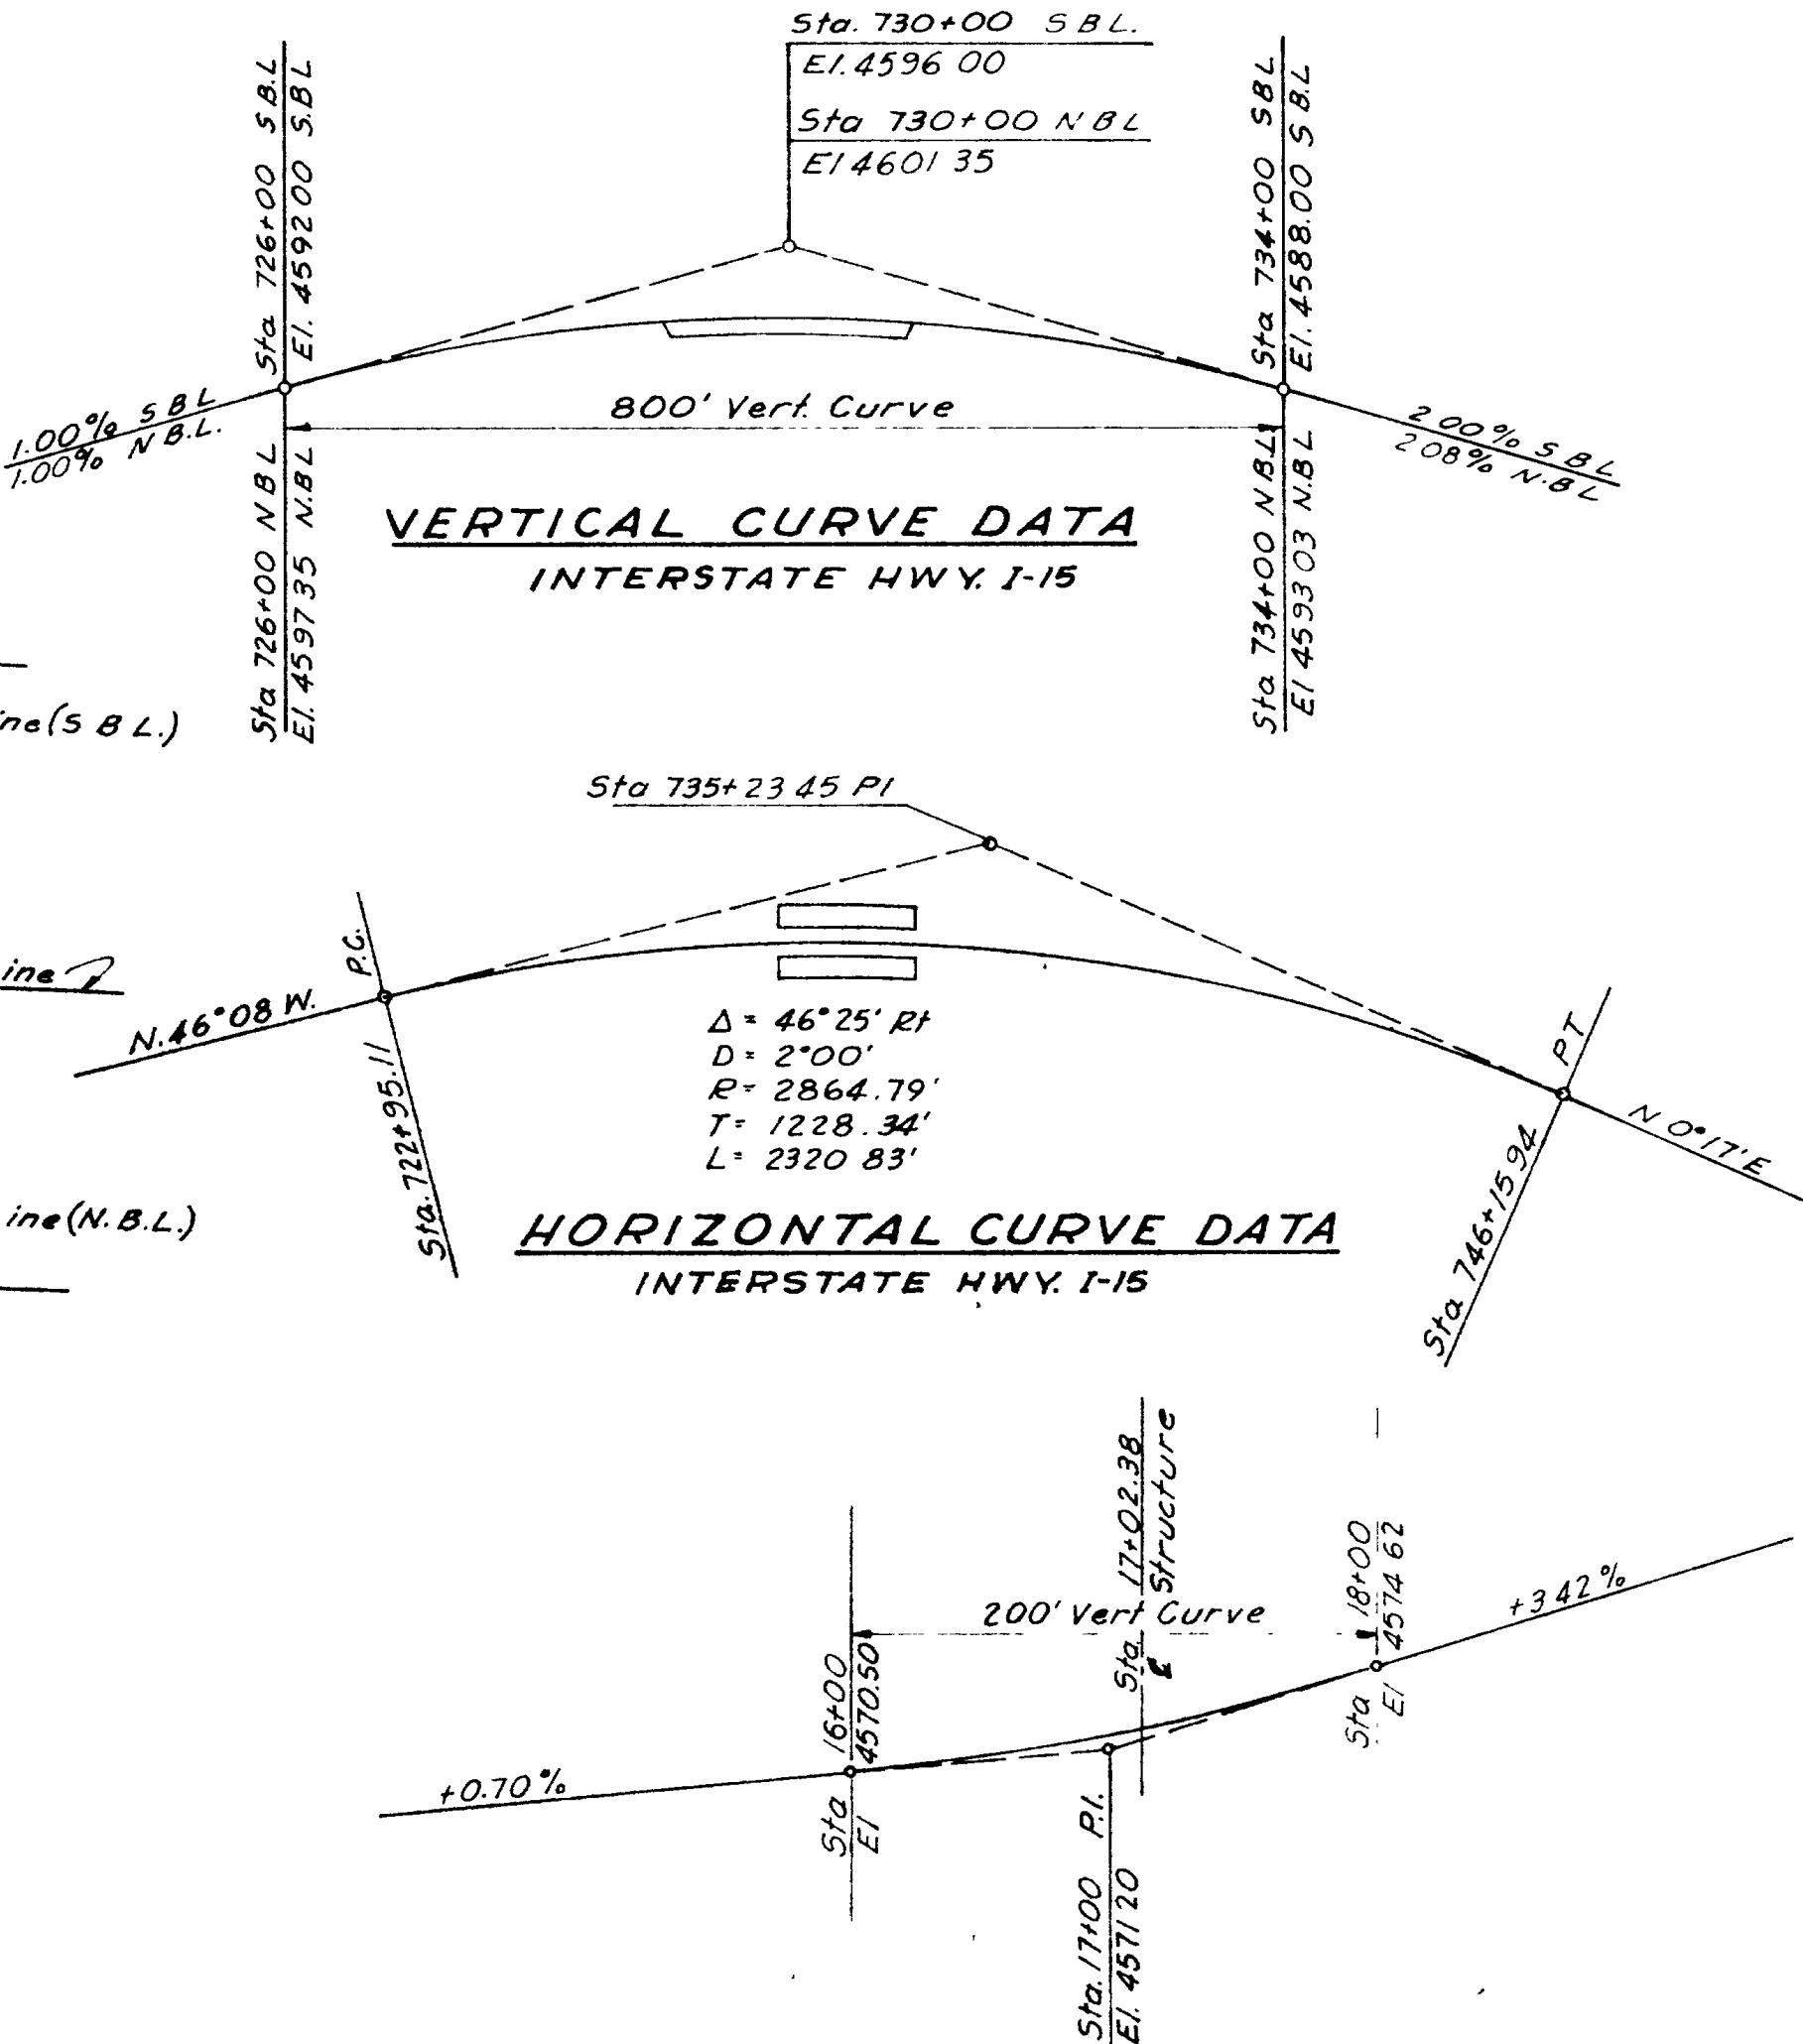

VERTICAL CURVE DATA
HILL FIELD ROAD

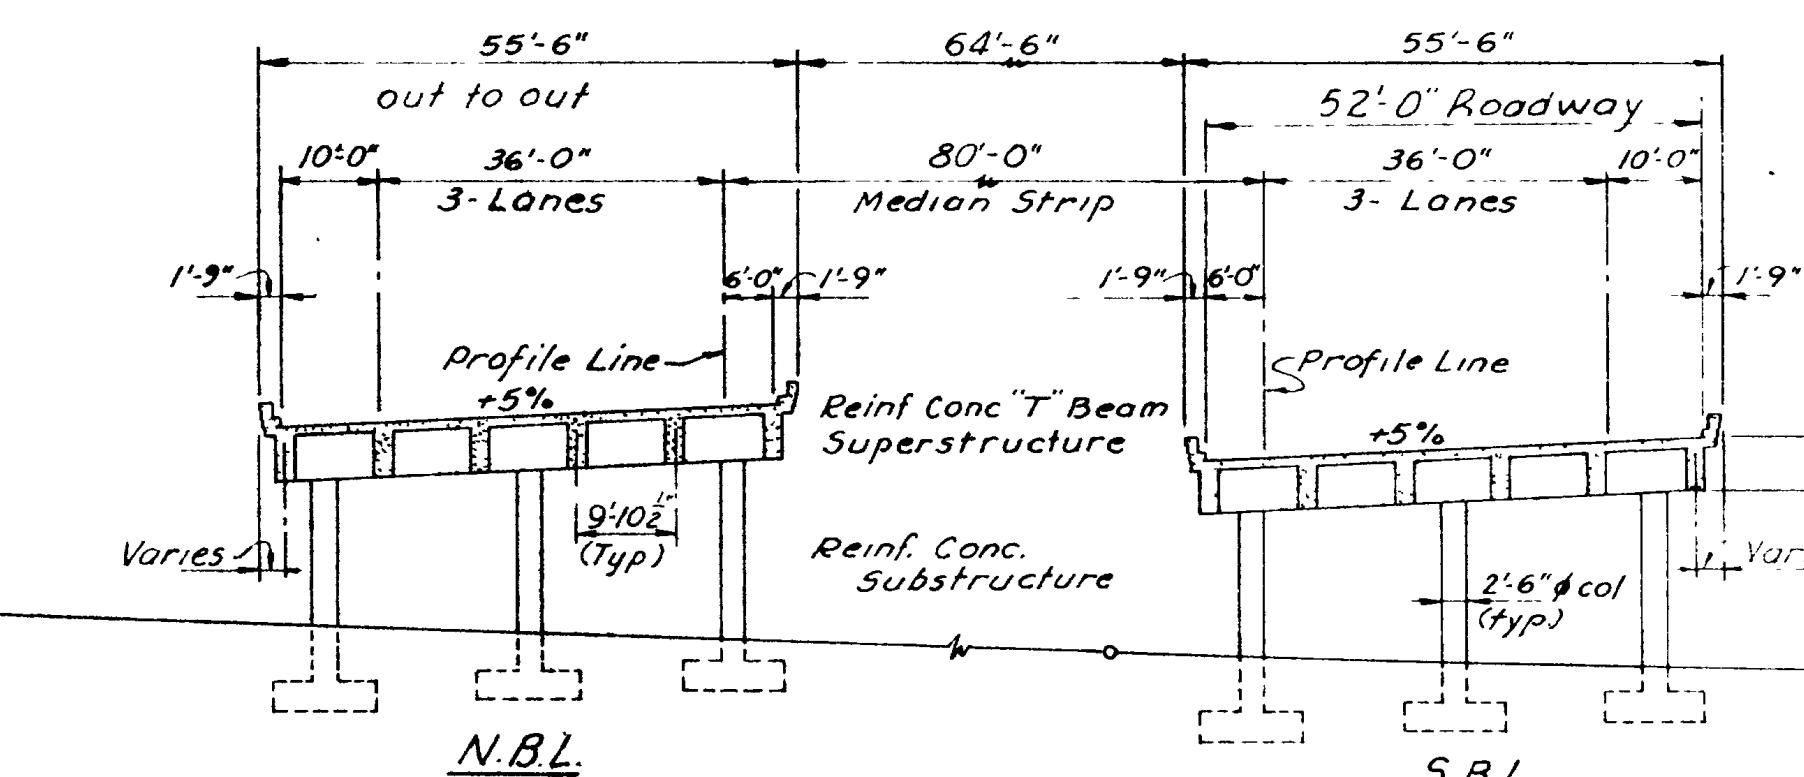

SECTION AA

INDEX OF SHEETS

- 1- LAYOUT & SITUATION
 - 2- FOUNDATION PLAN
 - 3- SOIL DATA
 - 4- DECK PLAN & SECTIONS
 - 5- ABUTMENT NO 1 & 4 DETAILS
 - 6- BENT DETAILS
 - 7- BEAM DETAILS
 - 8- BEAM FRAMING PLAN
 - 9- SCREED ELEVATIONS
 - 10- PARAPET & RAIL DETAILS
 - 11- REINF CONC. SLOPE PROTECTION
 - 12- REINF. STEEL SCHEDULE
 - 13 LIGHTING DETAILS FOR STRUCTURE
 - SP-1 STANDARD PILE DETAILS
 - MR-1 STANDARD RAILING DETAILS

ITEM

- Excavation for Structures (unclass)
- Class A Concrete (AE)
- Structural Steel
- Reinforcing Steel
- Metal Railing (single rail)
- Pile (other than timber)
- Furnish Pile Driving Equipment
- Mechanical Tamping
- Reinf Concrete Slope Protection
- Electrical Work Bridges

<u>ESTIMATED</u>	<u>AS CONSTRUCT.</u>	<u>UNIT</u>
544	418.1	cu yd
1,455	1439.5	cu yd
2,709	2709.0	lb
351,507	351,507.0	lb
689	689.0	lin ft
765	774.4	lin ft.
1	100%	tump
24	28.0	hour
1,337	1471.2	sq yd
1	100%	tump

100% <i>Stamp</i>			
UTAH STATE DEPARTMENT OF HIGHWAYS			
STRUCTURES DIVISION			
HILLFIELD INTERCHANGE to DAVIS-WEBER CO. LINE			
HILLFIELD RD INTERCH O'PASS			
LAYOUT & SITUATION			
DESIGNED BY	MW	REV'D BY	MJC
DRAWN BY	JHO	REC'D BY	MJC
APPROV'D BY	HJS	LEAVE BY	BMW
RECOMMENDED BY	<i>M. Jay Christiansen</i>	I.D. NO.	
APPROV'D DATE	<i>Aug - 22</i>	STAT. IN	
PER	FOR	DAVIS C. NY	
NO.		D-719	
		1-CF-13	

UTAH STATE DEPARTMENT OF HIGHWAYS

STRUCTURES DIVISION

HILLFIELD INTERCHANGE to DAVIS - WEBER CO. LINE

HILLFIELD RD INTERCH O'PASS

LAYOUT & SITUATION

J-15-7(58)332


DRAWN BY JAO DATE 7/1/64 BY ELTN MBR

729462.72
STAT IN

APR 11 1965 - 10-1 DAVIS

C N Y

ER NC D-719 1 C E 13

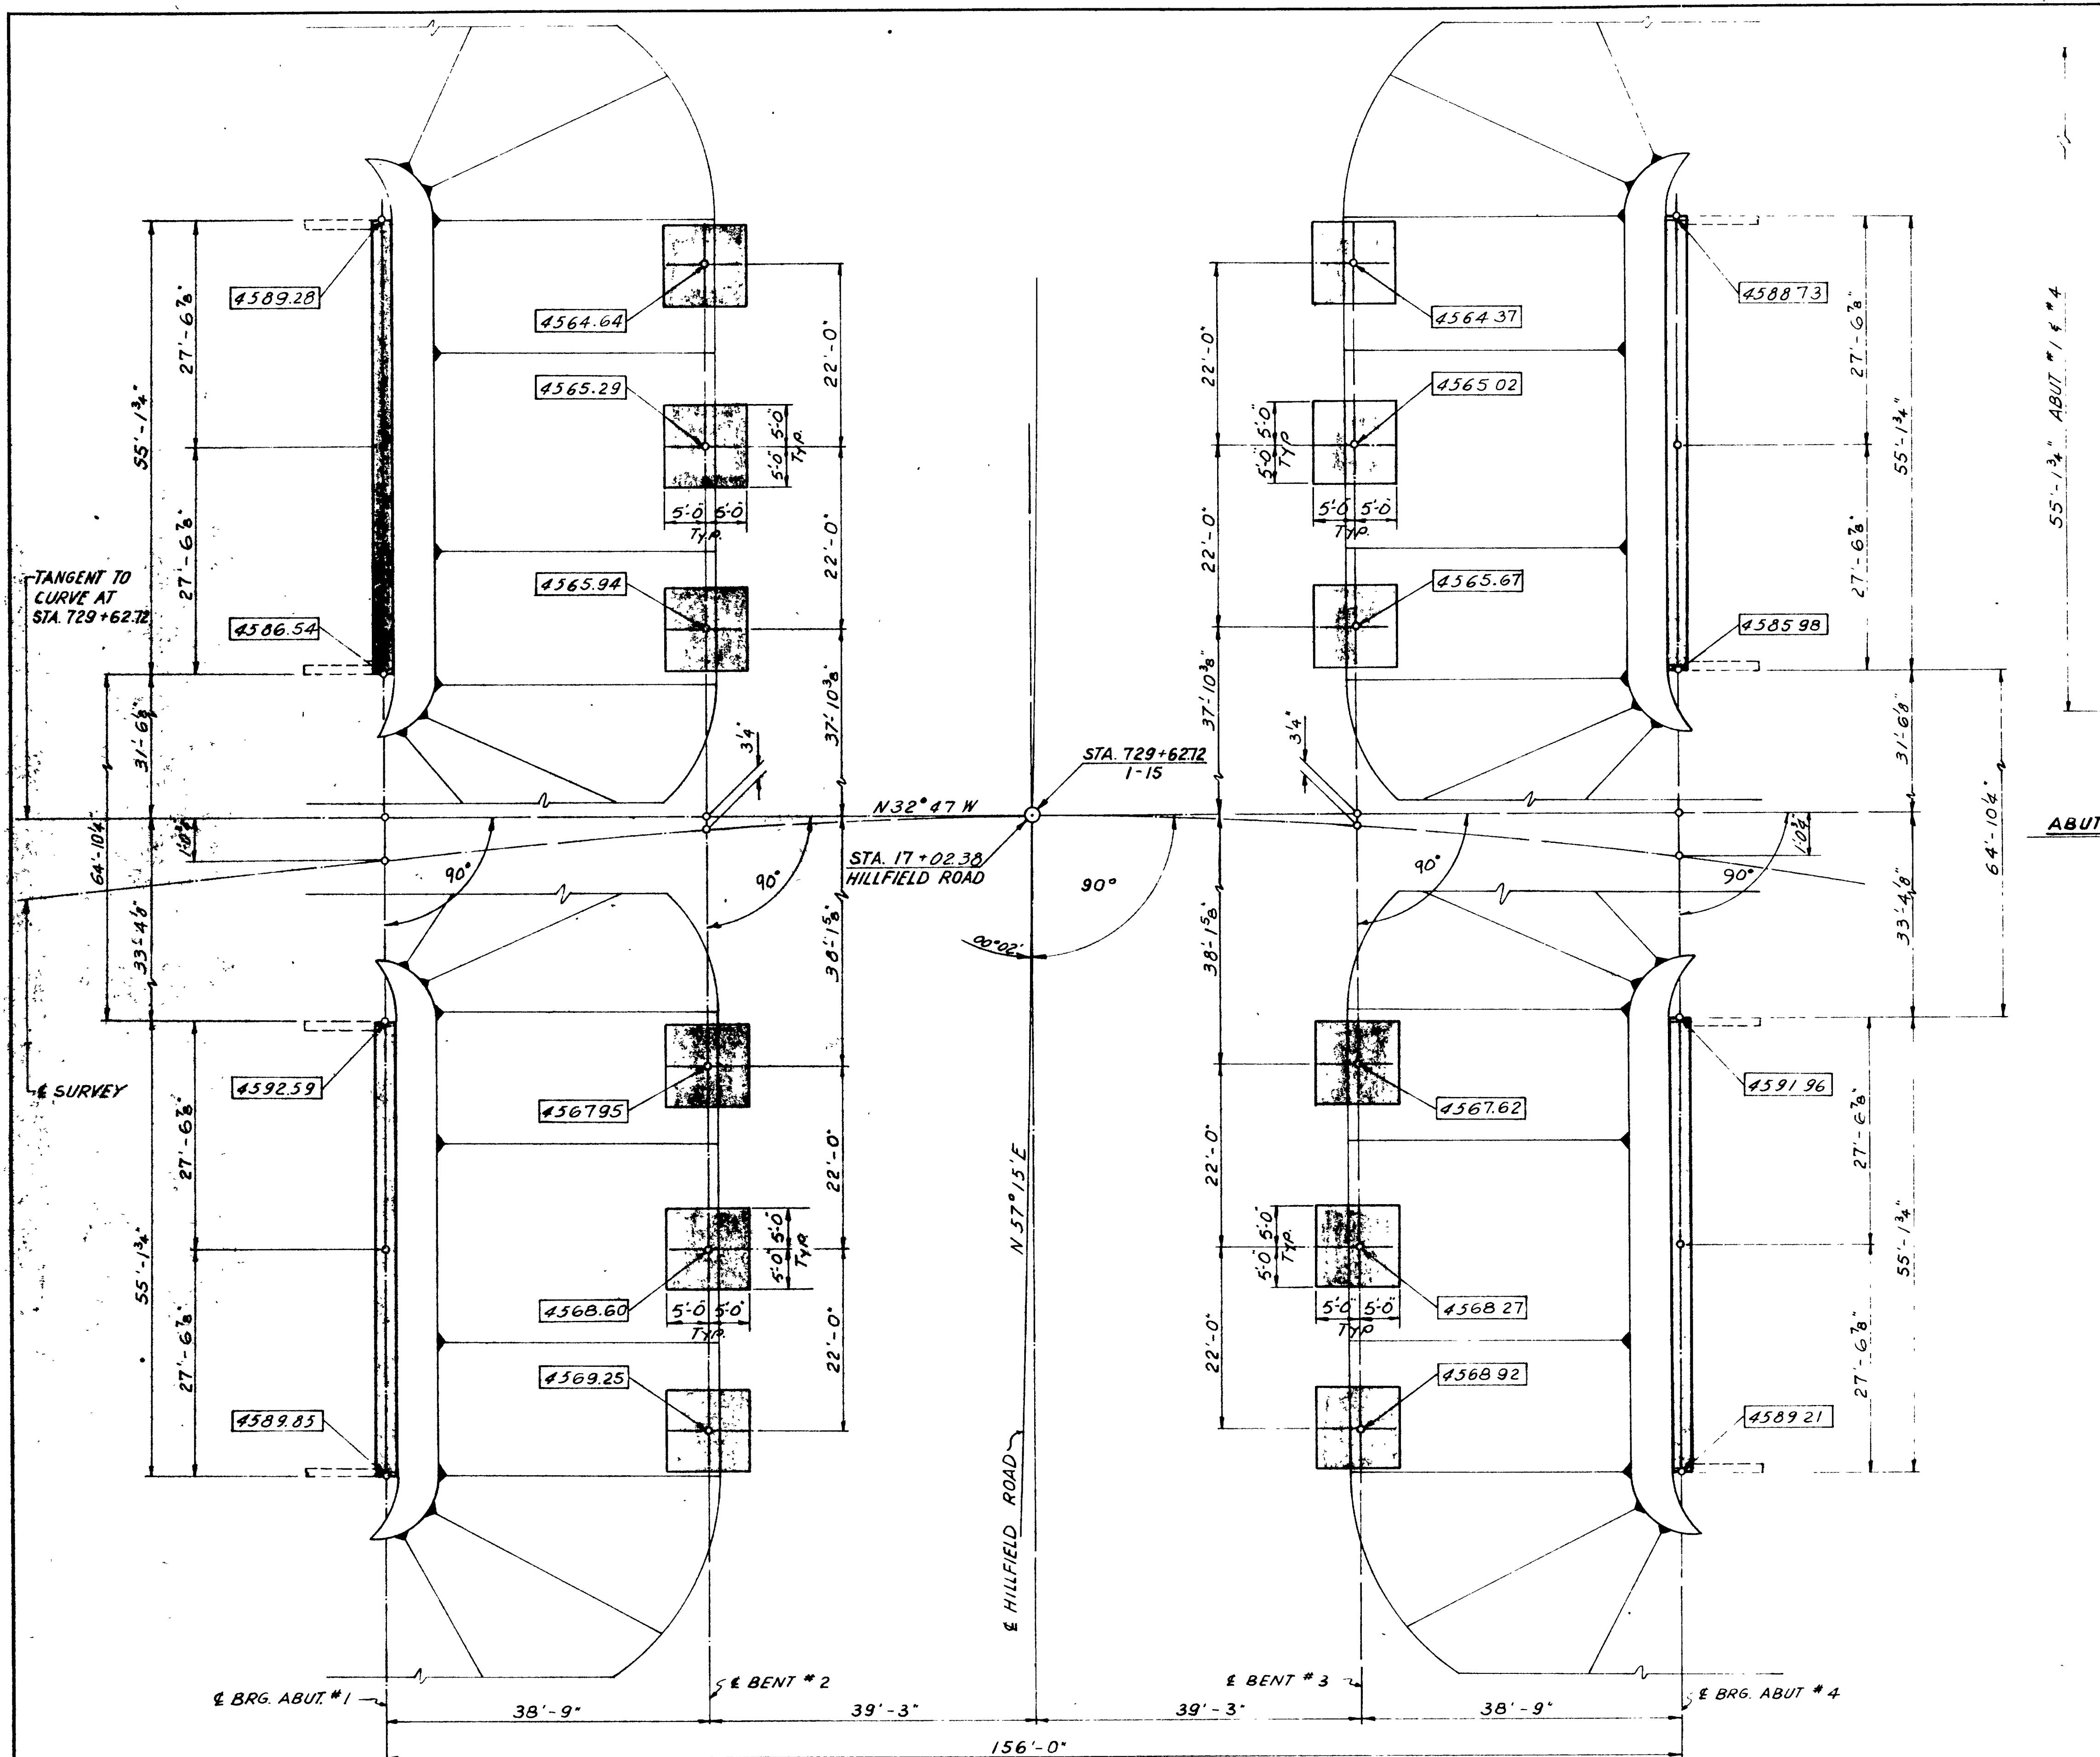


NOTES


- 1 - PILE DESIGN LOAD IS 50 TONS DL & LL
- 2 - SEE DRAWING SP-1 FOR PILES (OTHER THAN TIMBER) DETAILS
- 3 - TIP ELEVATIONS GIVEN ARE APPROXIMATE ONLY AND WILL BE VERIFIED AT THE TIME OF CONSTRUCTION IN ACCORDANCE WITH THE SPECIFICATIONS.
- 4 - ELEVATIONS AT BOTTOM OF FOOTINGS ARE SHOWN ENCLOSED IN RECTANGLES
- 5 - ALL ABUTMENTS AND BENTS ARE PARALLEL TO EACH OTHER.
- 6 - MAXIMUM ALLOWABLE SOIL BEARING PRESSURE 3 TONS/SQ. FT.
- 7 - MAXIMUM SOIL BEARING PRESSURE
CENTER COLUMN = 3 TONS/SQ. FT.
OUTSIDE COLUMN = 2.2 TONS/SQ. FT.

PILE LOADS (KIPS)	
ABUTMENTS	
LOAD	PLUMB
DL 9 E	62
GROUP I	90

UTAH STATE DEPARTMENT OF HIGHWAYS SALT LAKE CITY, UTAH STRUCTURES DIVISION			
HILLFIELD INTERCHANGE to DAVIS-WEBER CO LINE HILLFIELD RD INTERCH O'PASS FOUNDATION PLAN			
DESIGNED BY M.W.	CHECKED BY M.J.C.	1-15-7 (58) 332	
DRAWN BY HJS	CHECKED BY M.J.C.	PROJECT NUMBER	
QUANTIFIED BY HJS	CHECKED BY B.M.W.	729+6272	
APPROVAL RECOMMENDED BY M.W. Christianen	REVIEWED BY L.M. Taylor	STATION	
APPROVED Aug 27 1972			
BY THE STATE OF UTAH			
DAVIS COUNTY			
NO	BY DATE	REMARKS	
REV. NO.		REVISIONS	
DRG NO.	D-719	2 OF 13	

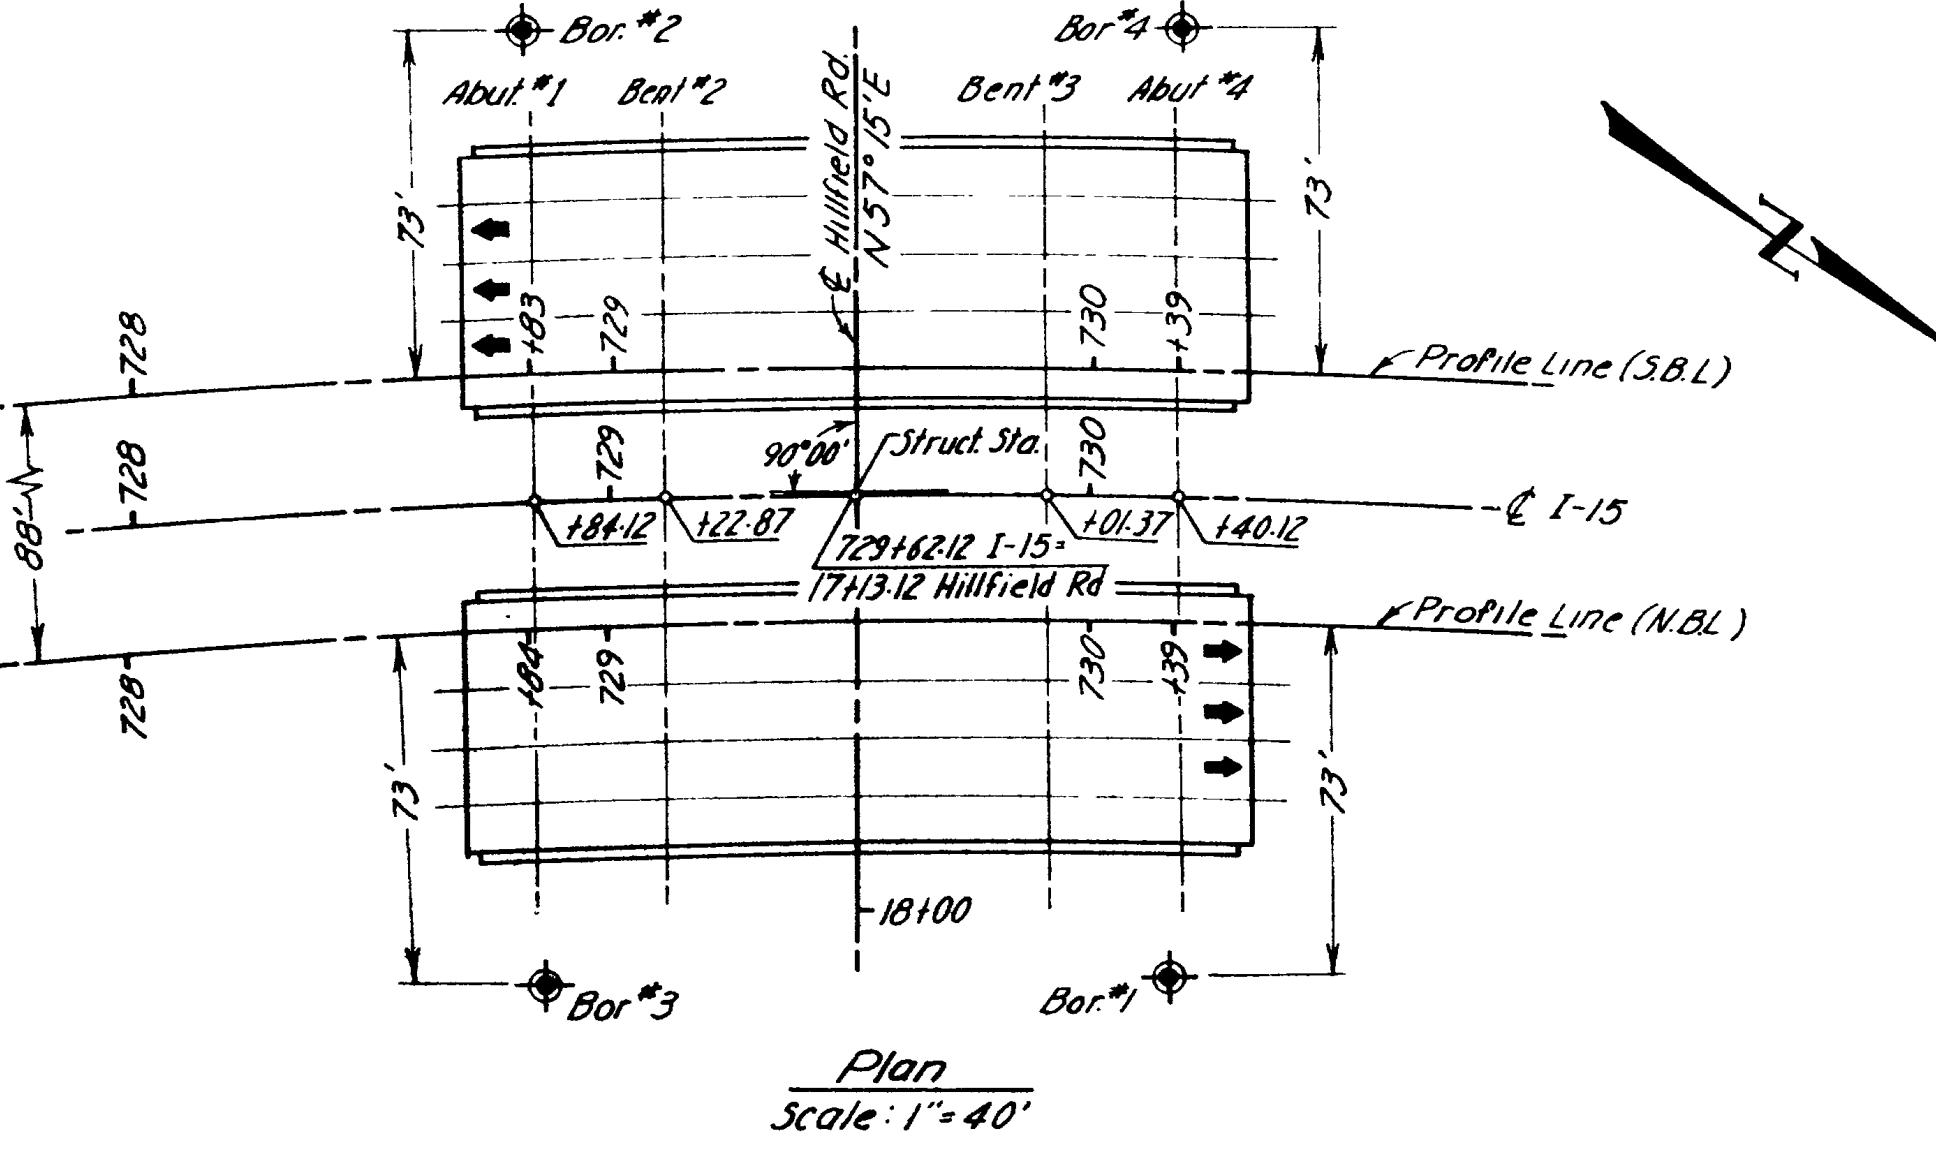

Plan
Scale: 1" = 40'

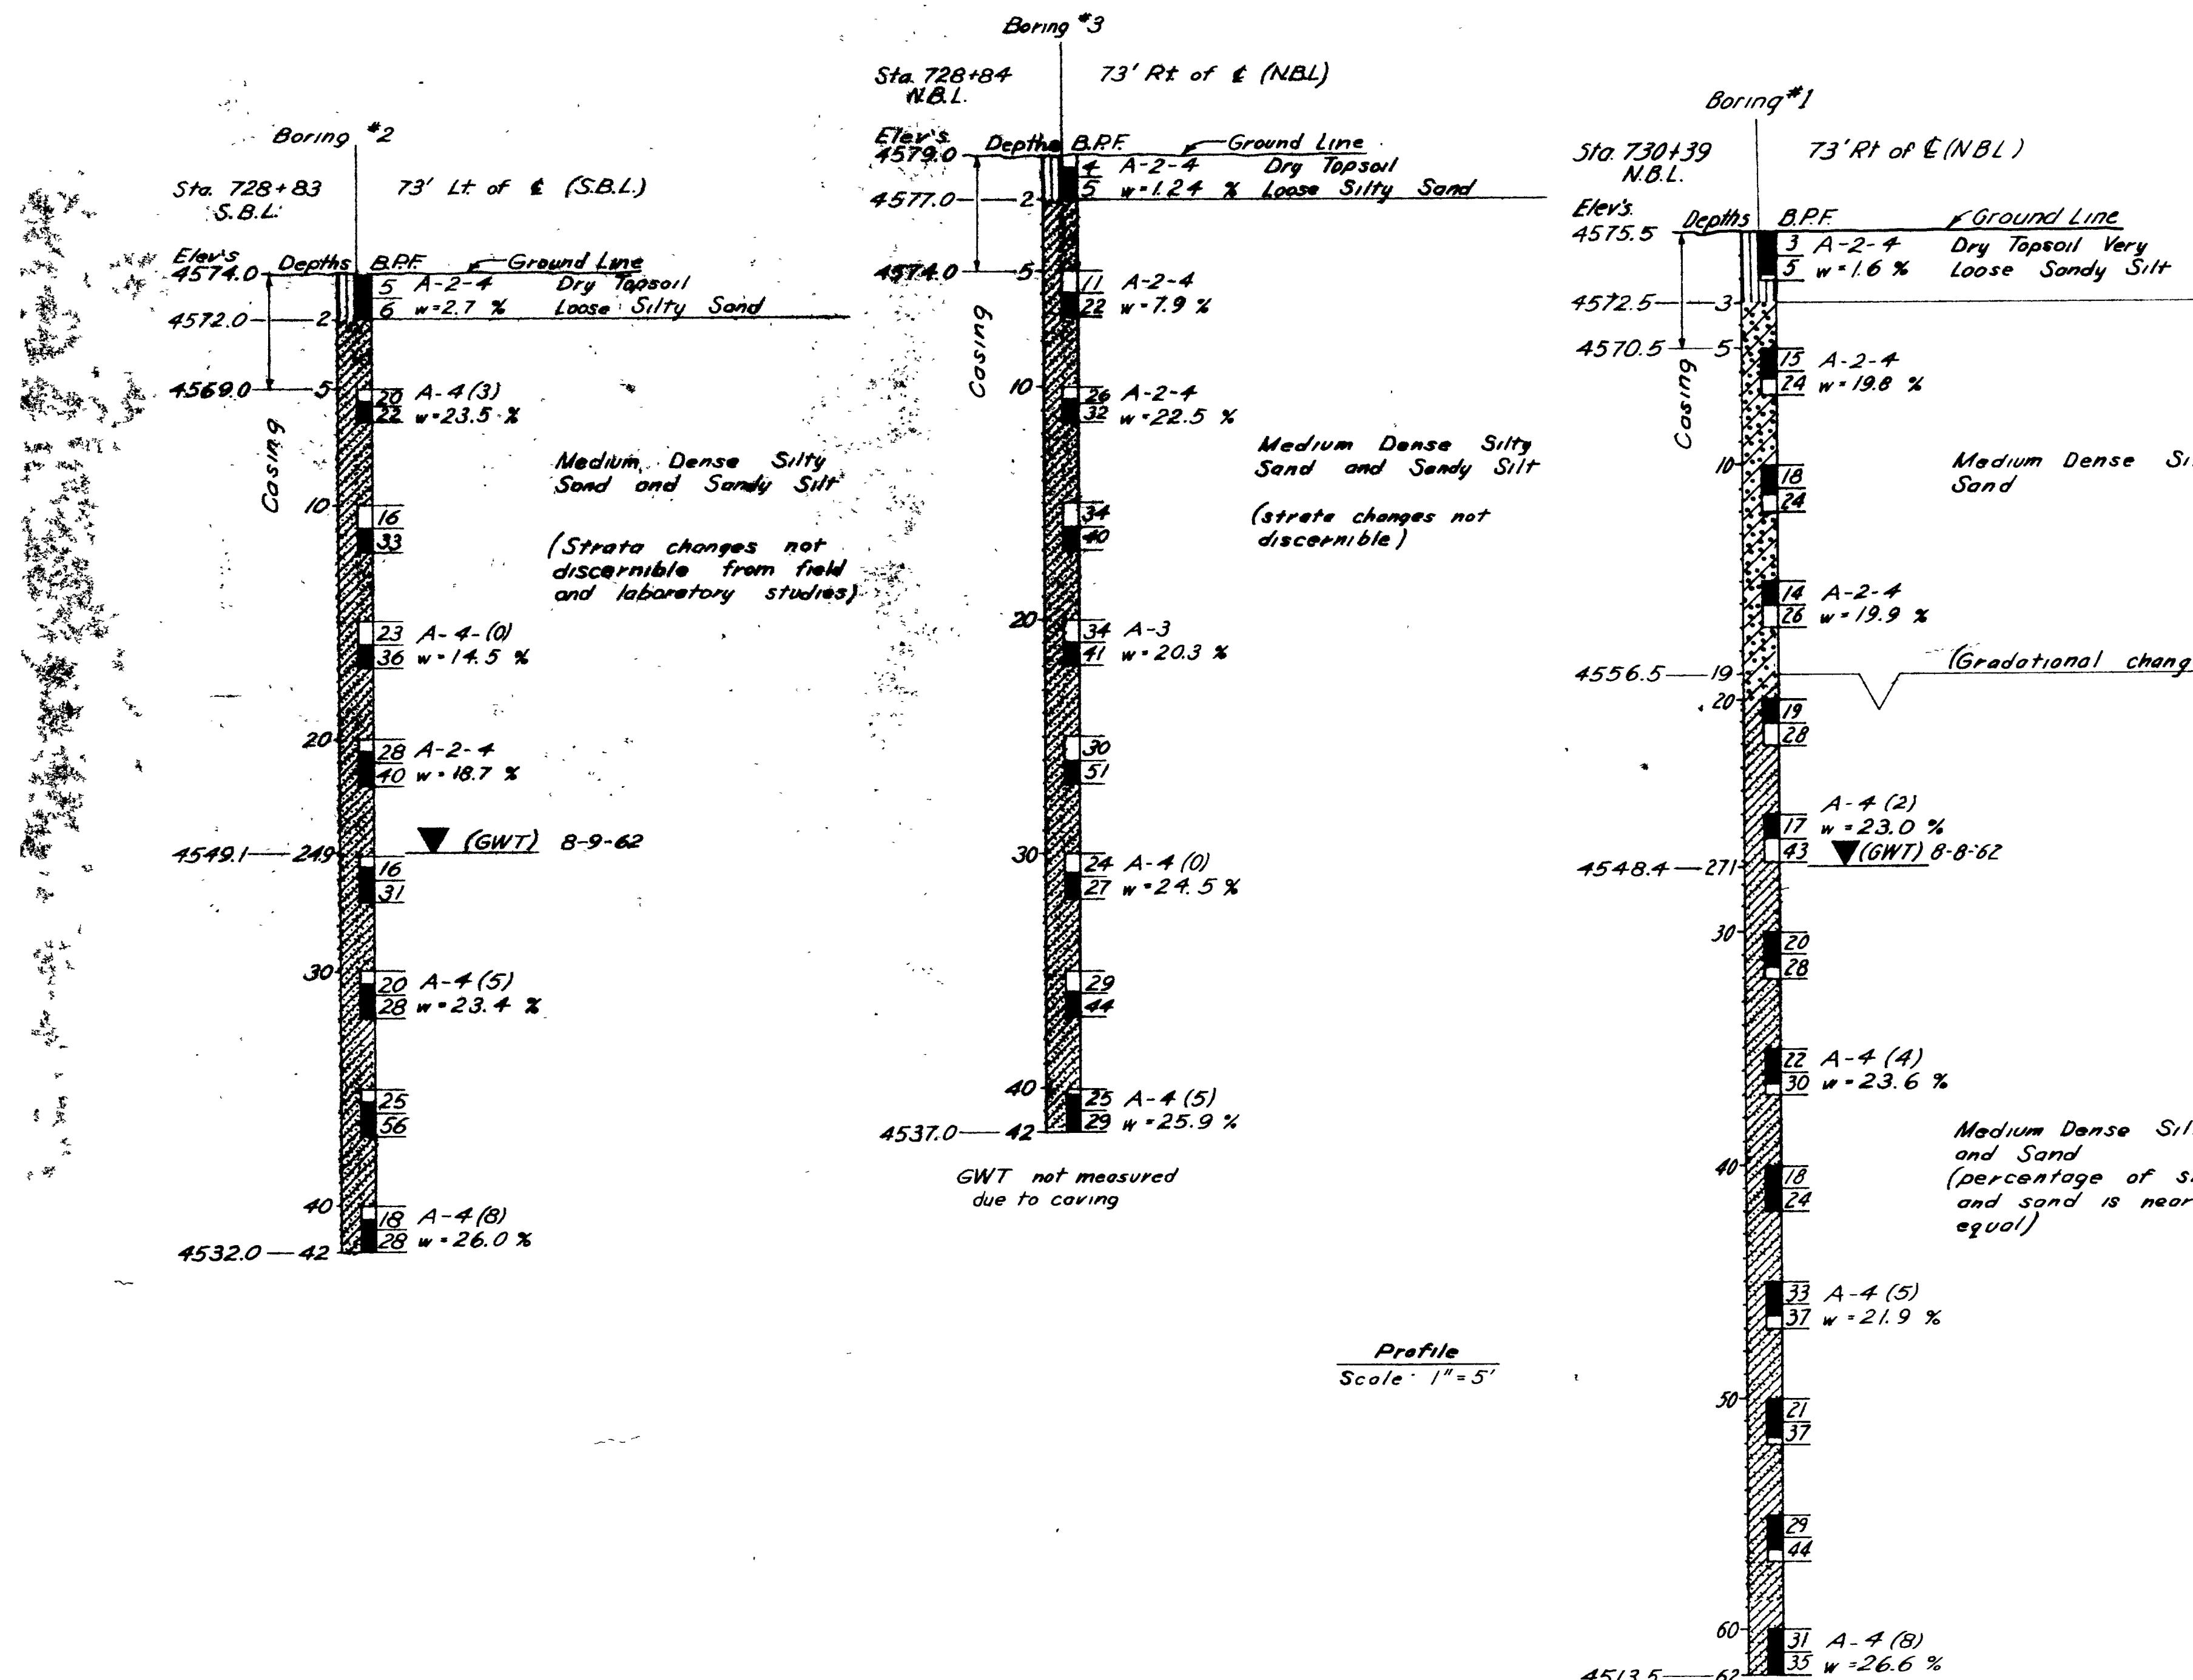


KEY TO BORING LOGS
RELATIVE DENSITY(SAND & SILT)

VERY LOOSE - LESS THAN 4 BLOWS PER FOOT
LOOSE - 4 TO 10 BLOWS PER FOOT
MEDIUM - 10 TO 30 BLOWS PER FOOT
DENSE - 30 TO 50 BLOWS PER FOOT
VERY DENSE - MORE THAN 50 BLOWS PER FOOT

CONSISTENCY(CLAY)

VERY SOFT - LESS THAN 2 BLOWS PER FOOT
SOFT - 2 TO 4 BLOWS PER FOOT
MEDIUM - 4 TO 8 BLOWS PER FOOT
STIFF - 8 TO 15 BLOWS PER FOOT
VERY STIFF 15 TO 30 BLOWS PER FOOT.
HARD - MORE THAN 30 BLOWS PER FOOT.

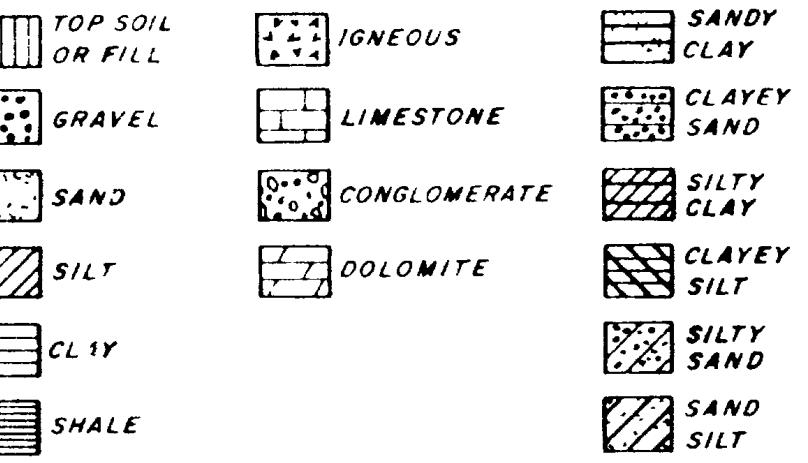

BORING (TEST HOLES) NO.
STATION 0+00 E OR LT OR RT IN FT. OFFSET.


GROUND ELEVATION	DEPTHS	GR EL 4562 FT.	EXAMPLE TYPICAL	
			STIFF	MEDIUM PLASTIC
4555	5	2	BRN CLAY, SOME SILT	A-6 (8) W = 9 %
4552	7	5	THIN WALL SHELBY TUBE UNDISTURBED SAMPLER USED.	
4546	10	10	SPLIT BARREL UNDISTURBED SAMPLER WITH LINER RINGS OR CALIFORNIA TYPE SAMPLER	
4541	14	14		
4531	30	30	REASON NOT RECOVERED	
			CLASSIFICATION OF EACH SAMPLE AND RESULTS OF CLASSIFICATION TESTS.	

ABBREVIATIONS


LL - LIQUID LIMIT IN %
PI - PLASTIC INDEX %
W.M. - NATURAL MOISTURE CONTENT IN %
W.G. - WELL GRADED
PEN - PENETRATION
GWT - GROUND WATER TABLE
B.P.F - BLOWS PER FOOT.

UTAH STATE DEPARTMENT OF HIGHWAYS
SALT LAKE CITY, UTAH
STRUCTURES DIVISION
HILLFIELD INTERCHANGE TO DAVIS-WEBER CO LINE
HILL FIELD RD INTERCH 0-PASS
SOIL DATA

DESIGNED BY MW	CHECKED BY MJC	I-15-7(58)332
DRAWN BY PAULSON	CHECKED BY	PROJECT NUMBER
QUANTITIES BY	CHECKED BY	72946272 I-15
APPROVAL RECOMMENDED BY M. J. Christensen	GR. EN. LEADER	STATION
APPROVED Aug 27 1963	L. L. WILSON	DAVIS COUNTY
NO. BY DATE	REMARKS	
REVISIONS		
BR NO	DRG NO	3 of 13

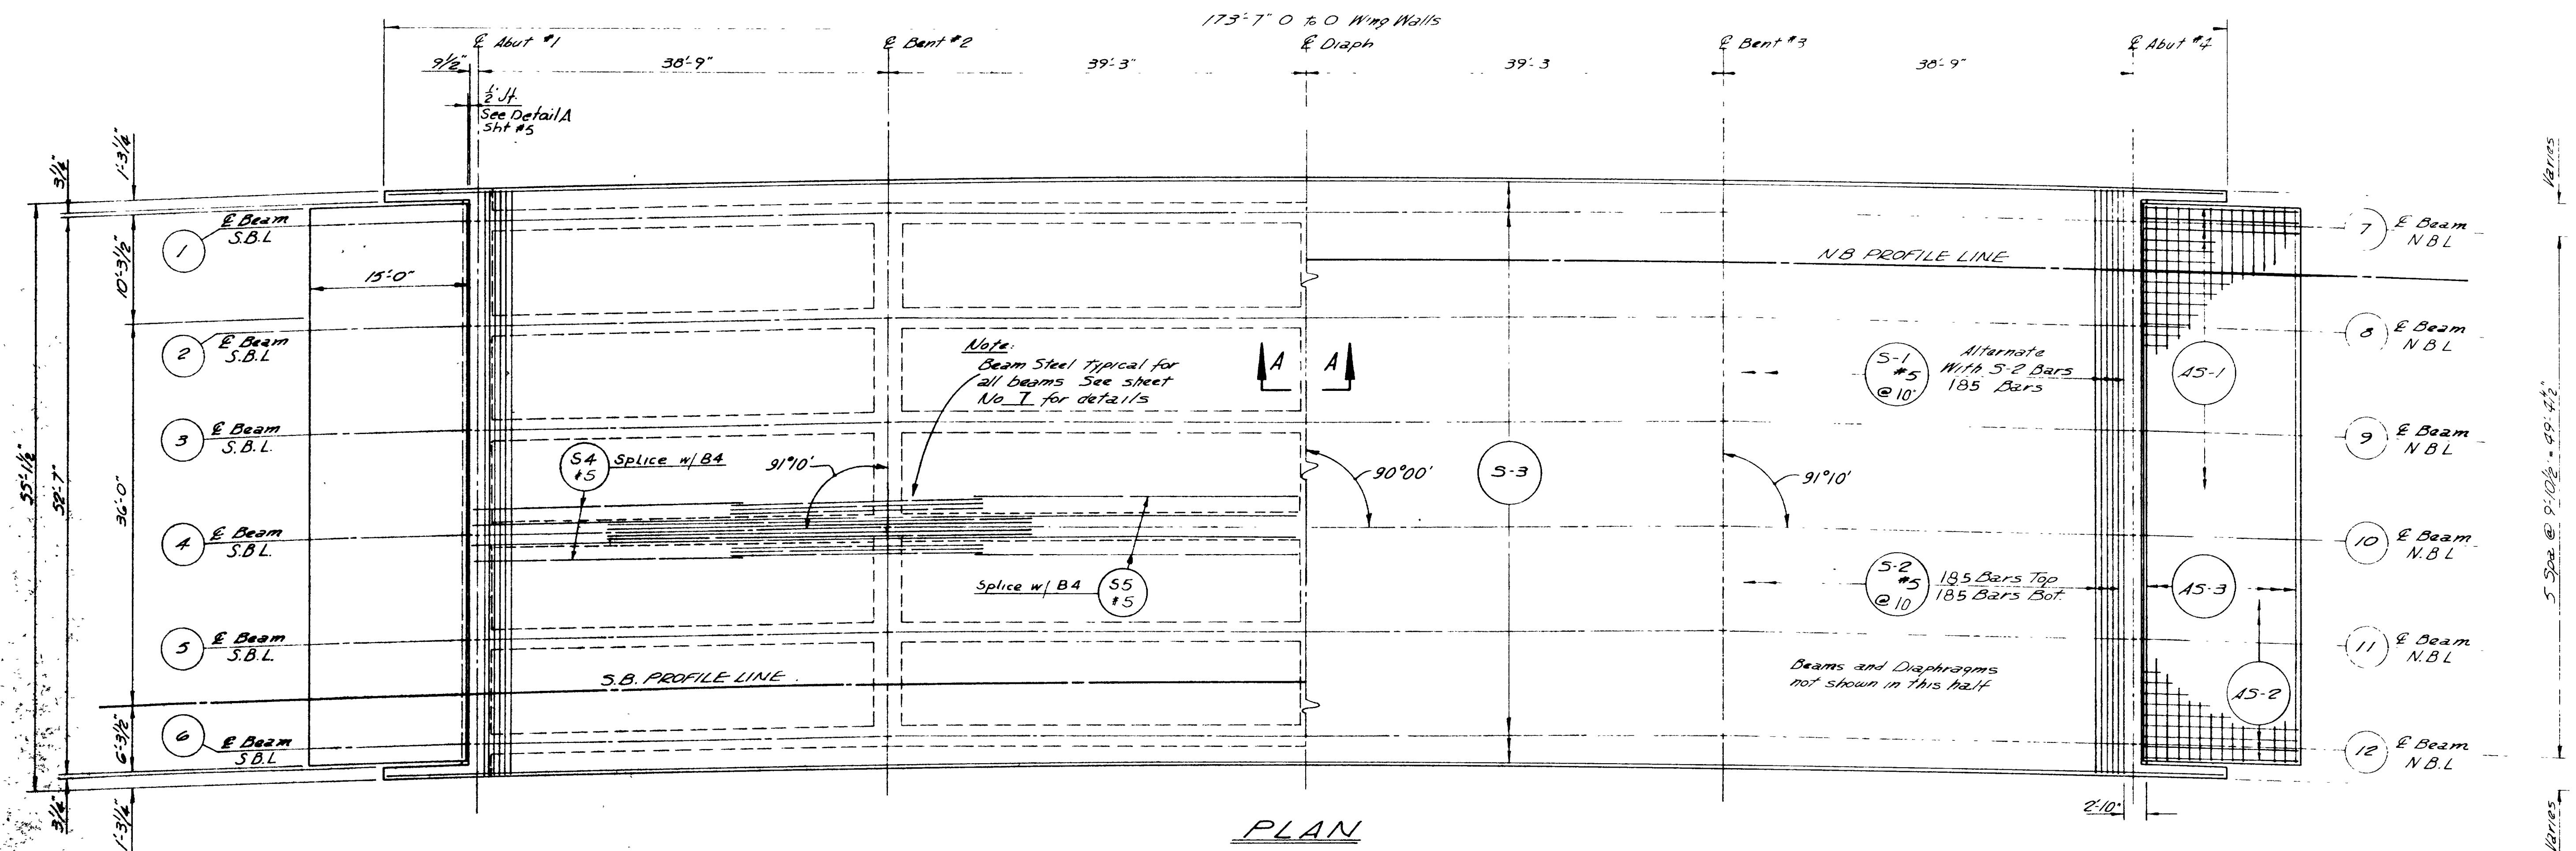

PLAN

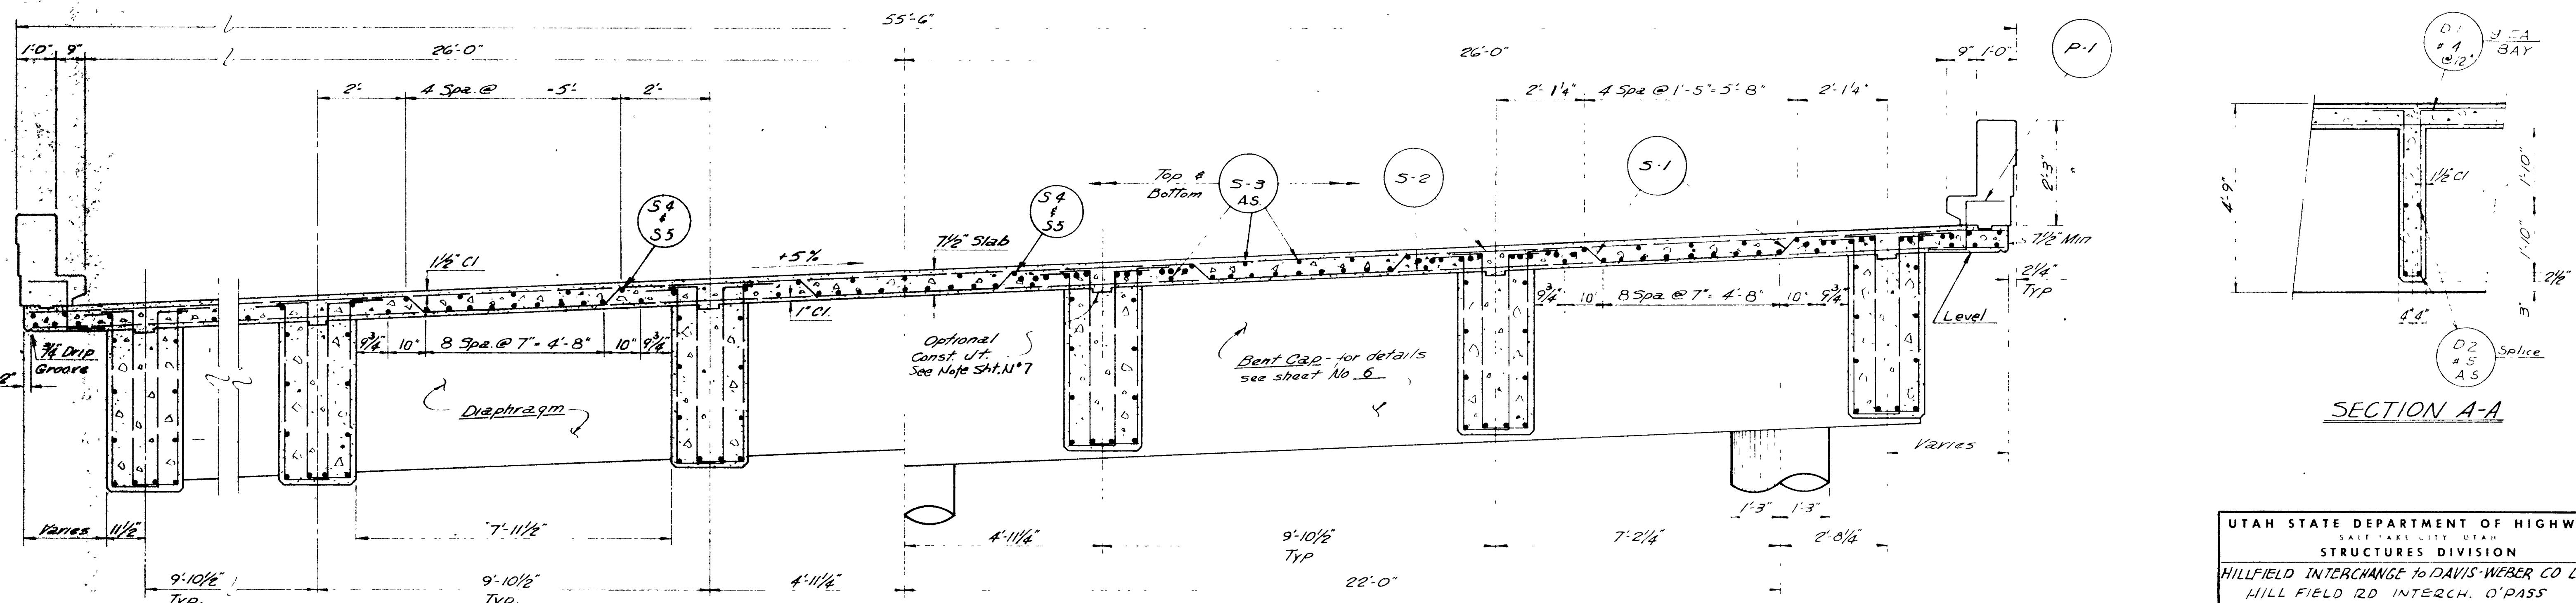


IN SPAN


DECK SECTION

AT BENTS


UTAH STATE DEPARTMENT OF HIGHWAYS			
SALT LAKE CITY UTAH			
STRUCTURES DIVISION			
HILLFIELD INTERCHANGE to DAVIS-WEBER CO LINE			
HILL FIELD RD INTERCH. O'PASS			
DECK PLAN & SECTION			
DESIGNED BY	MW	CHECKED BY	M J C
DRAWN BY	A E F	CHECKED BY	H J S
QUANTITIES BY	H J S	CHECKED BY	B M W
APPROVAL RECOMMENDED BY	<i>Mary Christiansen</i>	APR 19 1962 TYPED FEE PAID HILL FIELD RD	PROJECT NUMBER 729-6272 STATION DAVIS COUNTY
APPROVED <i>Aug 27 1962</i> J A L			
BR NO	DRG IN	D-719	4 OF 13

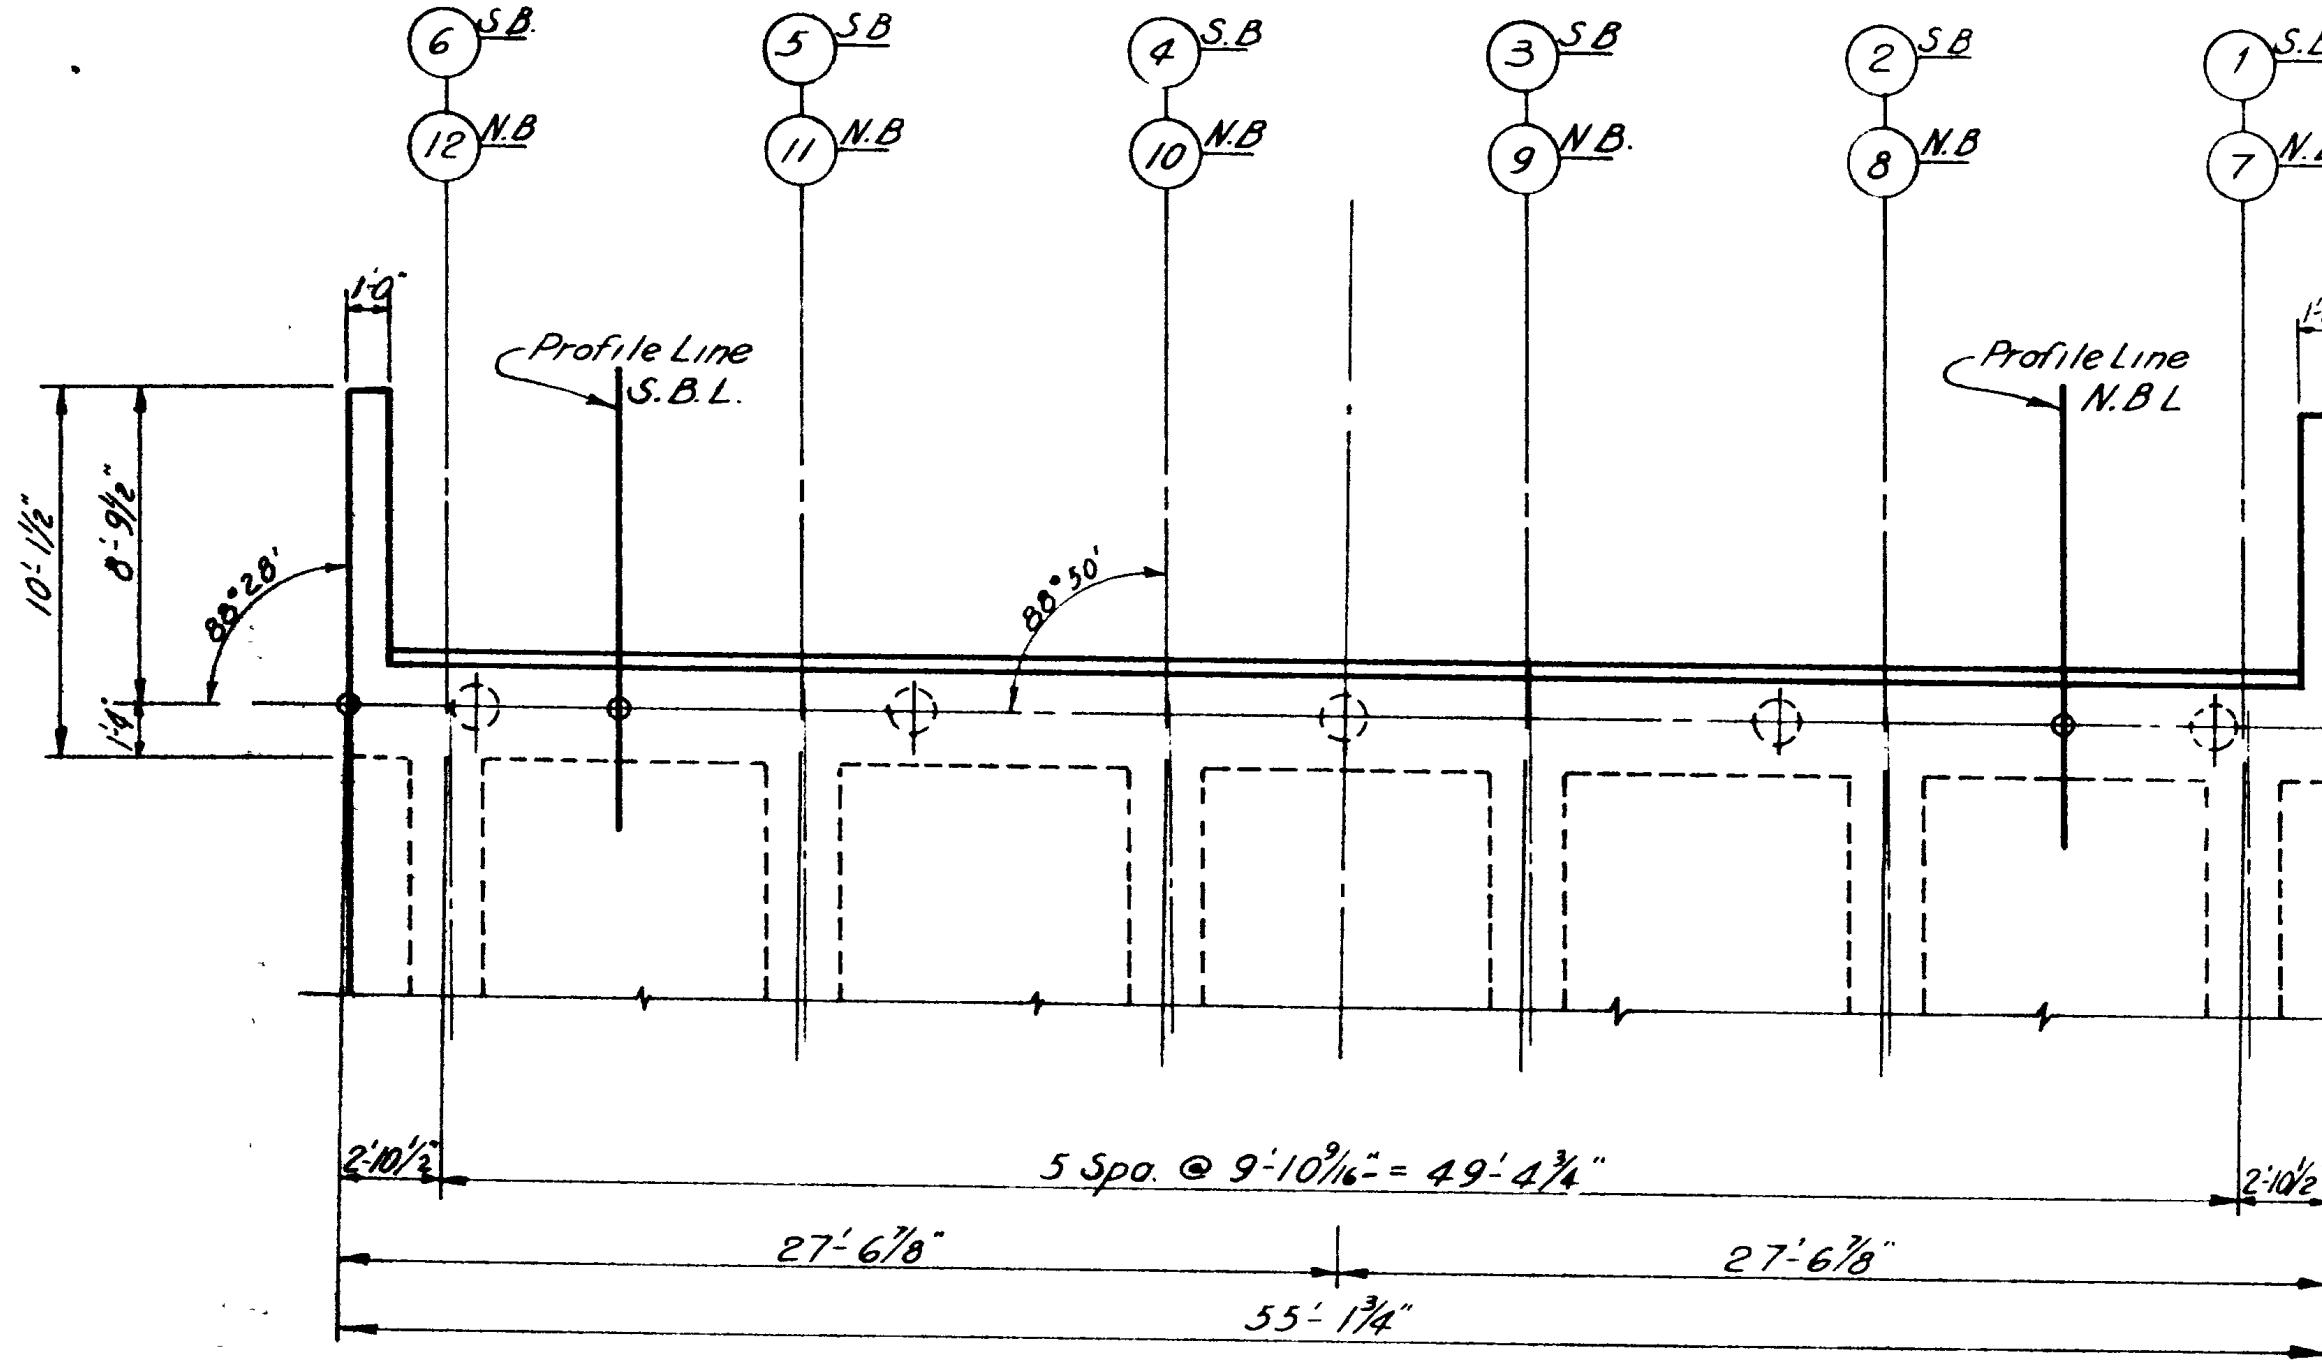


ABUTMENT No. 1
South Bound & North Bound Lane
Dimensions Abutment No. 4 Typico

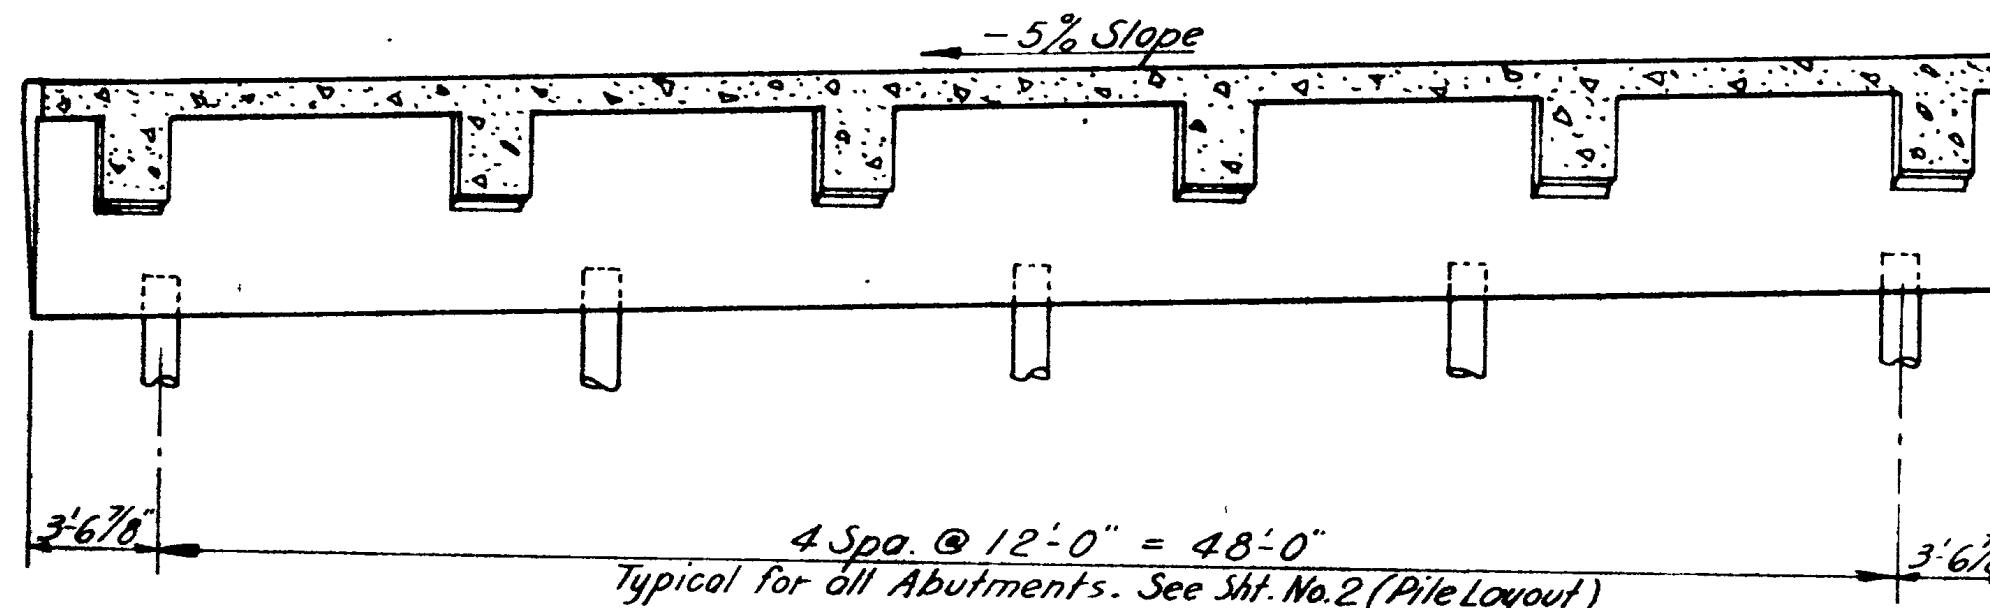

ELEVATION ABUTMENT NO.

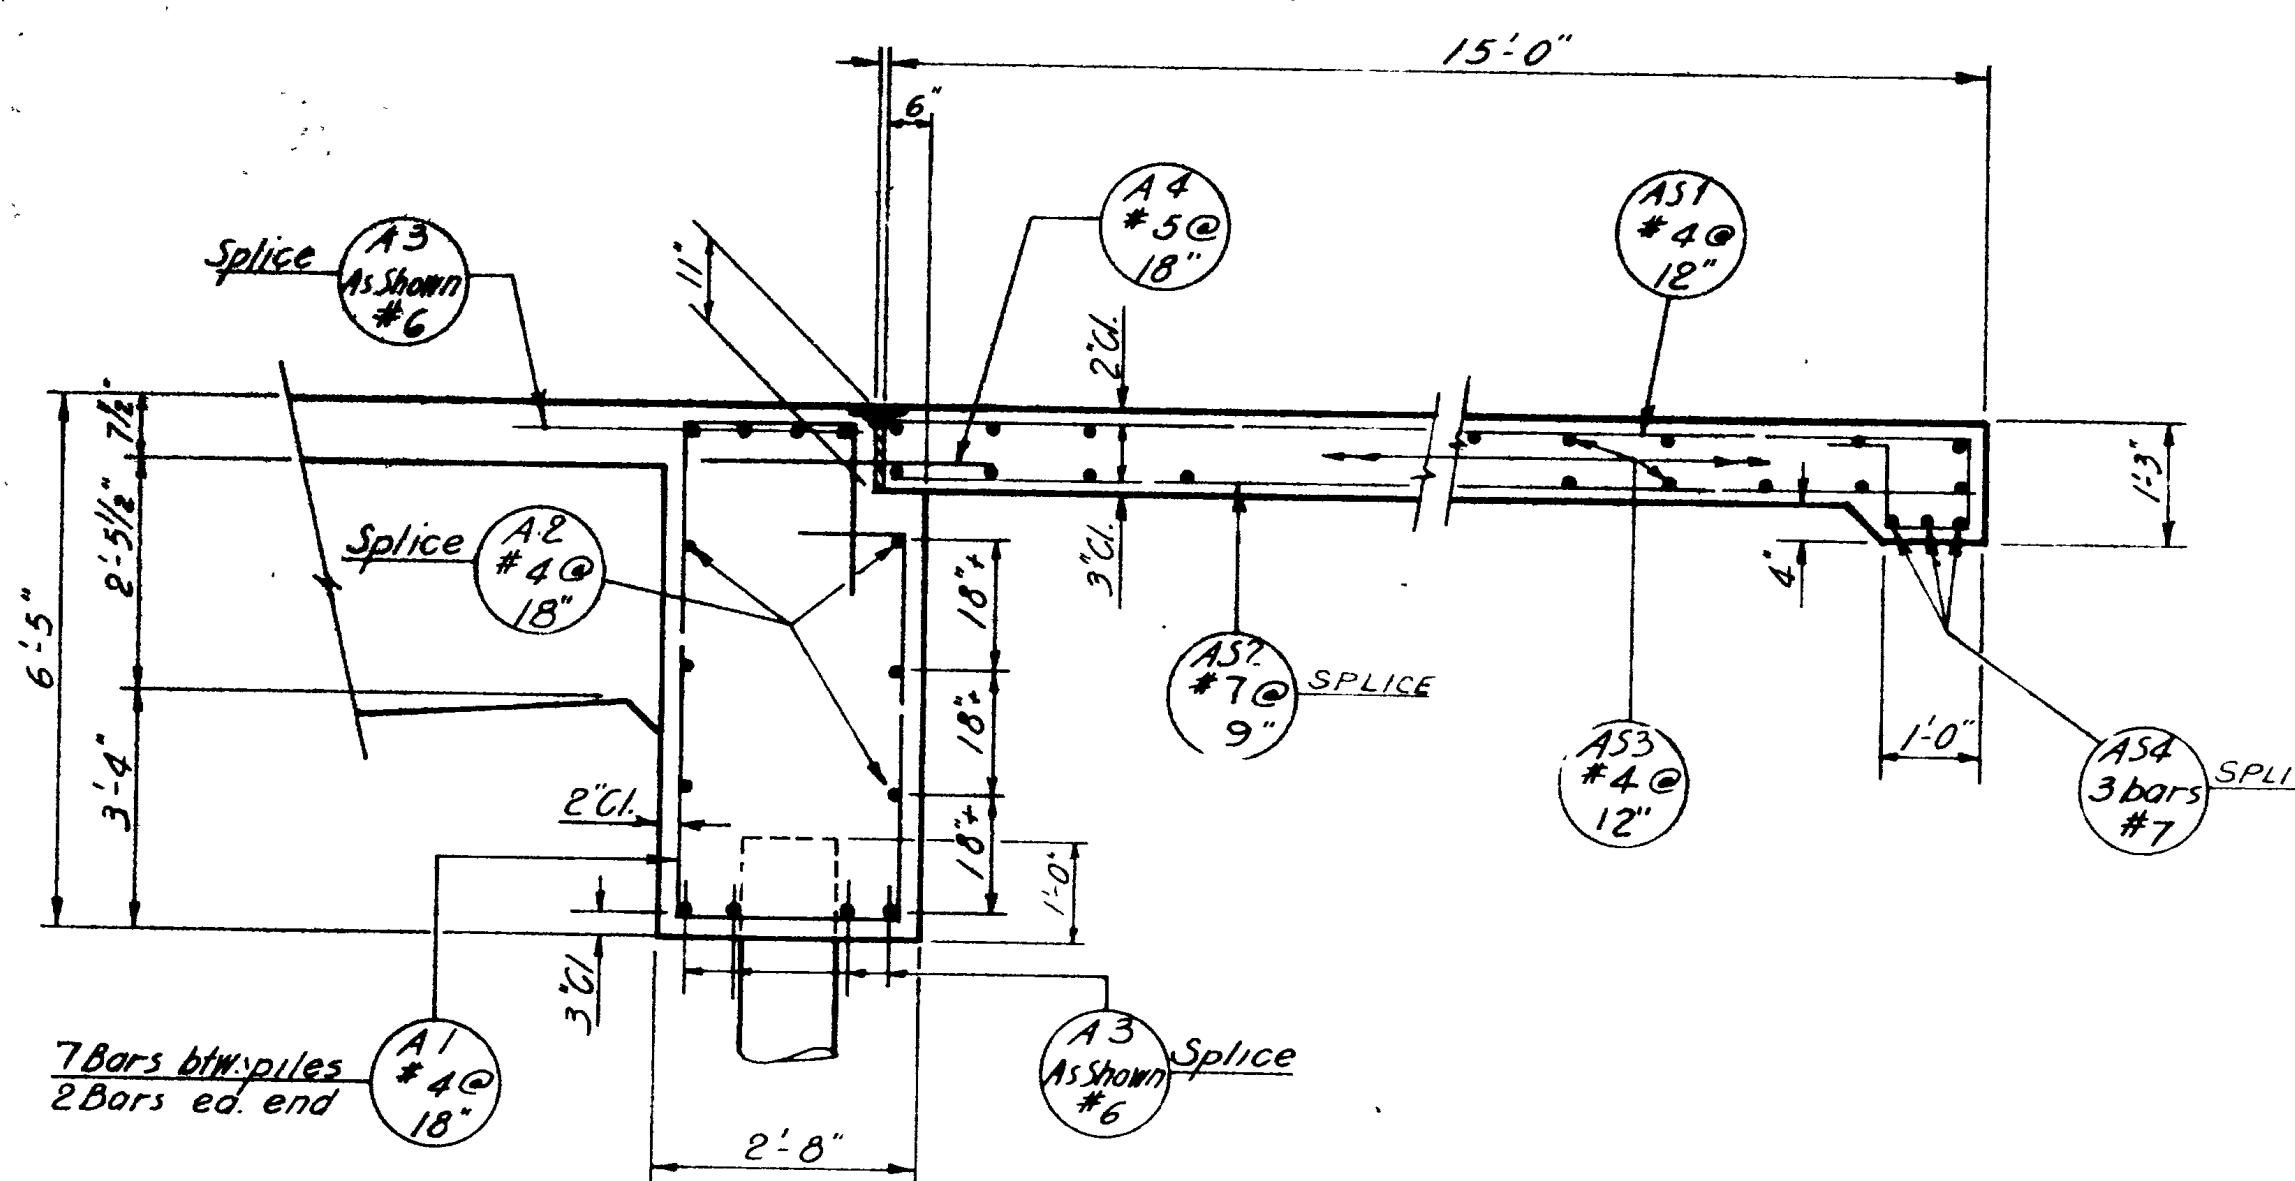


ABUTMENT BACKWALL & APPROACH SLAB

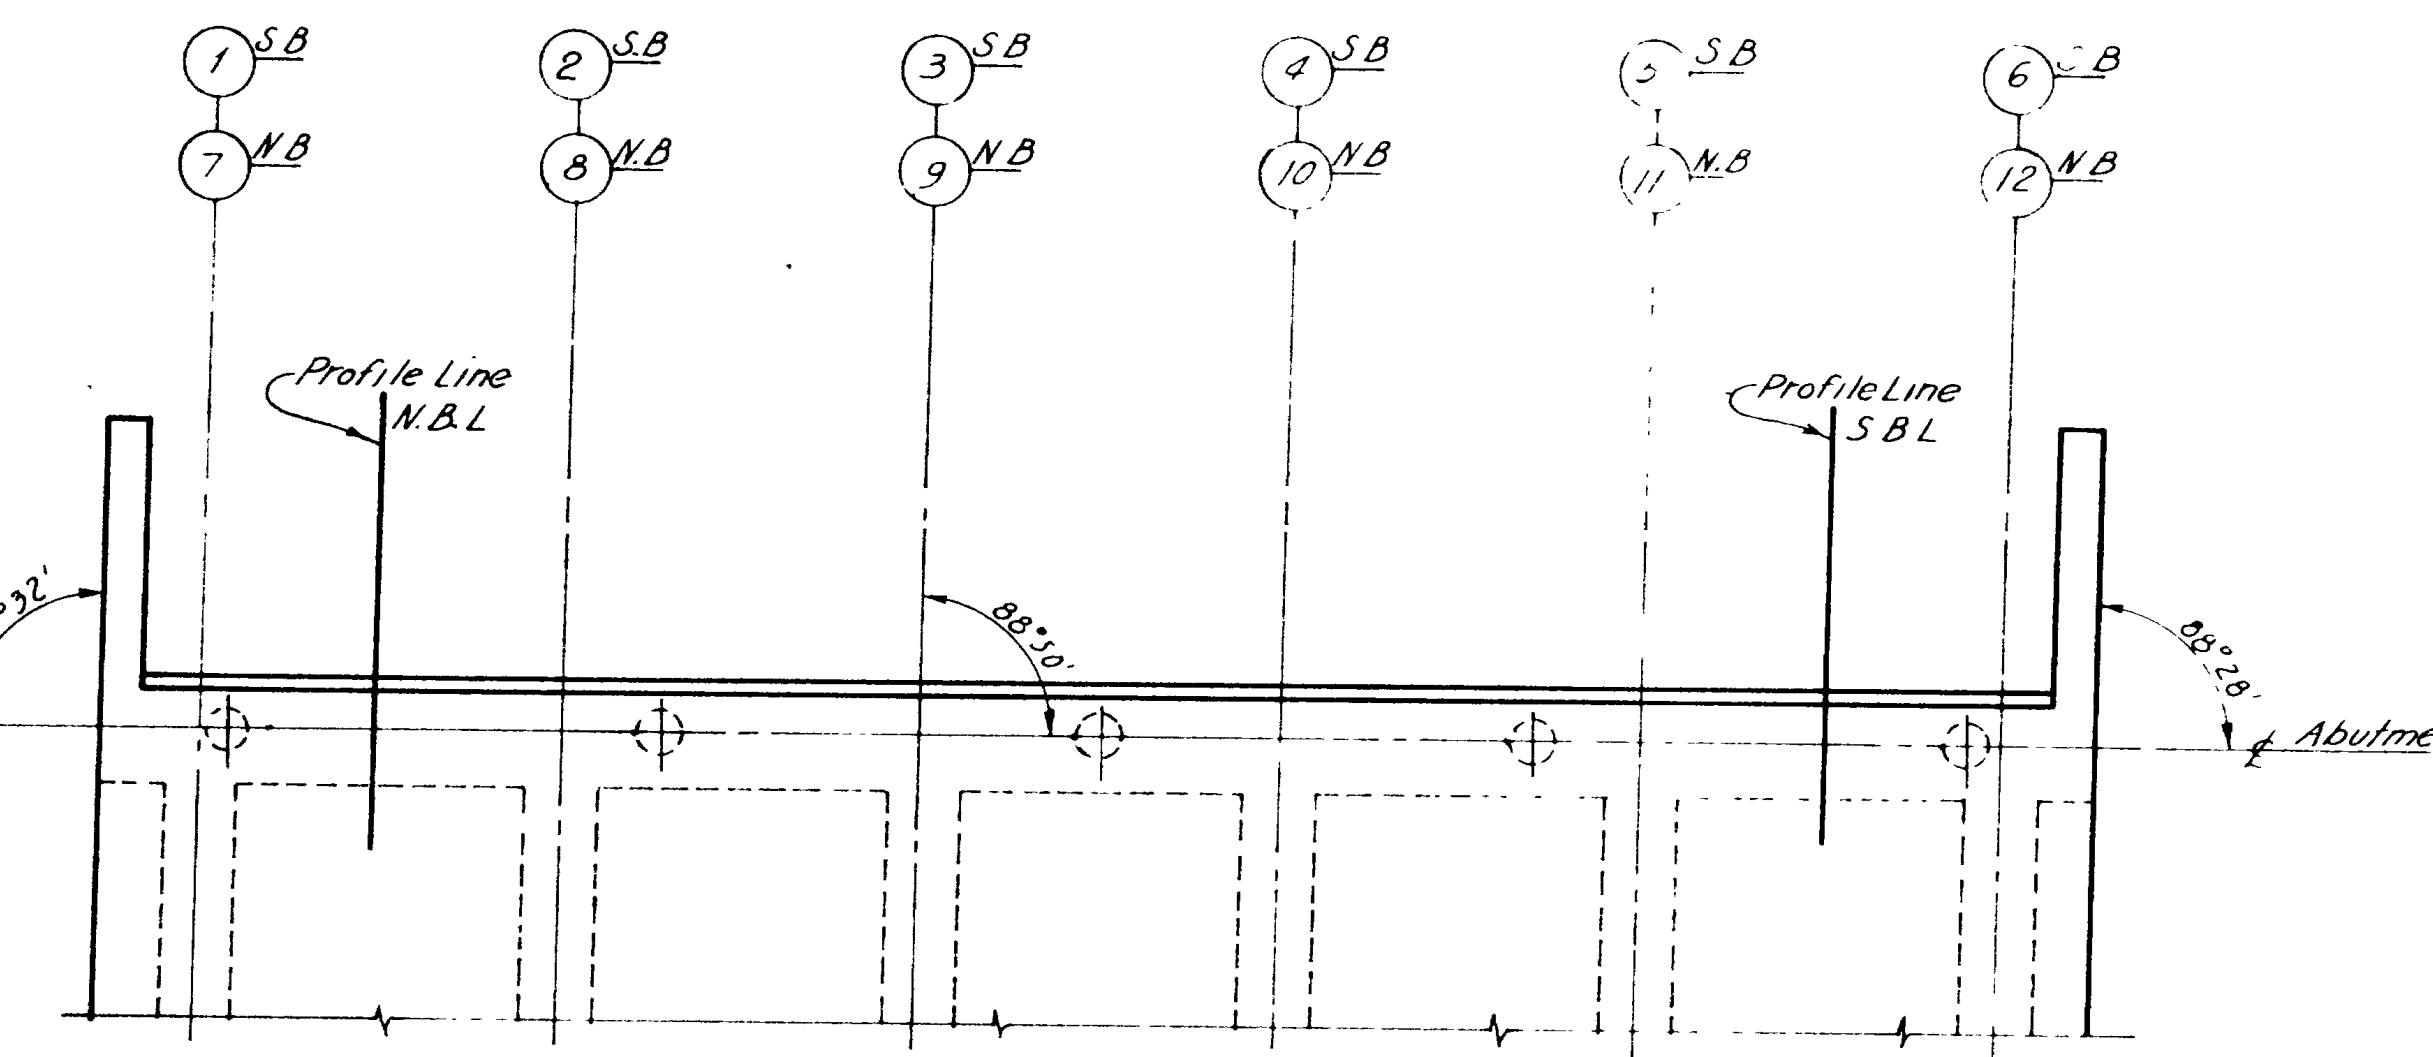

ABUTMENT No. 4
South Bound & North Bound Lane
Dimensions Abutment No 1 Typical

LIMITS OF ANGLES AT JOINTS

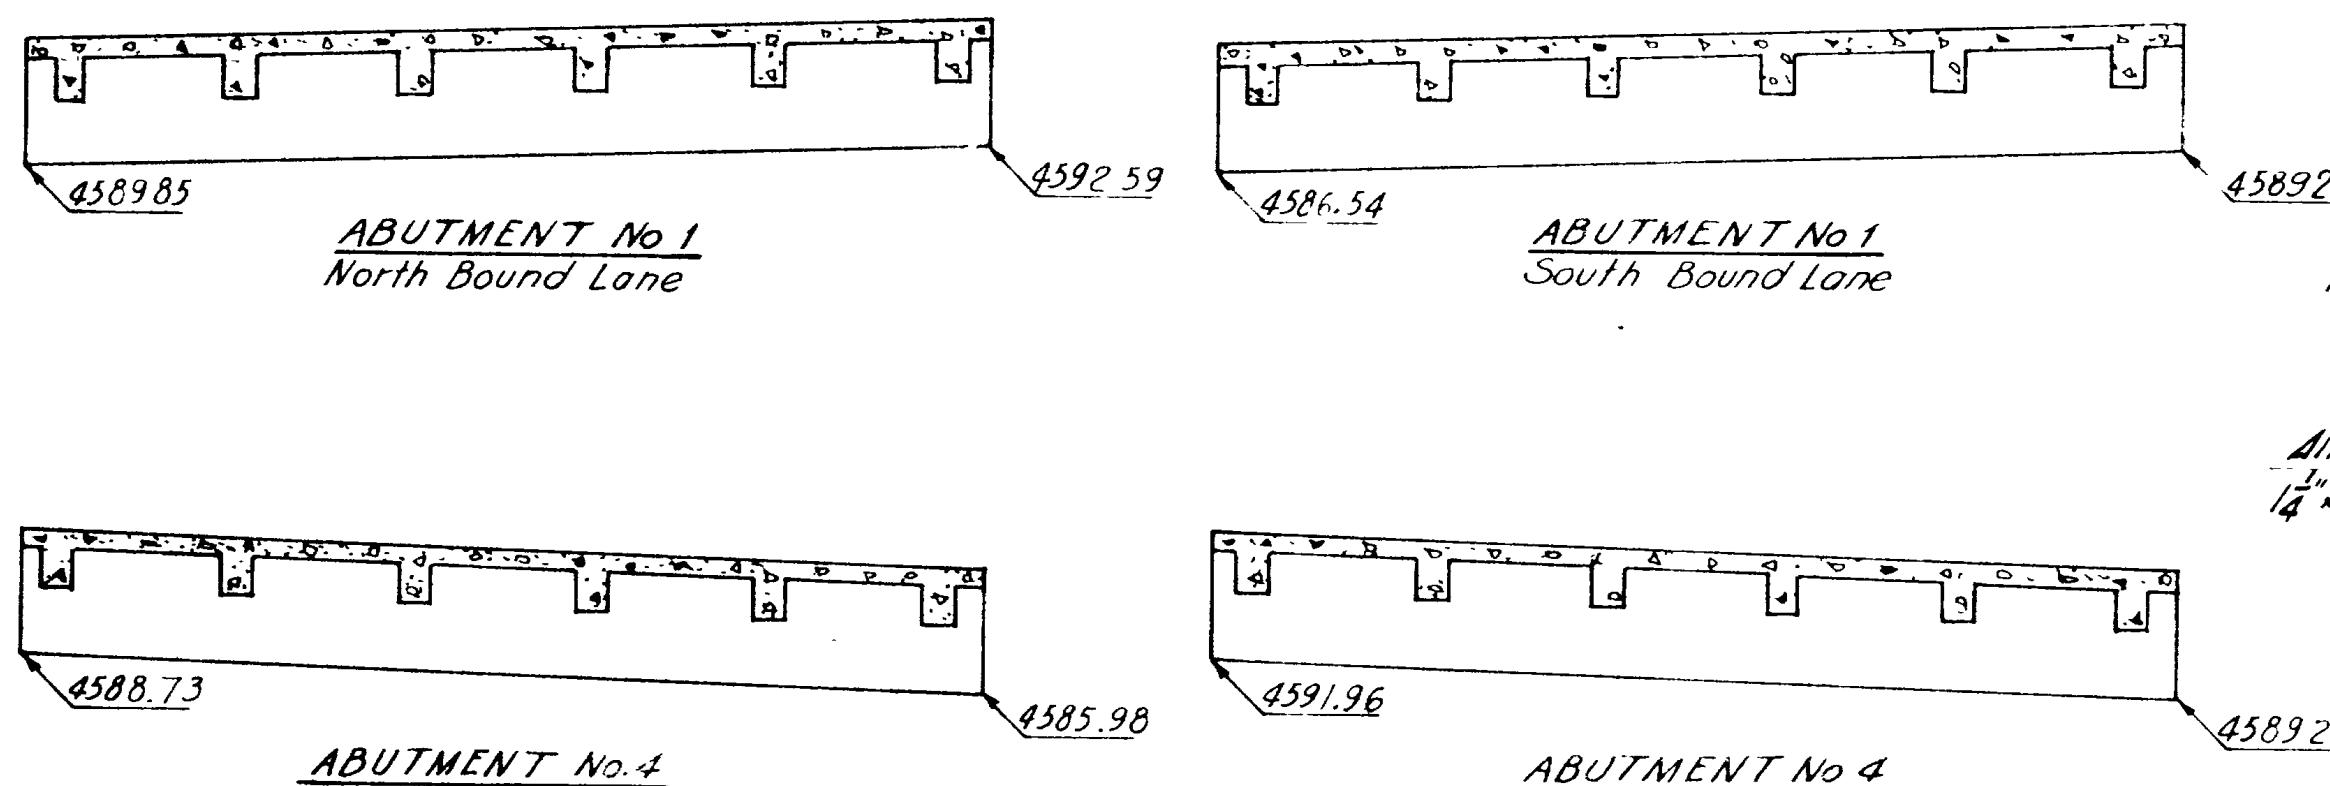


ABUTMENT No. 4
South Bound Lane

SCHEMATIC ELEV. OF ABUTMENTS

SCHEMATIC ELEV. OF ABUTMENTS



Note:

1. Stud or Strap Anchors are Acceptable.
 2. Payment for Anchors shall be based upon weight of stud Anchors.
 3. Bolts and Plates shall be Removed when forms are Removed.

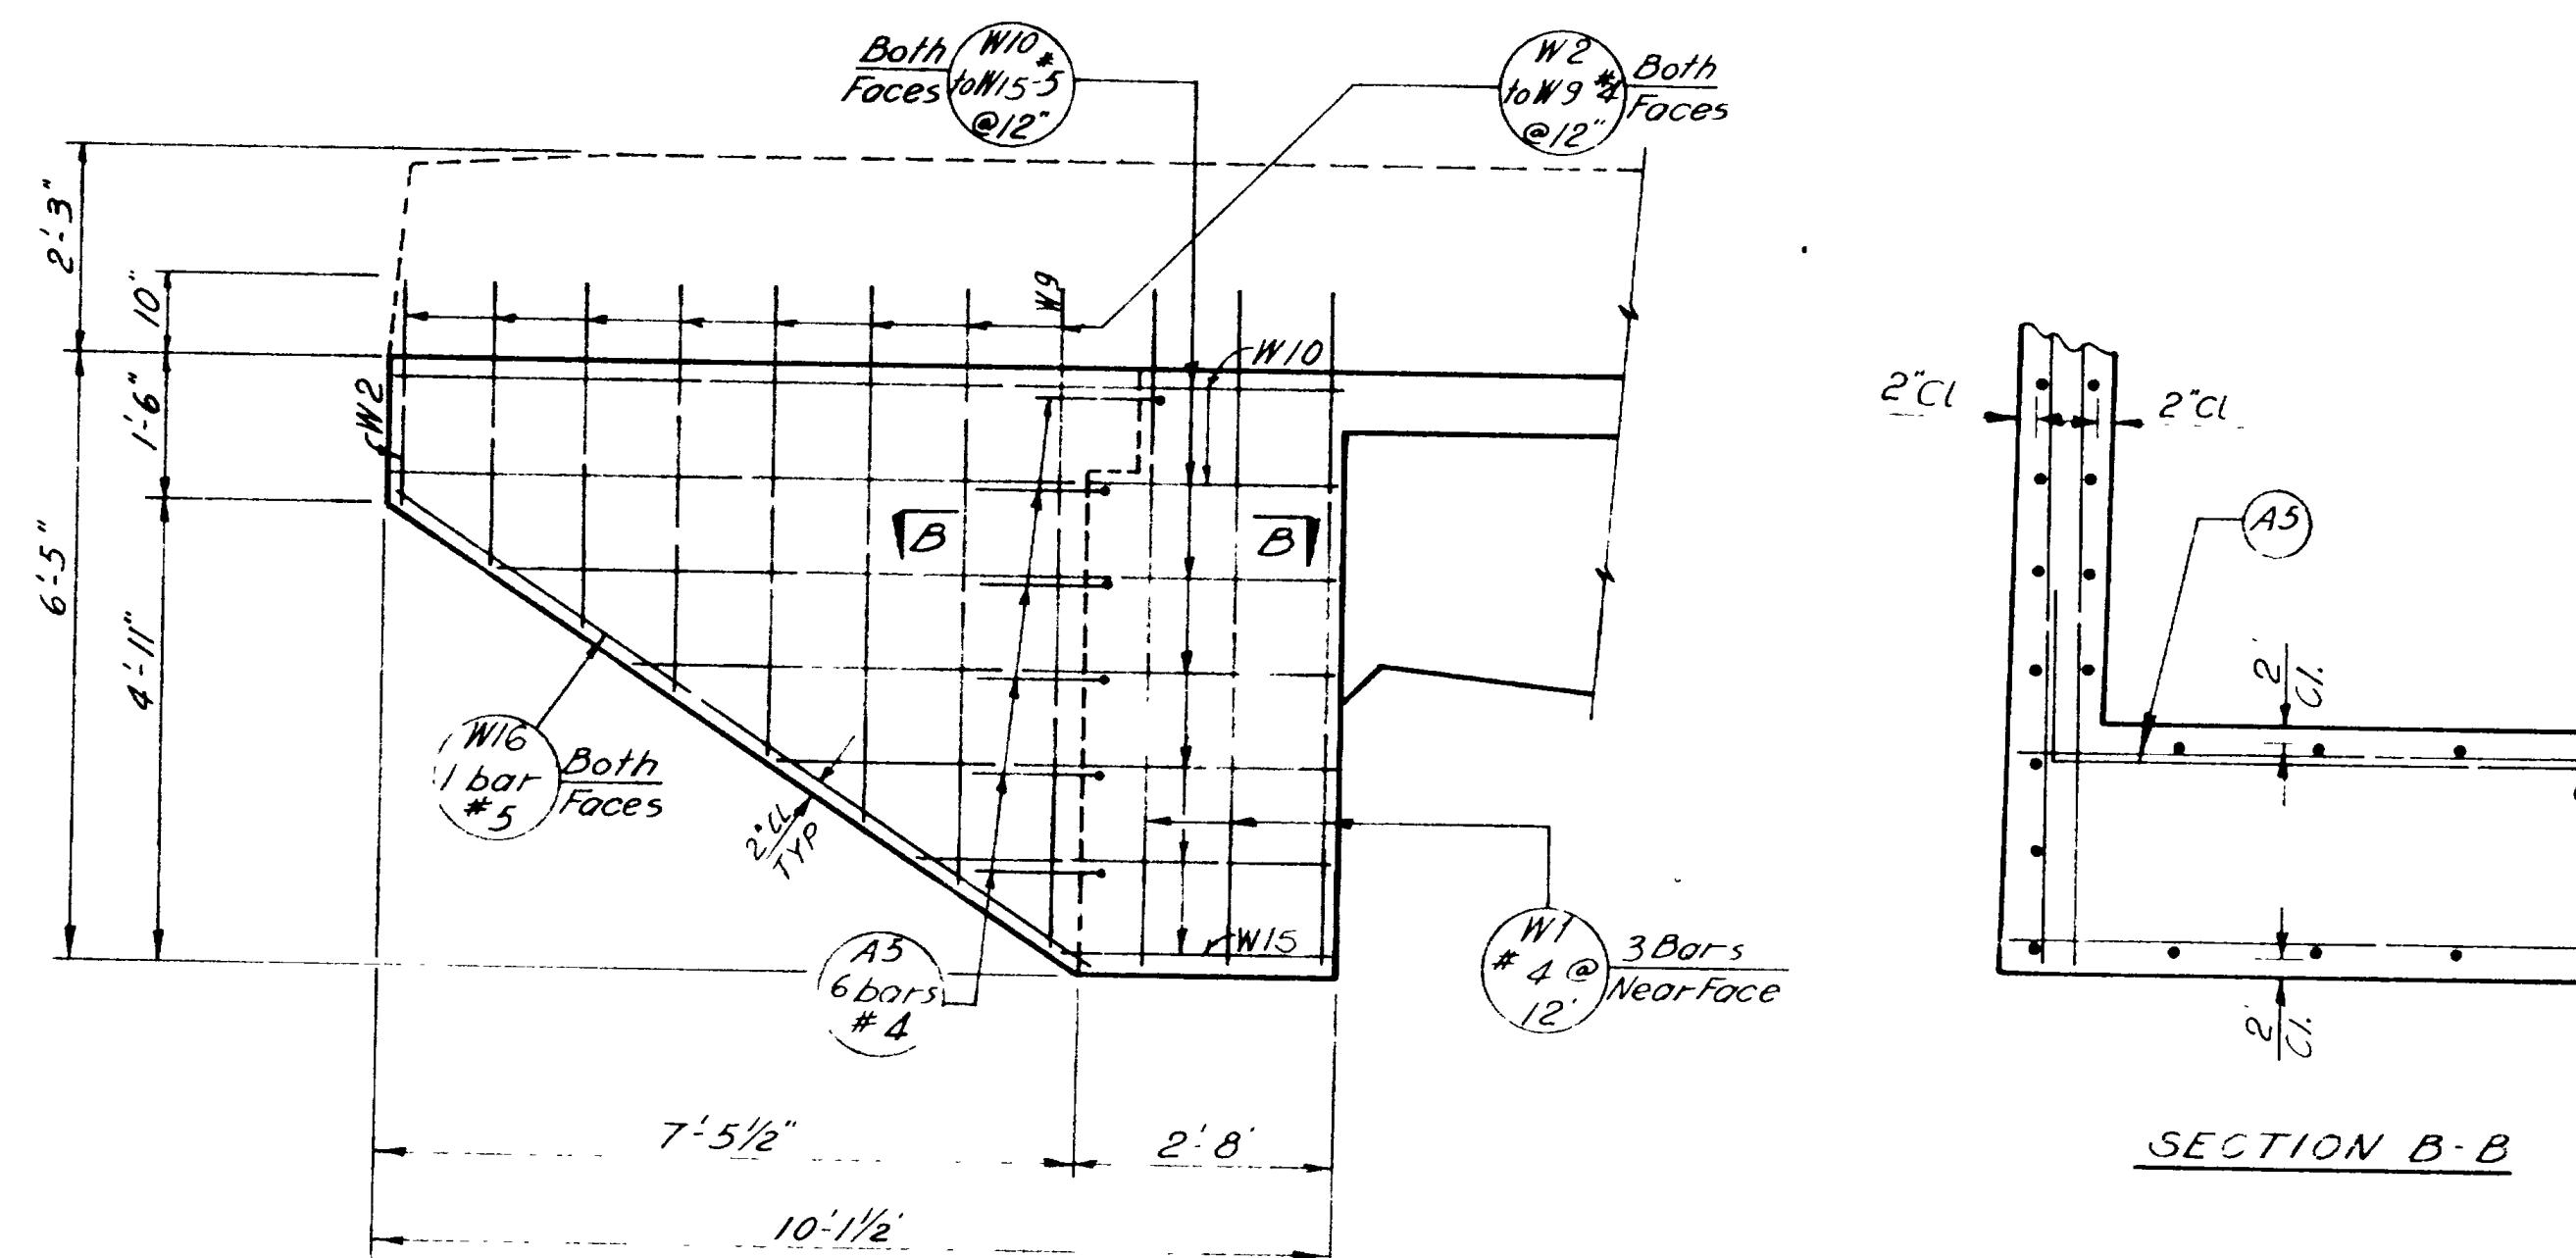


WING WALL ELEVATION

UTAH STATE DEPARTMENT OF HIGHWAYS			
SALT LAKE CITY TAB			
STRUCTURES DIVISION			
HILLFIELD INTERCHANGE TO DAVIS-WEBER CO LINE			
HILL FIELD ROAD INTERCHANGE O'PASS			
ABUTMENTS NO 1 & 4 - DETAILS			
DESIGNED BY	M. W.	LINE KEEPER	M J C
DRAWN BY	W. L. A.	HECKED BY	H J S
QUANT TIPS BY	H J S	HE KEEPER	BMW.
APPROVAL			
RECOMMENDED BY	<i>M. Jay Erickson</i>		
APPROVED			
BR NO		DRG NO	D-713
			5 OF 13



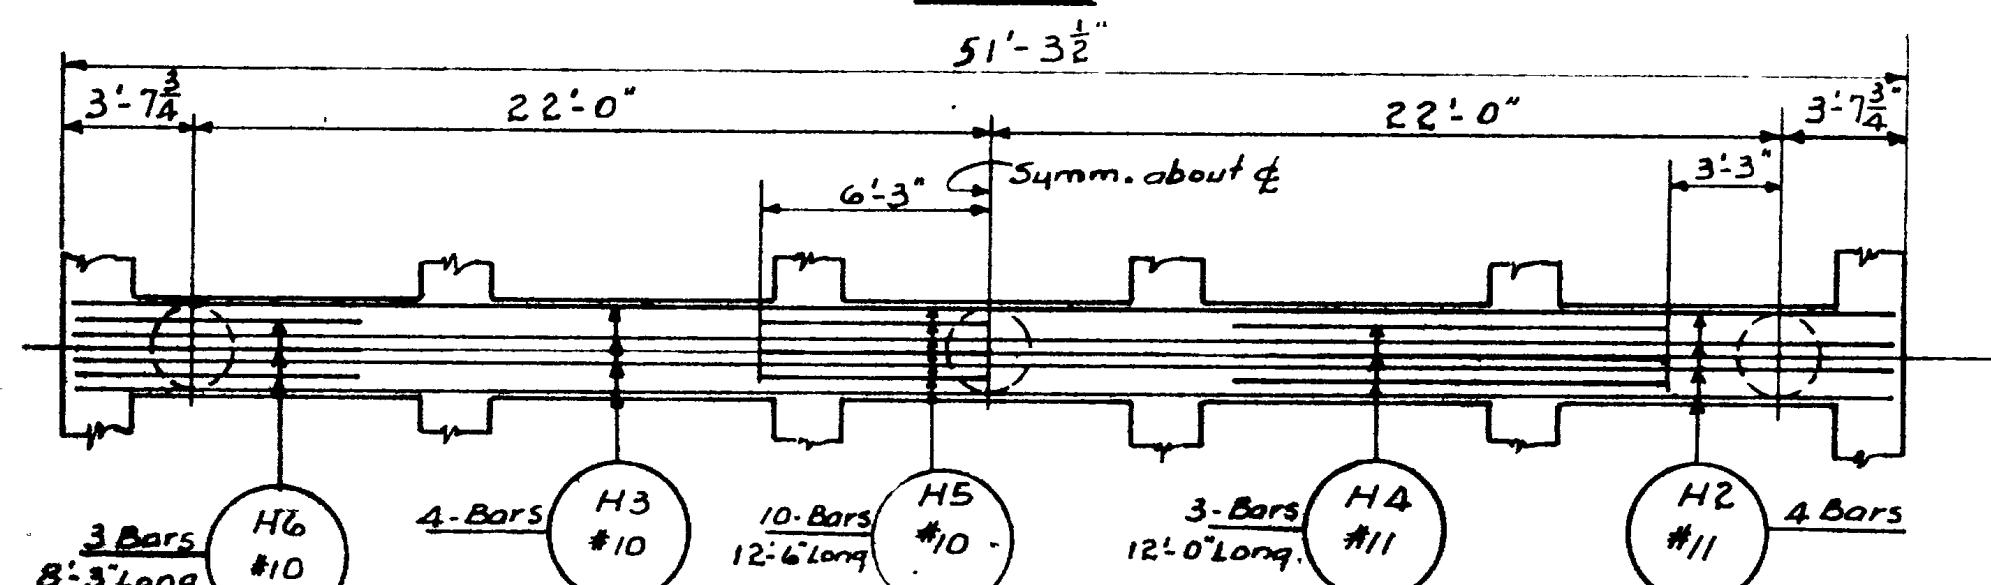
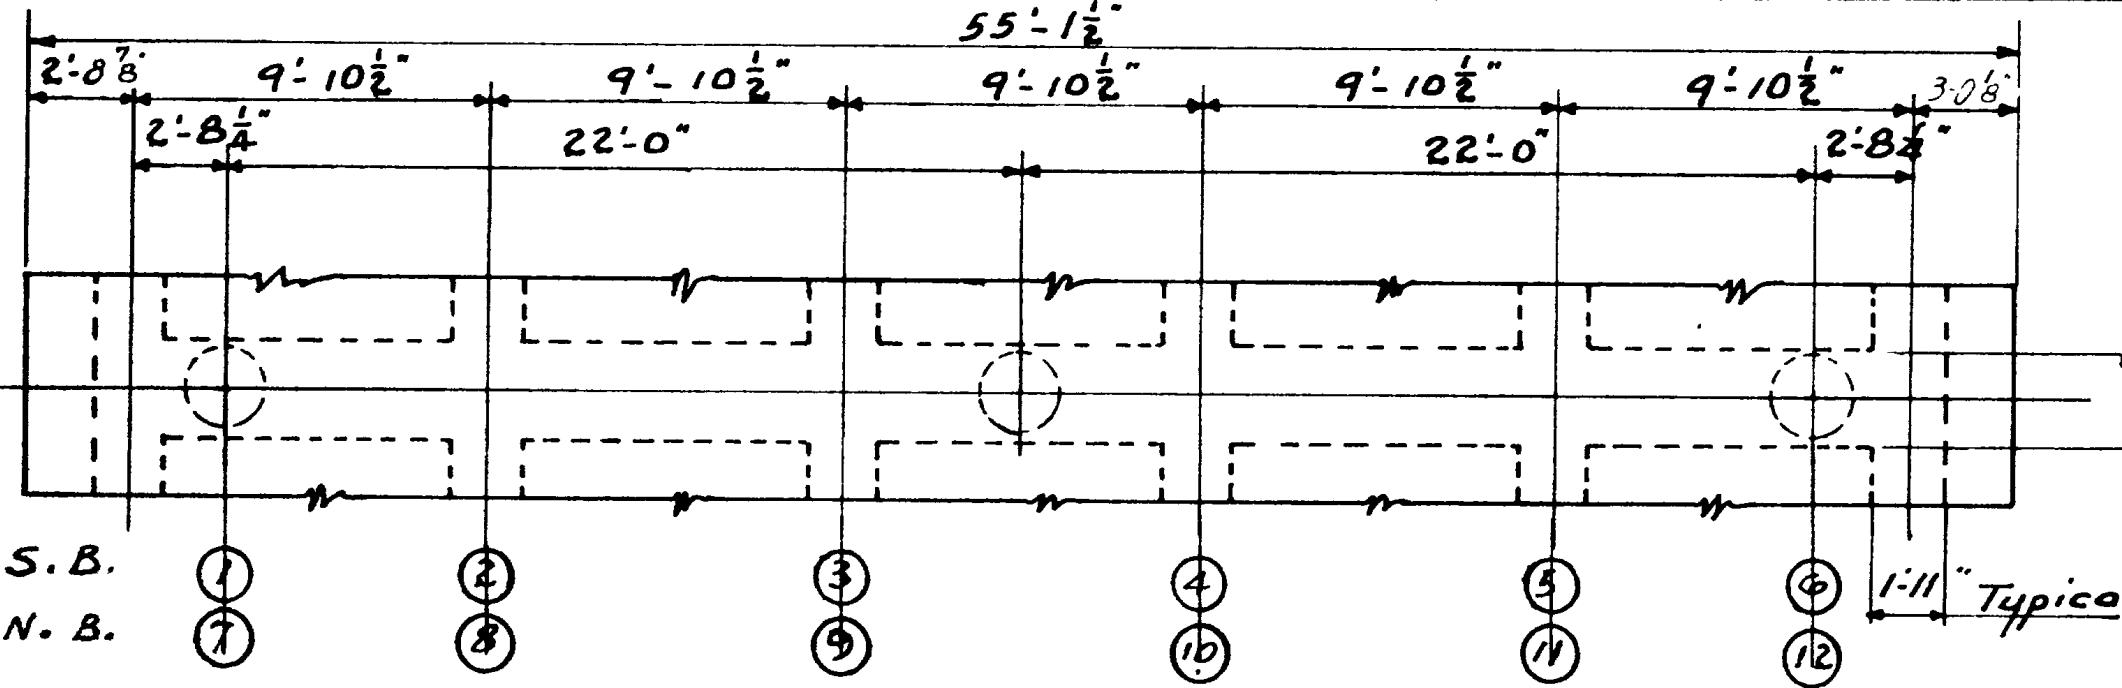


PLAN OF CAP STEEL

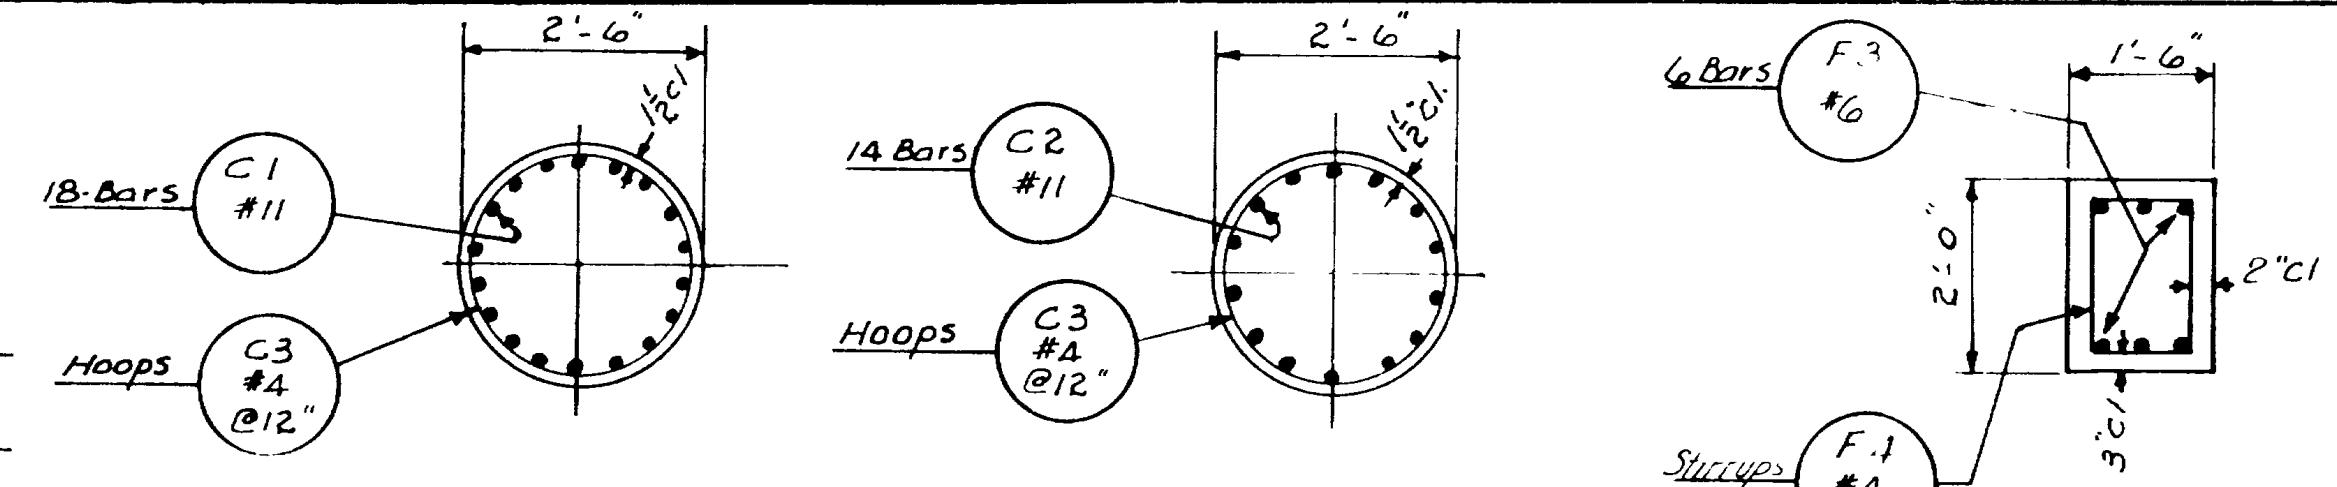


SECTION B-B

SECTION D-D

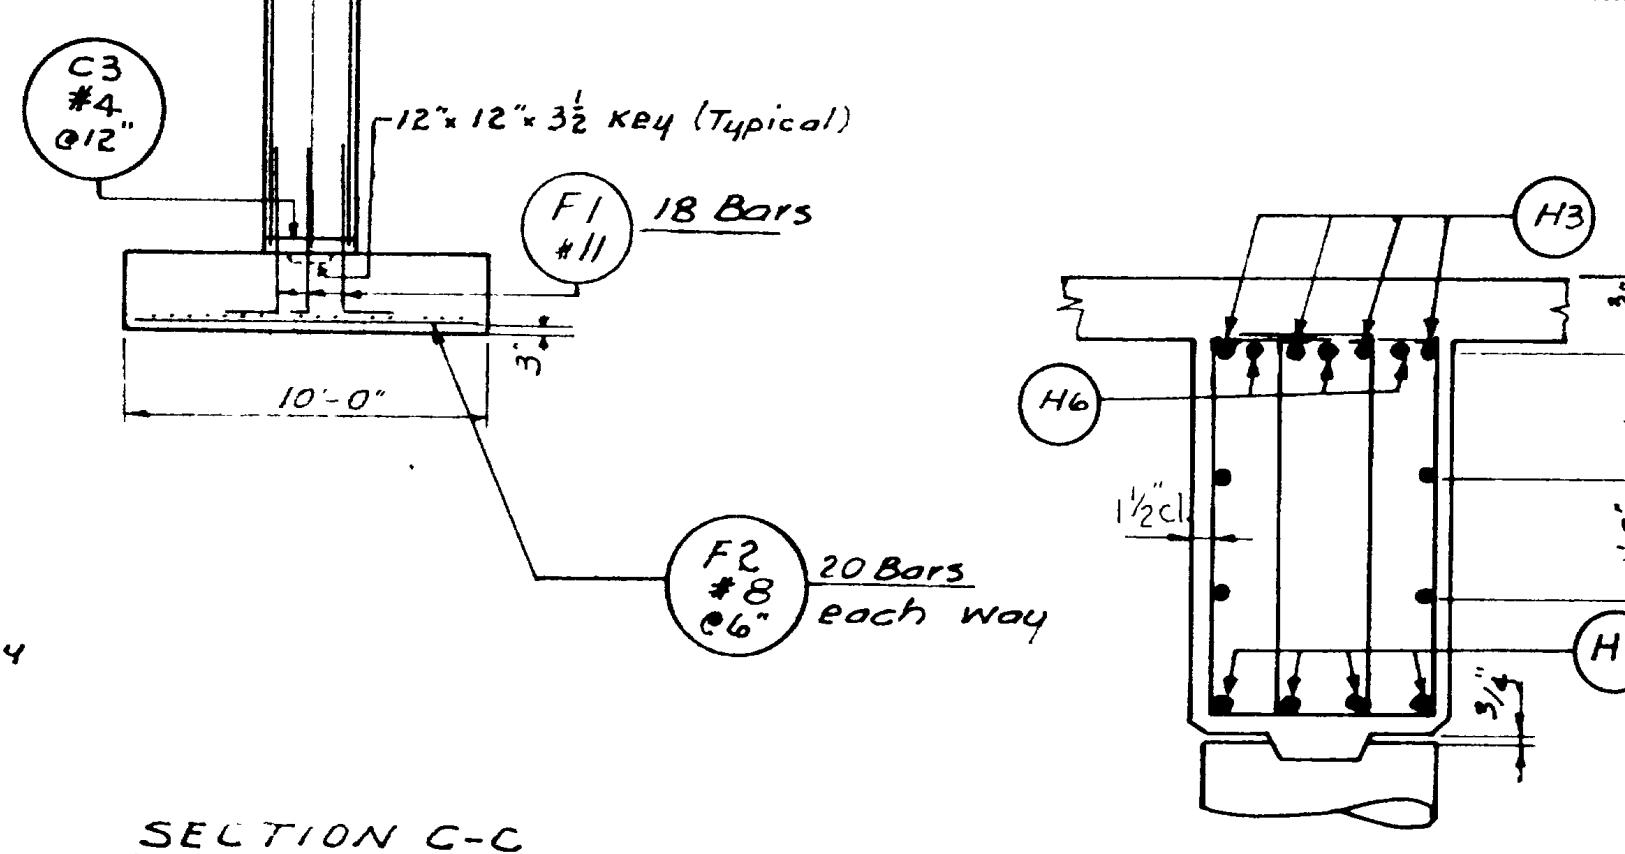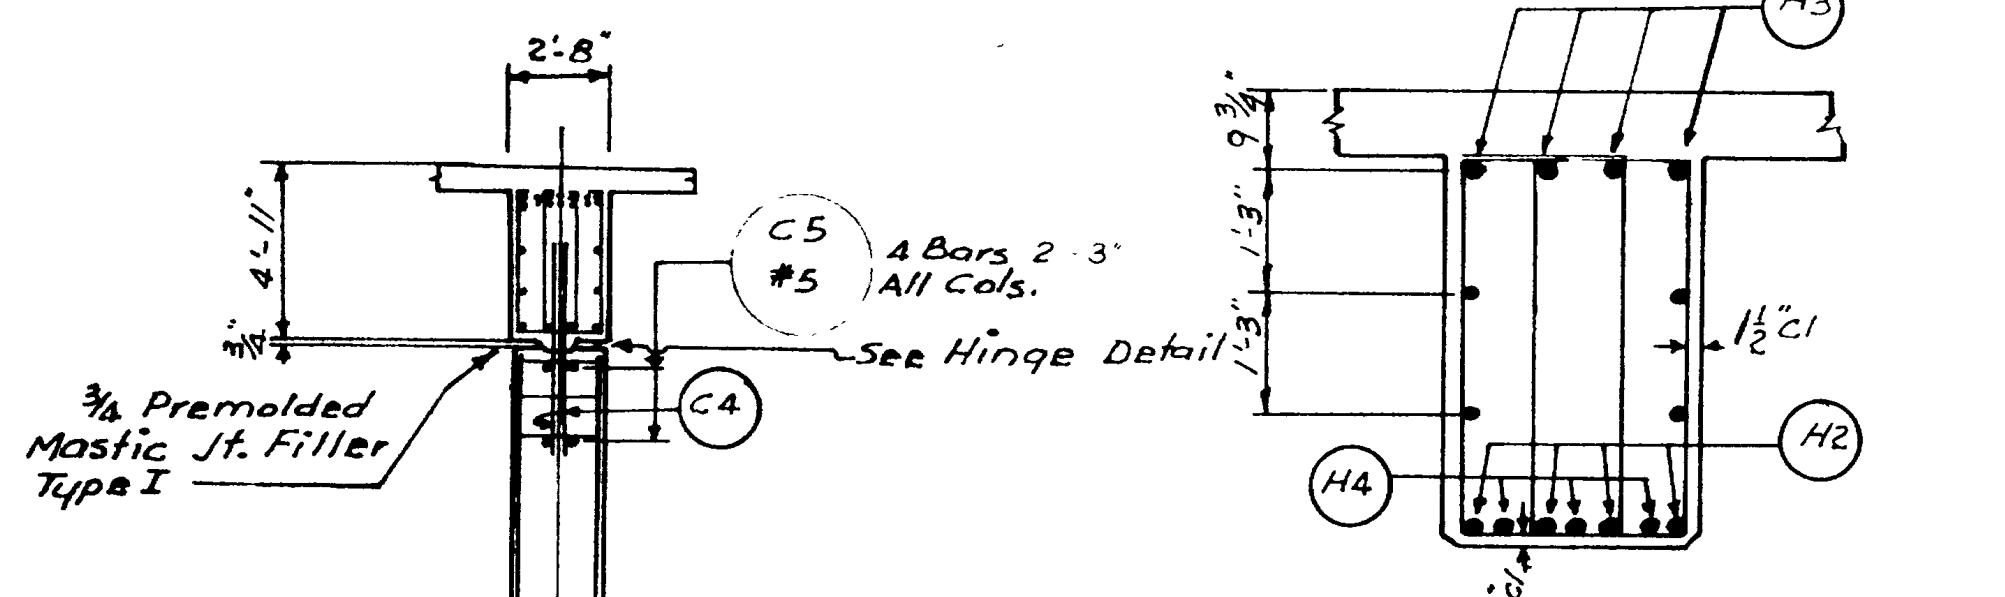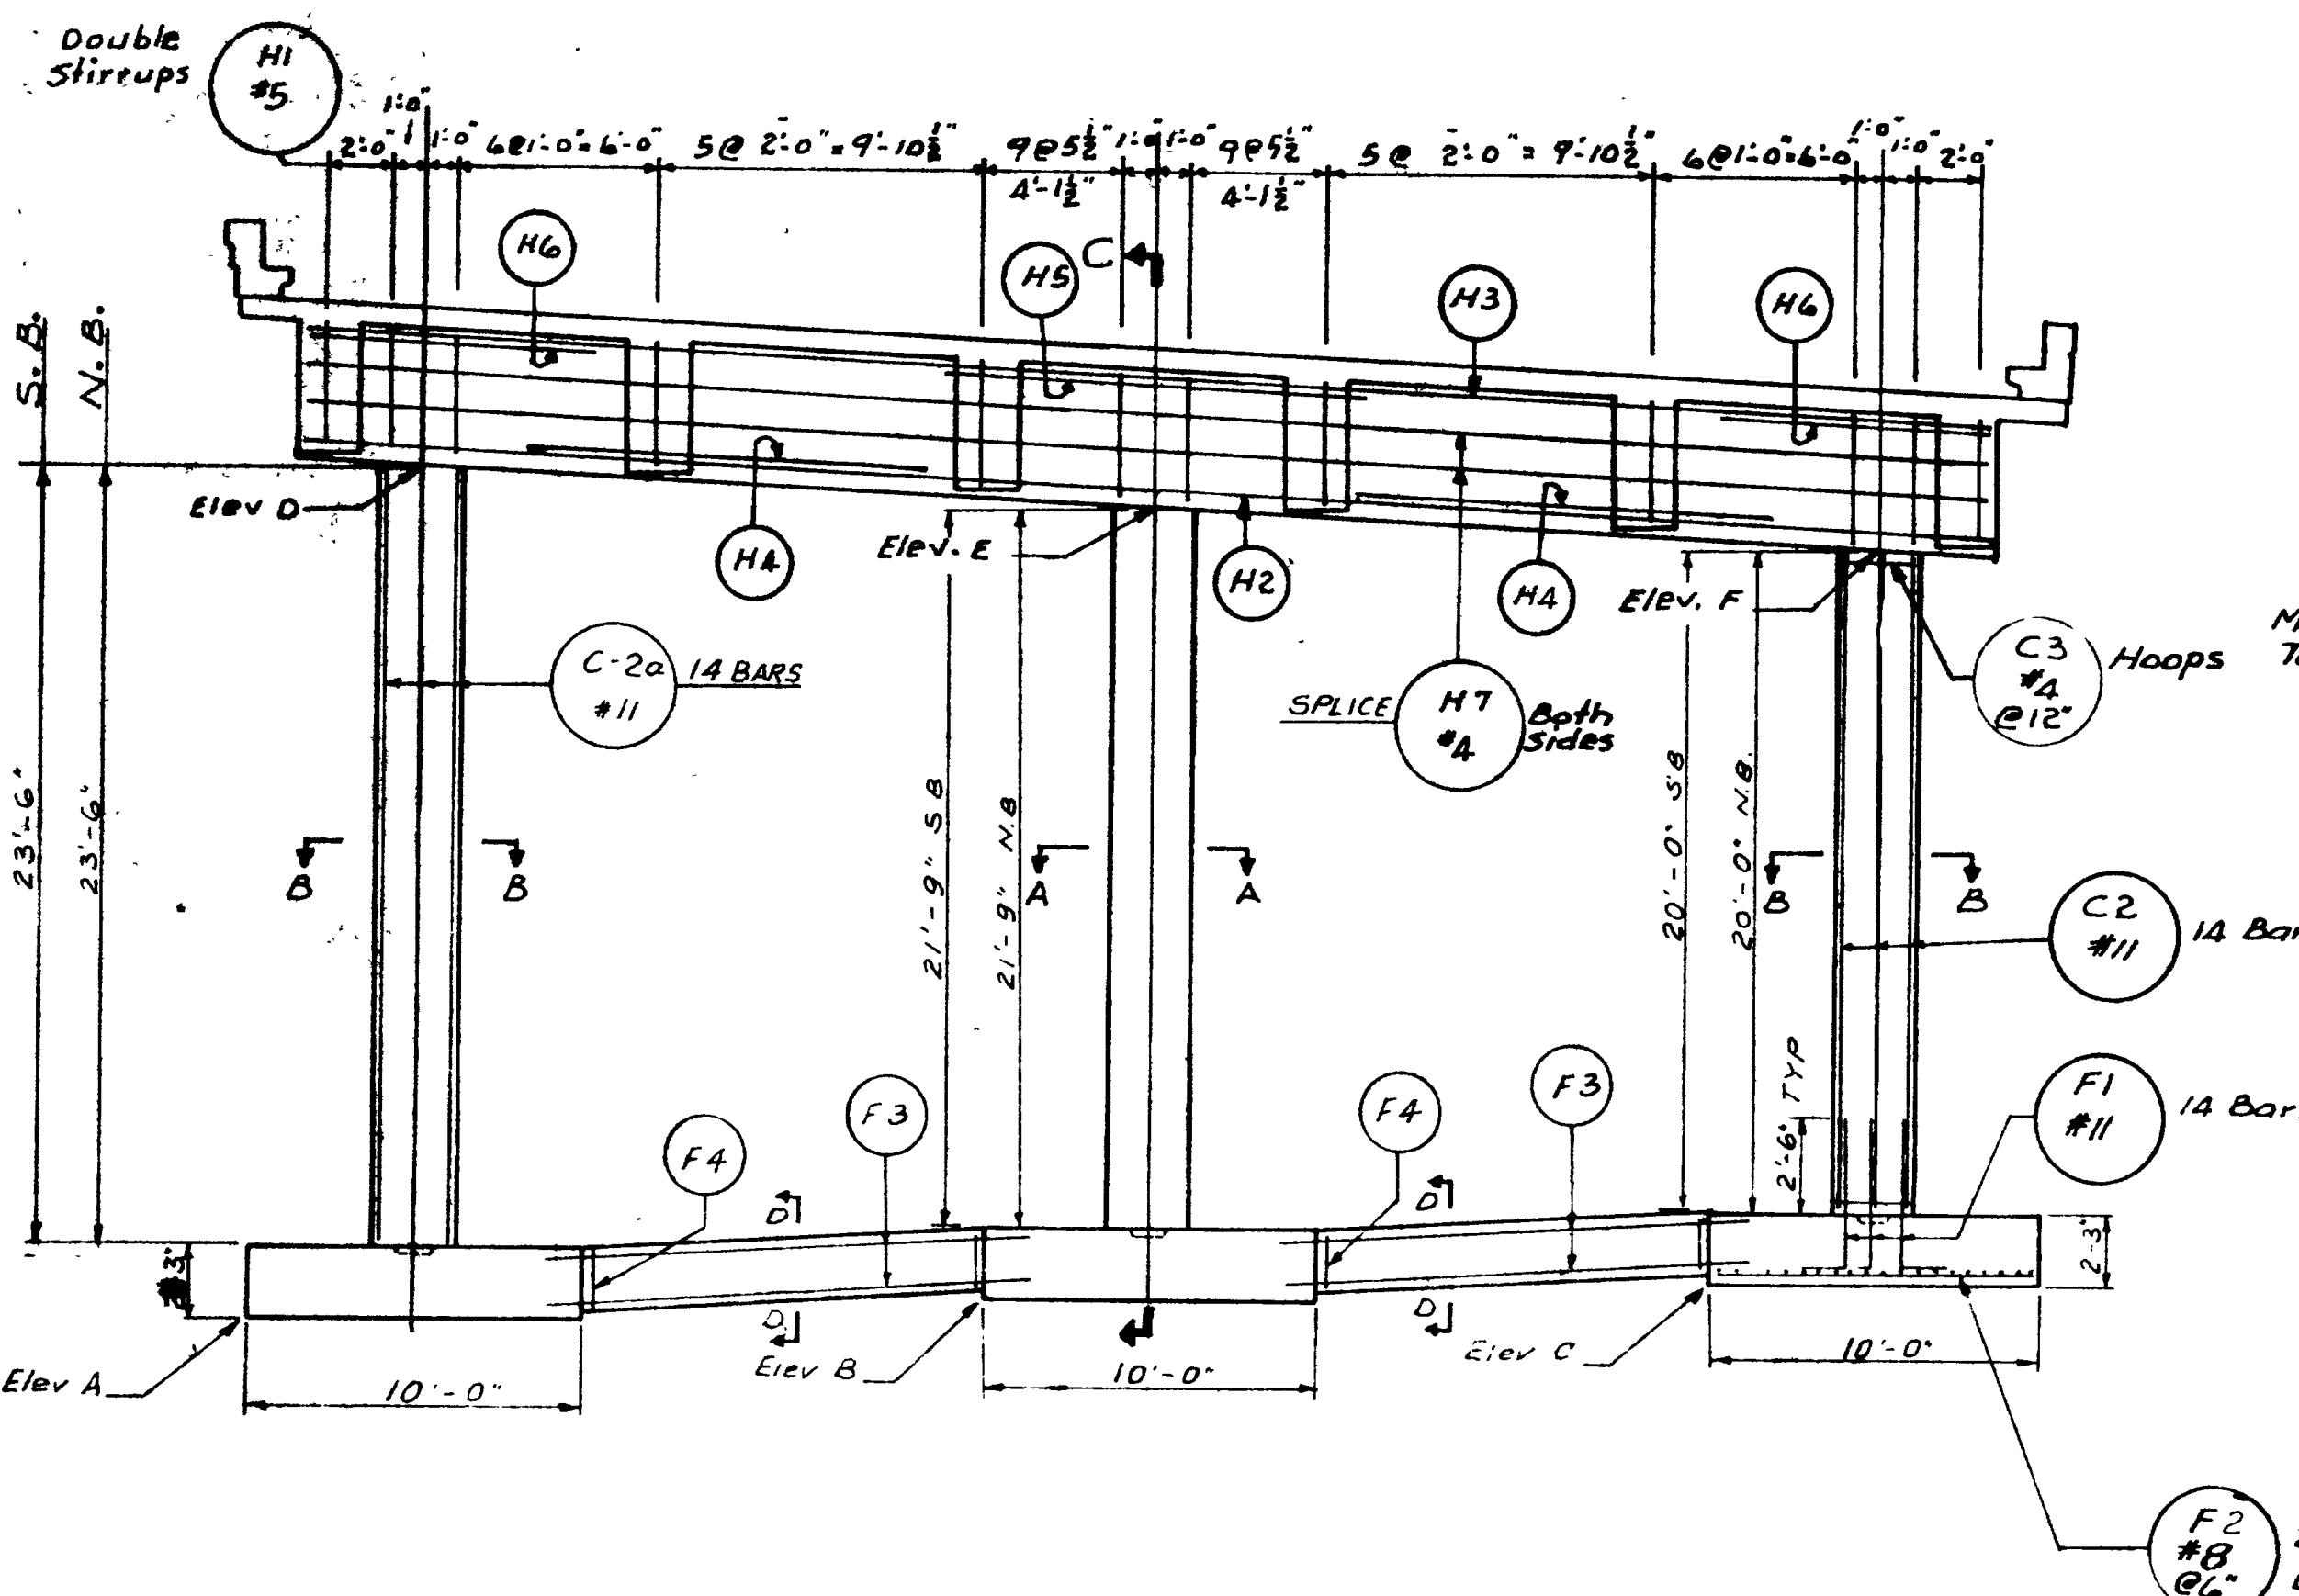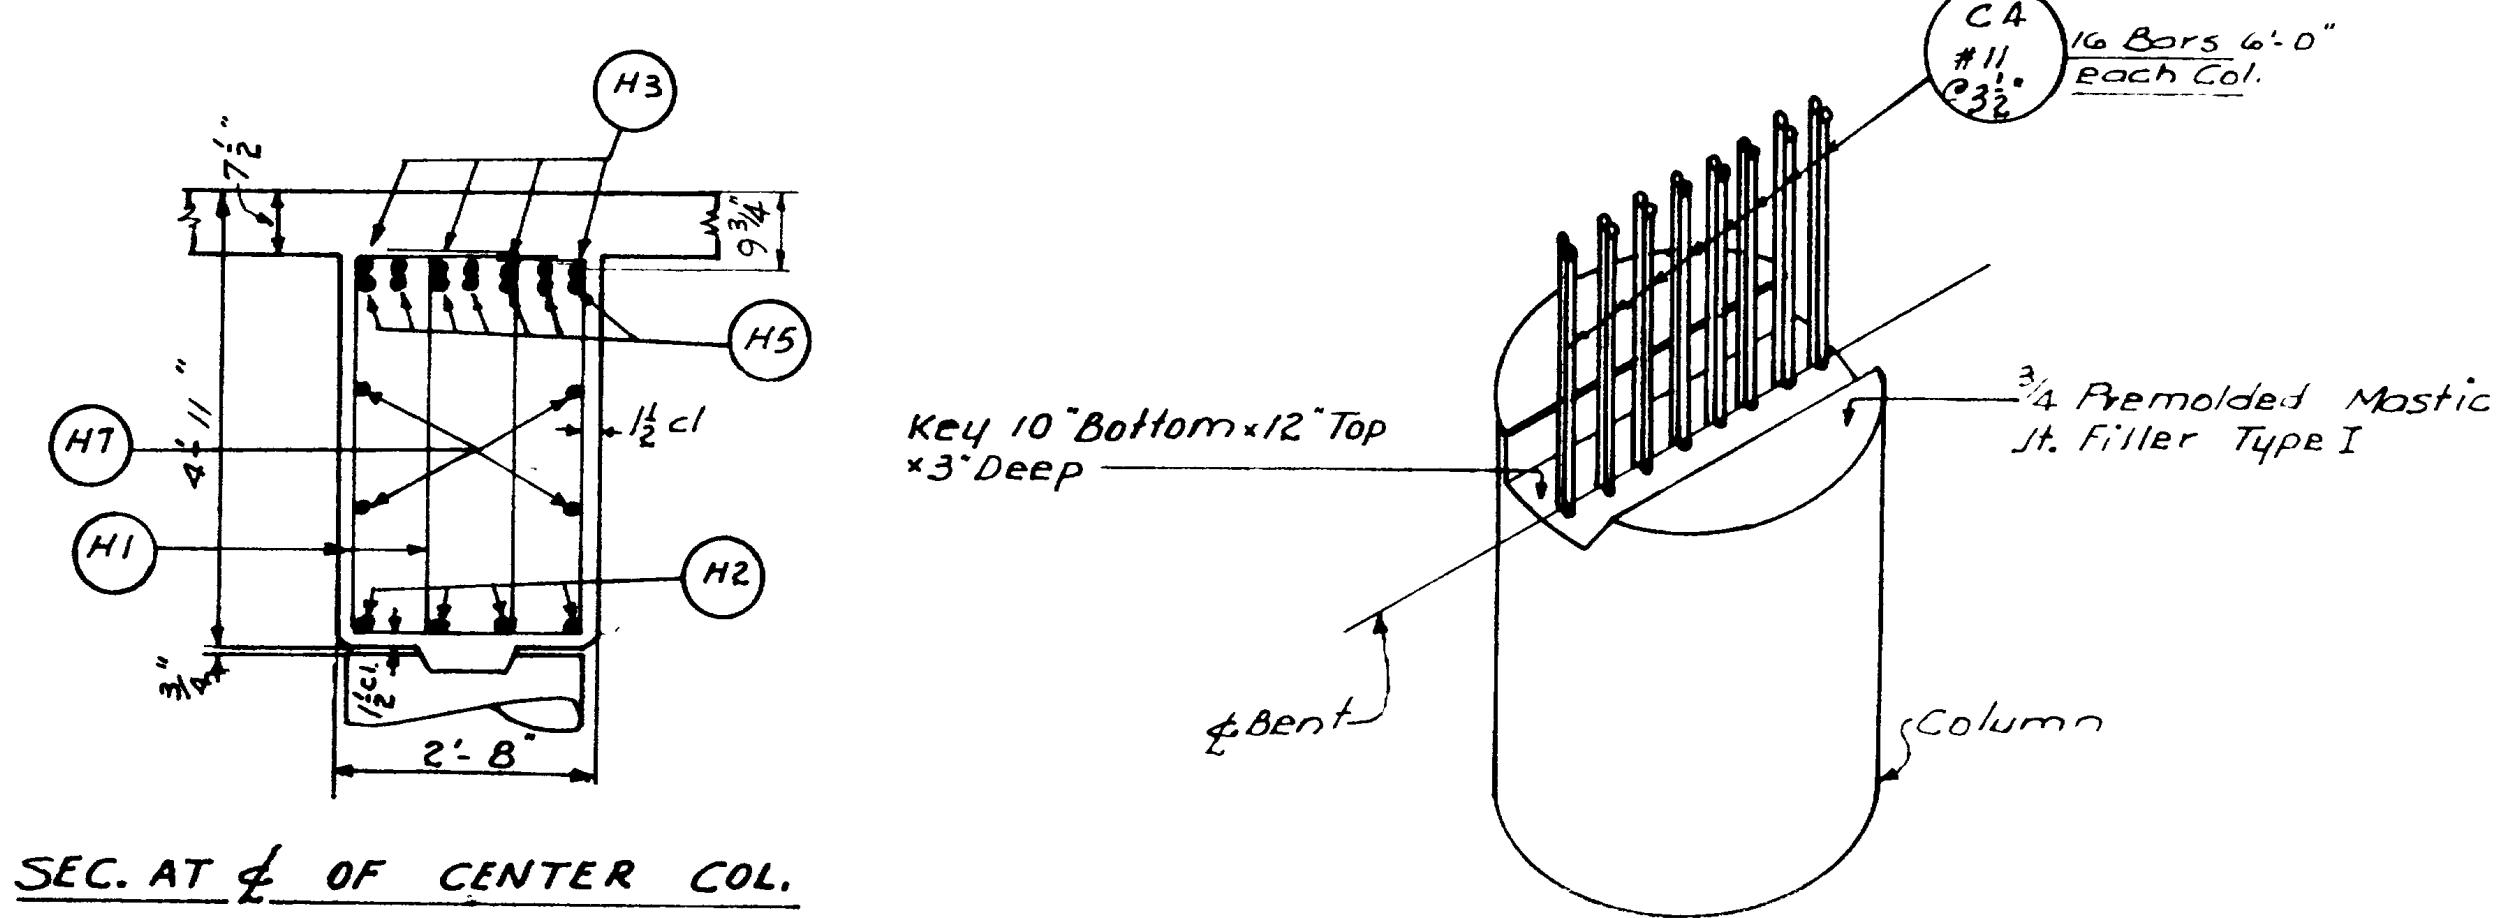





SEC. AT ¼ OF OUTSIDE COL.

TABLE OF ELEVATIONS					
POINT	A	B	C	D	E
BENT No. 2 S.B.	456404	456529	456...	459039	458929
BENT No. 3 S.B.	456437	456...	456...	459012	458902
BENT No. 2 N.B.	456735	456860	456...	459370	459260
BENT No. 3 N.B.	456762	456827	456...	459337	459227

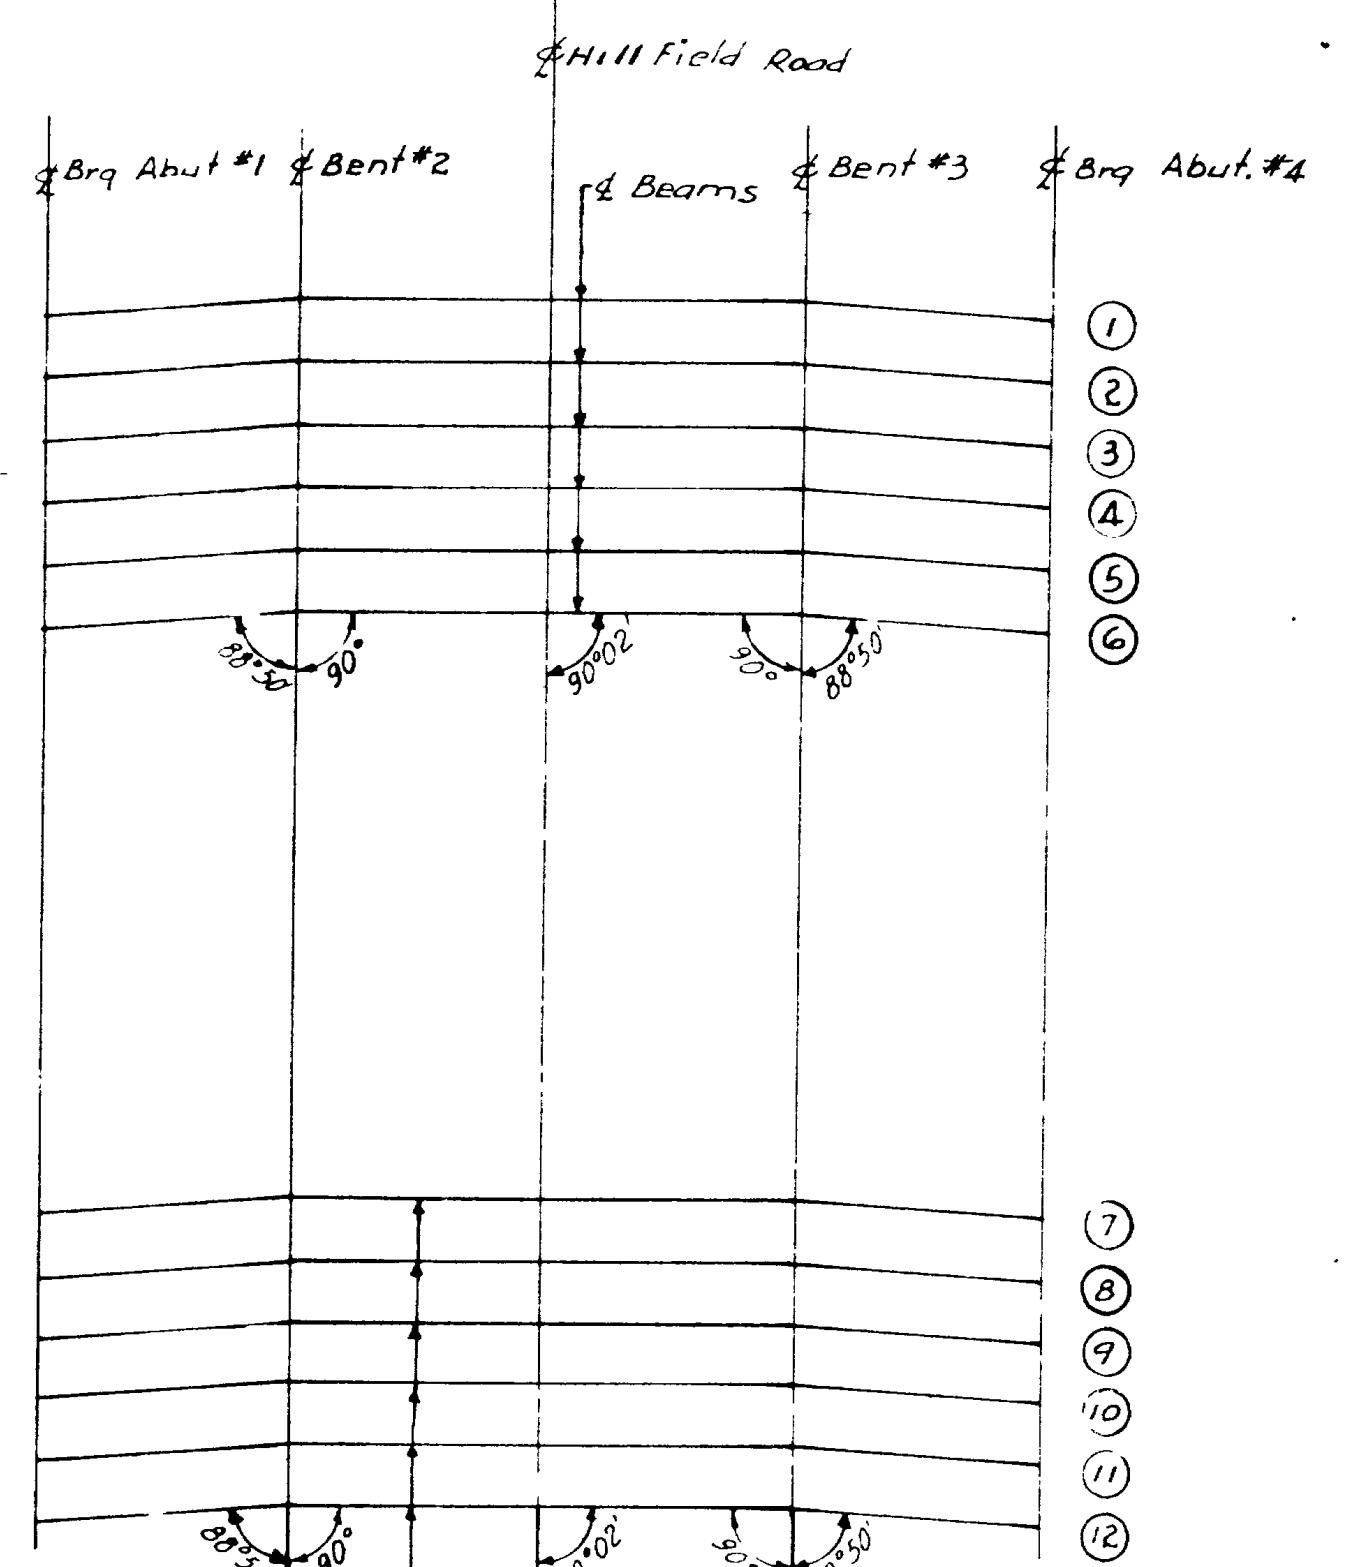


NOTE:
Elevations D, E, F, at bottom
of 3/4" Premolded Mastic Jt. Filler
Bottom hinge keyway 3" below.
See Sheet 2 for Foundation
Detail.

DESIGNED BY	M.W.	REVIEWED BY	M.T.C.	I-15-7158)332
DRAWN BY	B.M.W.	APPROVED BY	H.J.S.	PERIODIC NUMBER
QUANTIFIED BY	H.J.S.	APPROVED BY	B.M.W.	729+62.72
APPROVAL RECOMMENDED BY	W.W. Hansen	APPROVED BY	L.D. Hansen	STATION
APPROVAL DATE	Aug 1972	APPROVED DATE	Aug 1972	DOVIS
NO.	BY	DATE	REMARKS	COUNTY
REVISIONS	BY	DATE	REMARKS	
BR NO	BY	DATE	REMARKS	
D-719 6 OF 13				

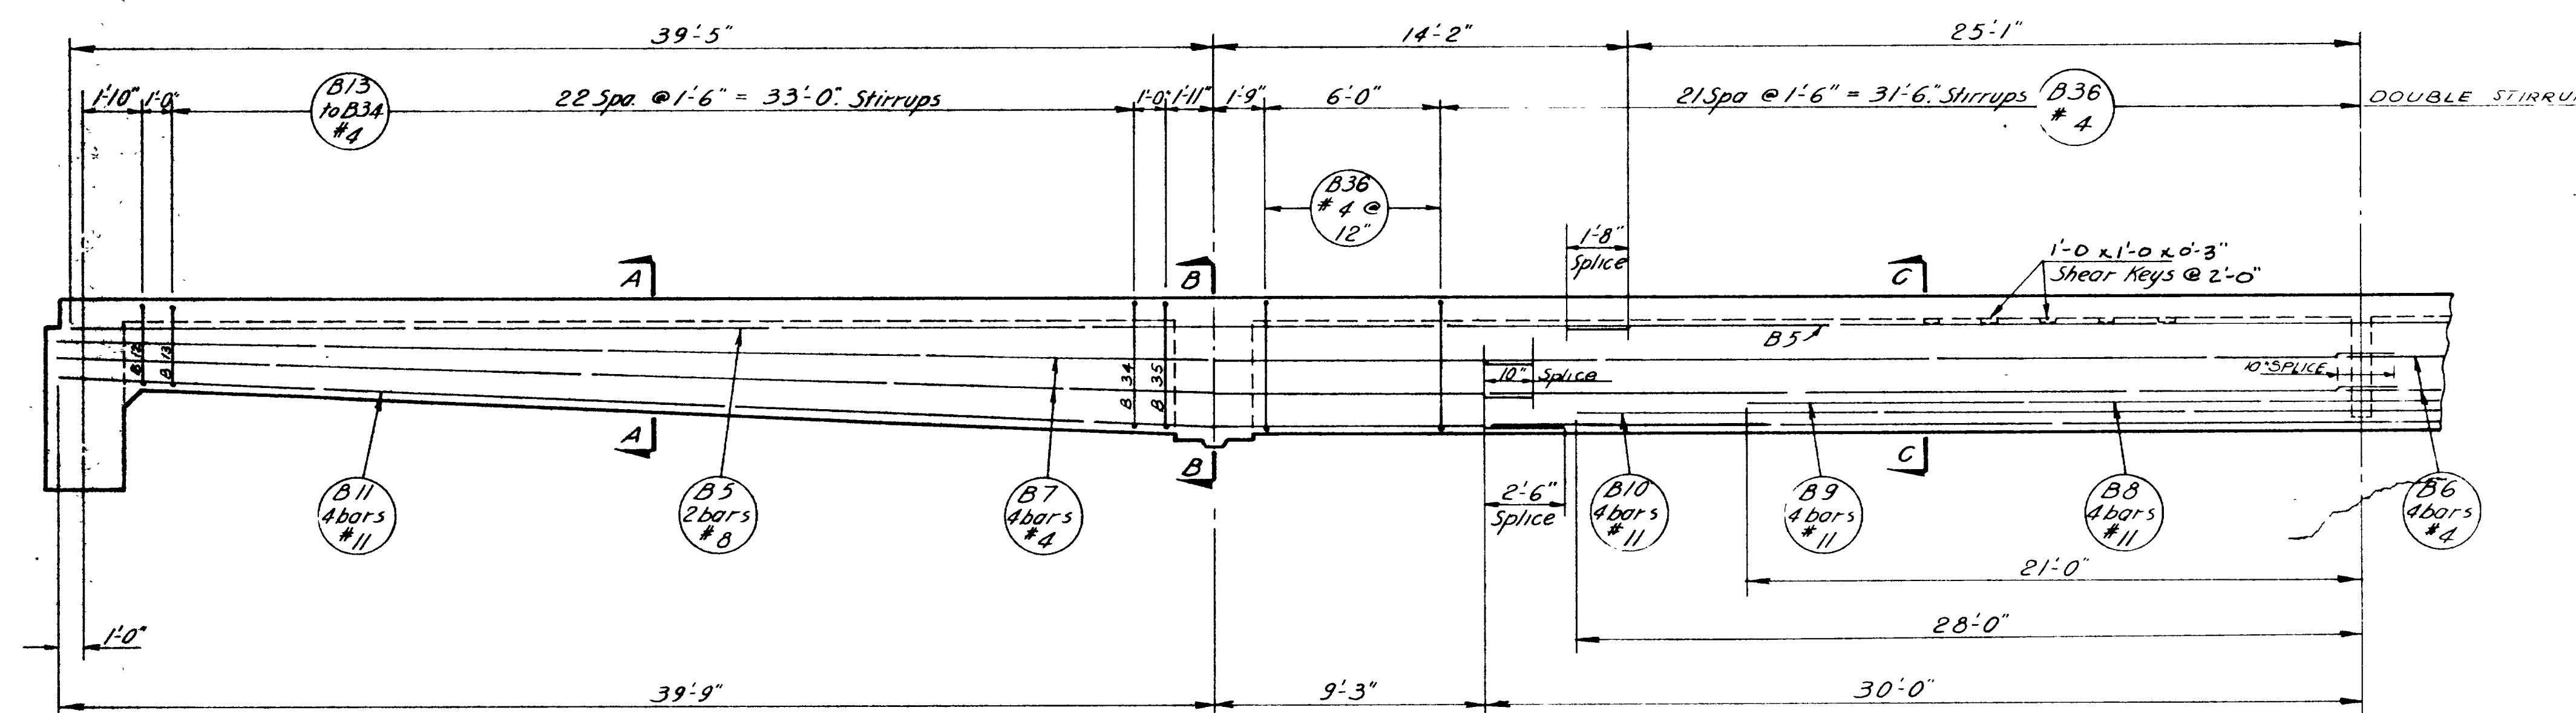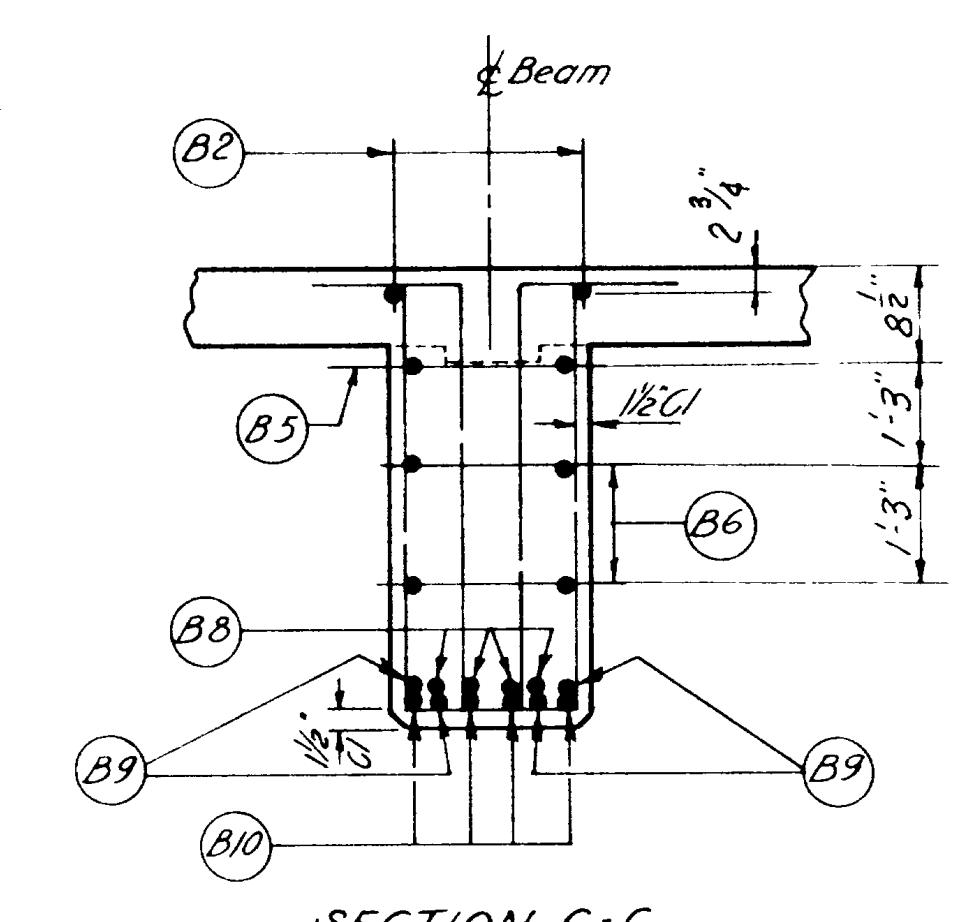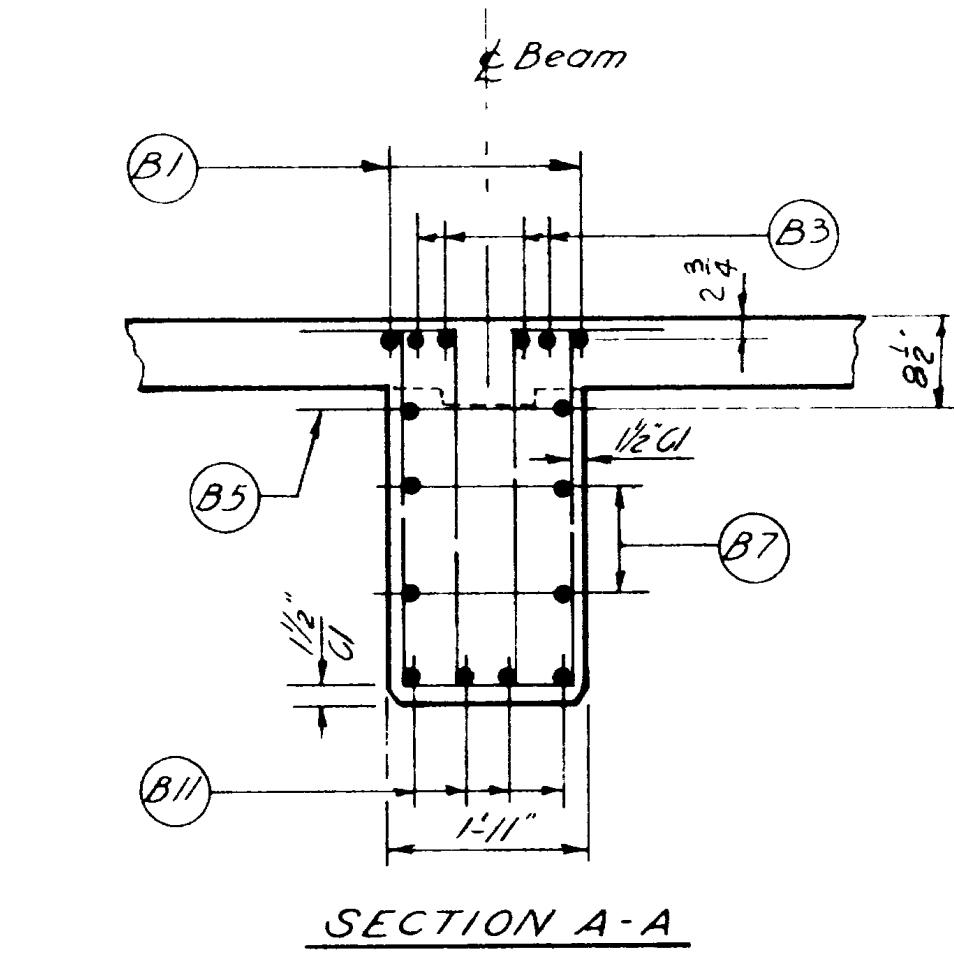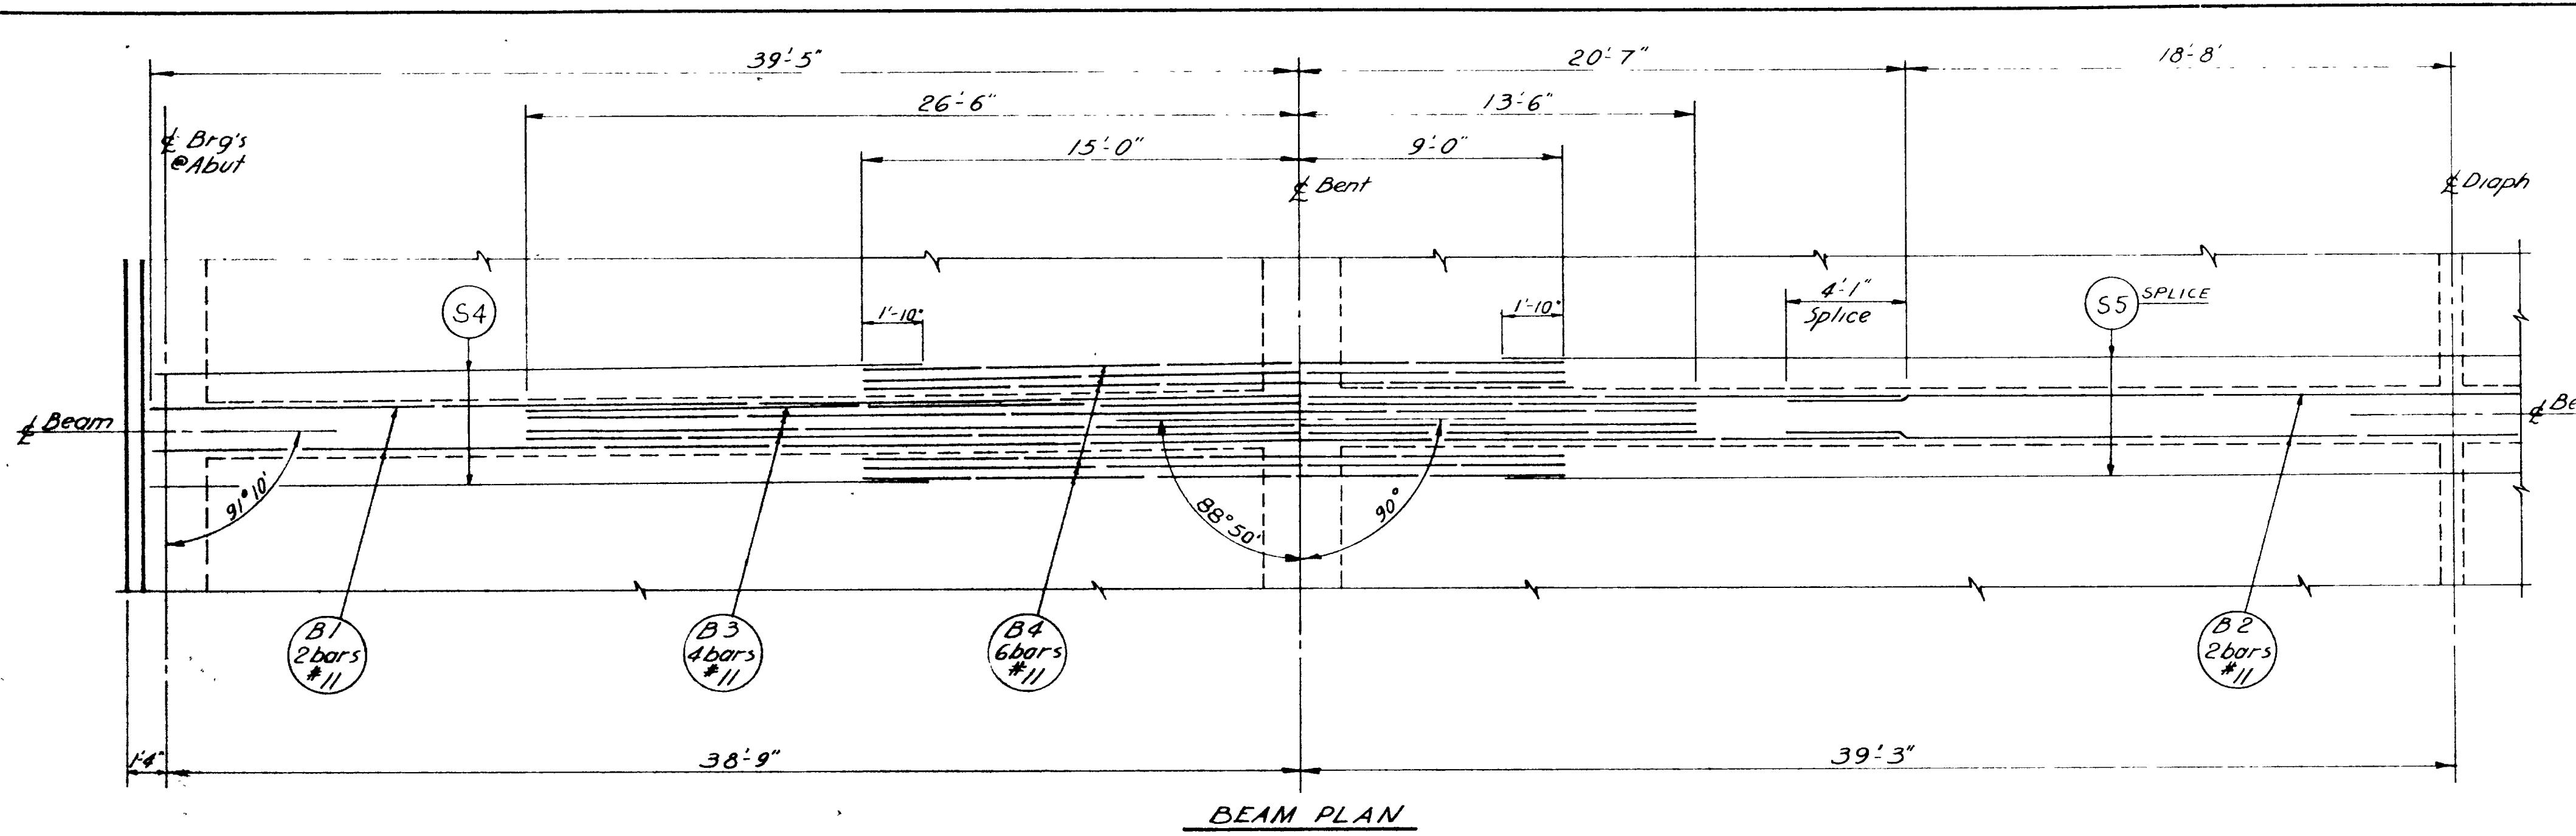

SECTIONAL ELEVATION

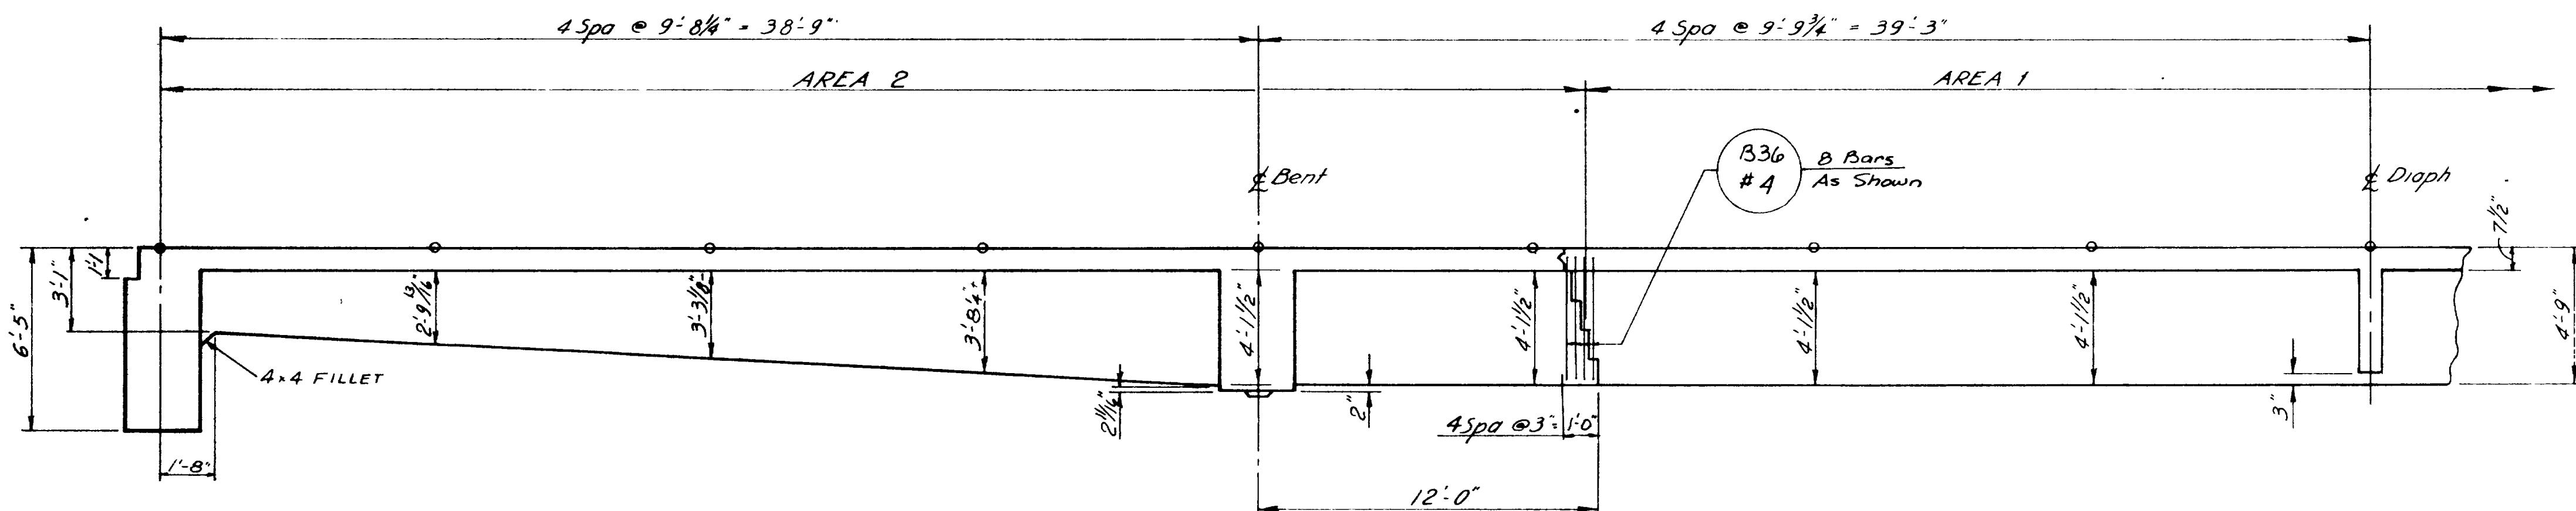


BEAM DEPTH AT £ OF BEAM AND CONCRETE PLACING SEQUENCE

NOTE:
AREA 1 and AREA 2 indicate sequence of placing beam stem concrete. AREA 2 may be placed simultaneously with AREA 1 when approved by the Engineer and provided that the AREA 1 sections are placed in adjoining spans.


placed in adjoining spans.
Shear Keys shall be provided when
concrete deck is not placed simultaneously
with beam stems.

UTAH STATE DEPARTMENT OF HIGHWAYS			
SALT LAKE CITY UTAH			
STRUCTURES DIVISION			
HILLFIELD INTERCHANGE TO DAVIS-WEBER CO. LINE			
HILL FIELD ROAD INTERCHANGE O'PASS			
BEAM DETAILS			
DESIGNED BY . M W.	REK'D BY M J C	I-15-7(58)332	
DRAWN BY H D S	REK'D BY H J S	PROJECT NUMBER	
QUANTITIES BY H J S	REK'D BY B M.W.	729+62 72	
APPROVAL	STATION		
COMMENDED BY <i>Jay Christensen</i>	DAVIS		
PPR REC. <i>Aug 22 - 2</i>	COUNTY		
R	DR.	D-719	
O	N	7 OF 13	

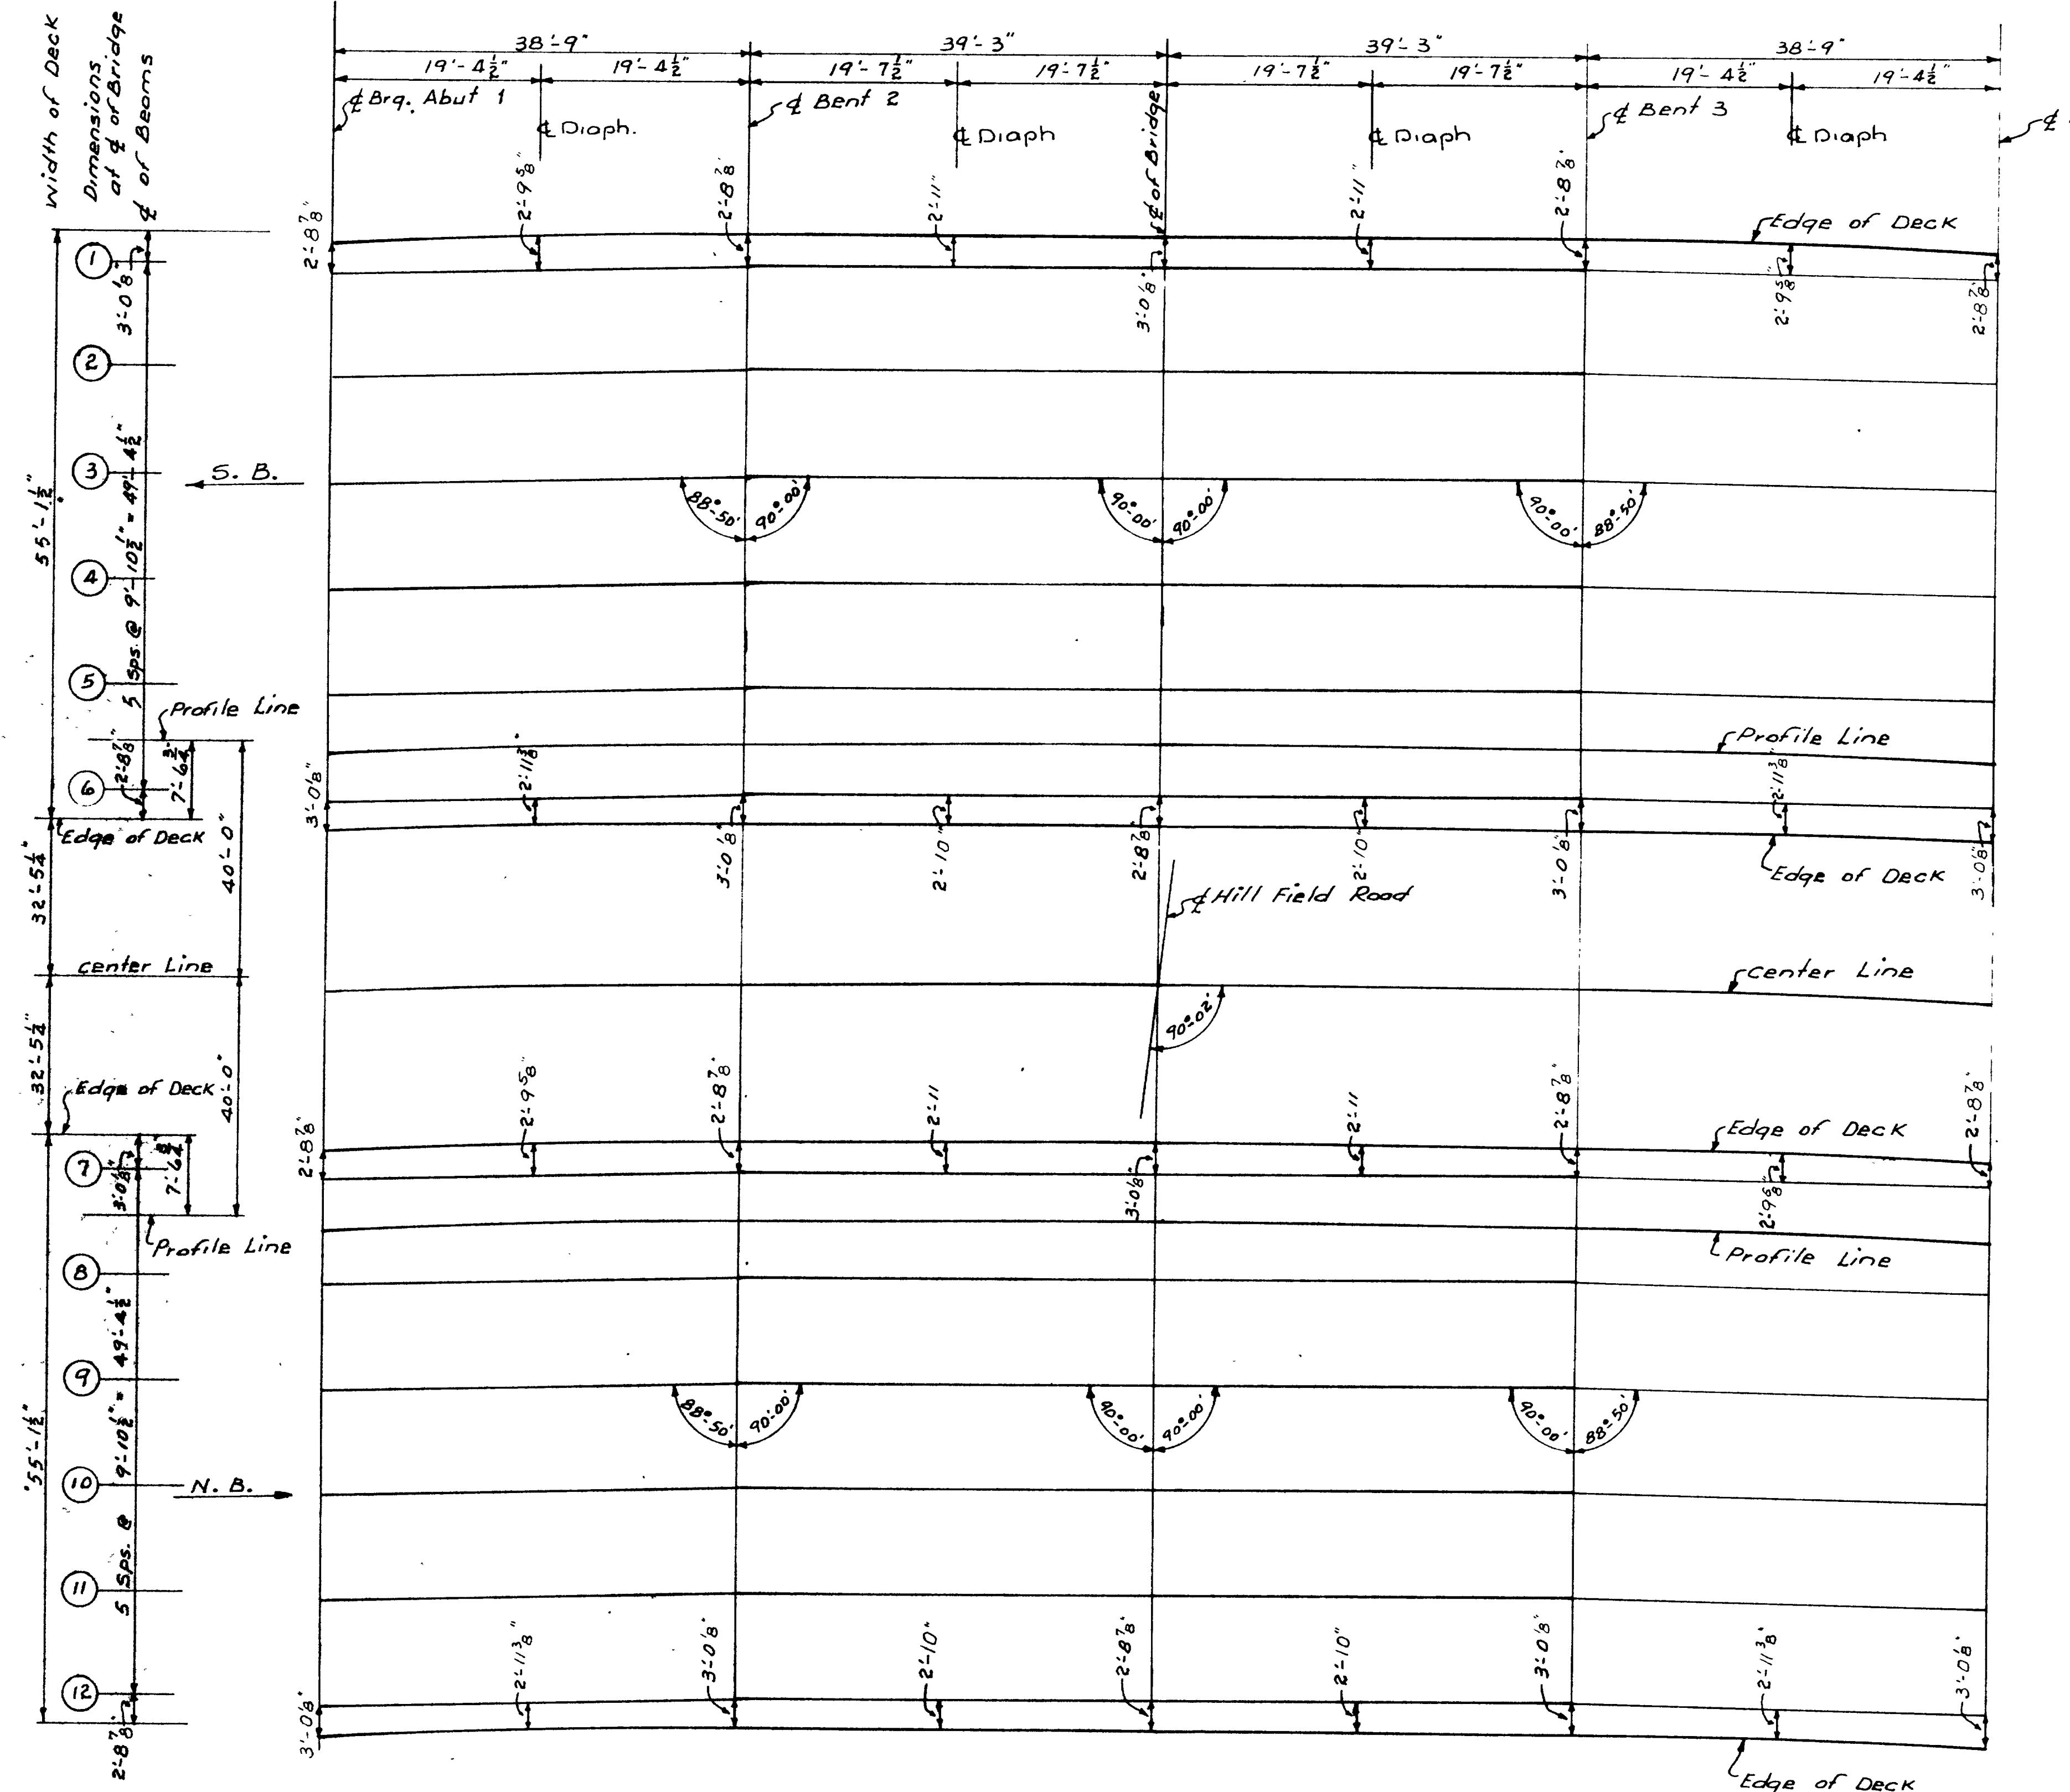


UTAH STATE DEPARTMENT OF HIGHWAYS STRUCTURES DIVISION			
HILLFIELD INTERCHANGE TO DAVIS WEBER CO LINE			
HILL FIELD RD INTERCHANGE O'PASS			
BEAM FRAMING PLAN			
DRAWN BY M W	MAILED I-15-7 (58) 332		
DRAWN BY B MW	HJS		
SUPERVISED BY H JS	B MW		
APPROVED BY W W WOODWARD DATE 10/10/62			
DAVIS CITY			
NO. BY DATE	REMARKS		
REVISONS			

D-719 8 of 13

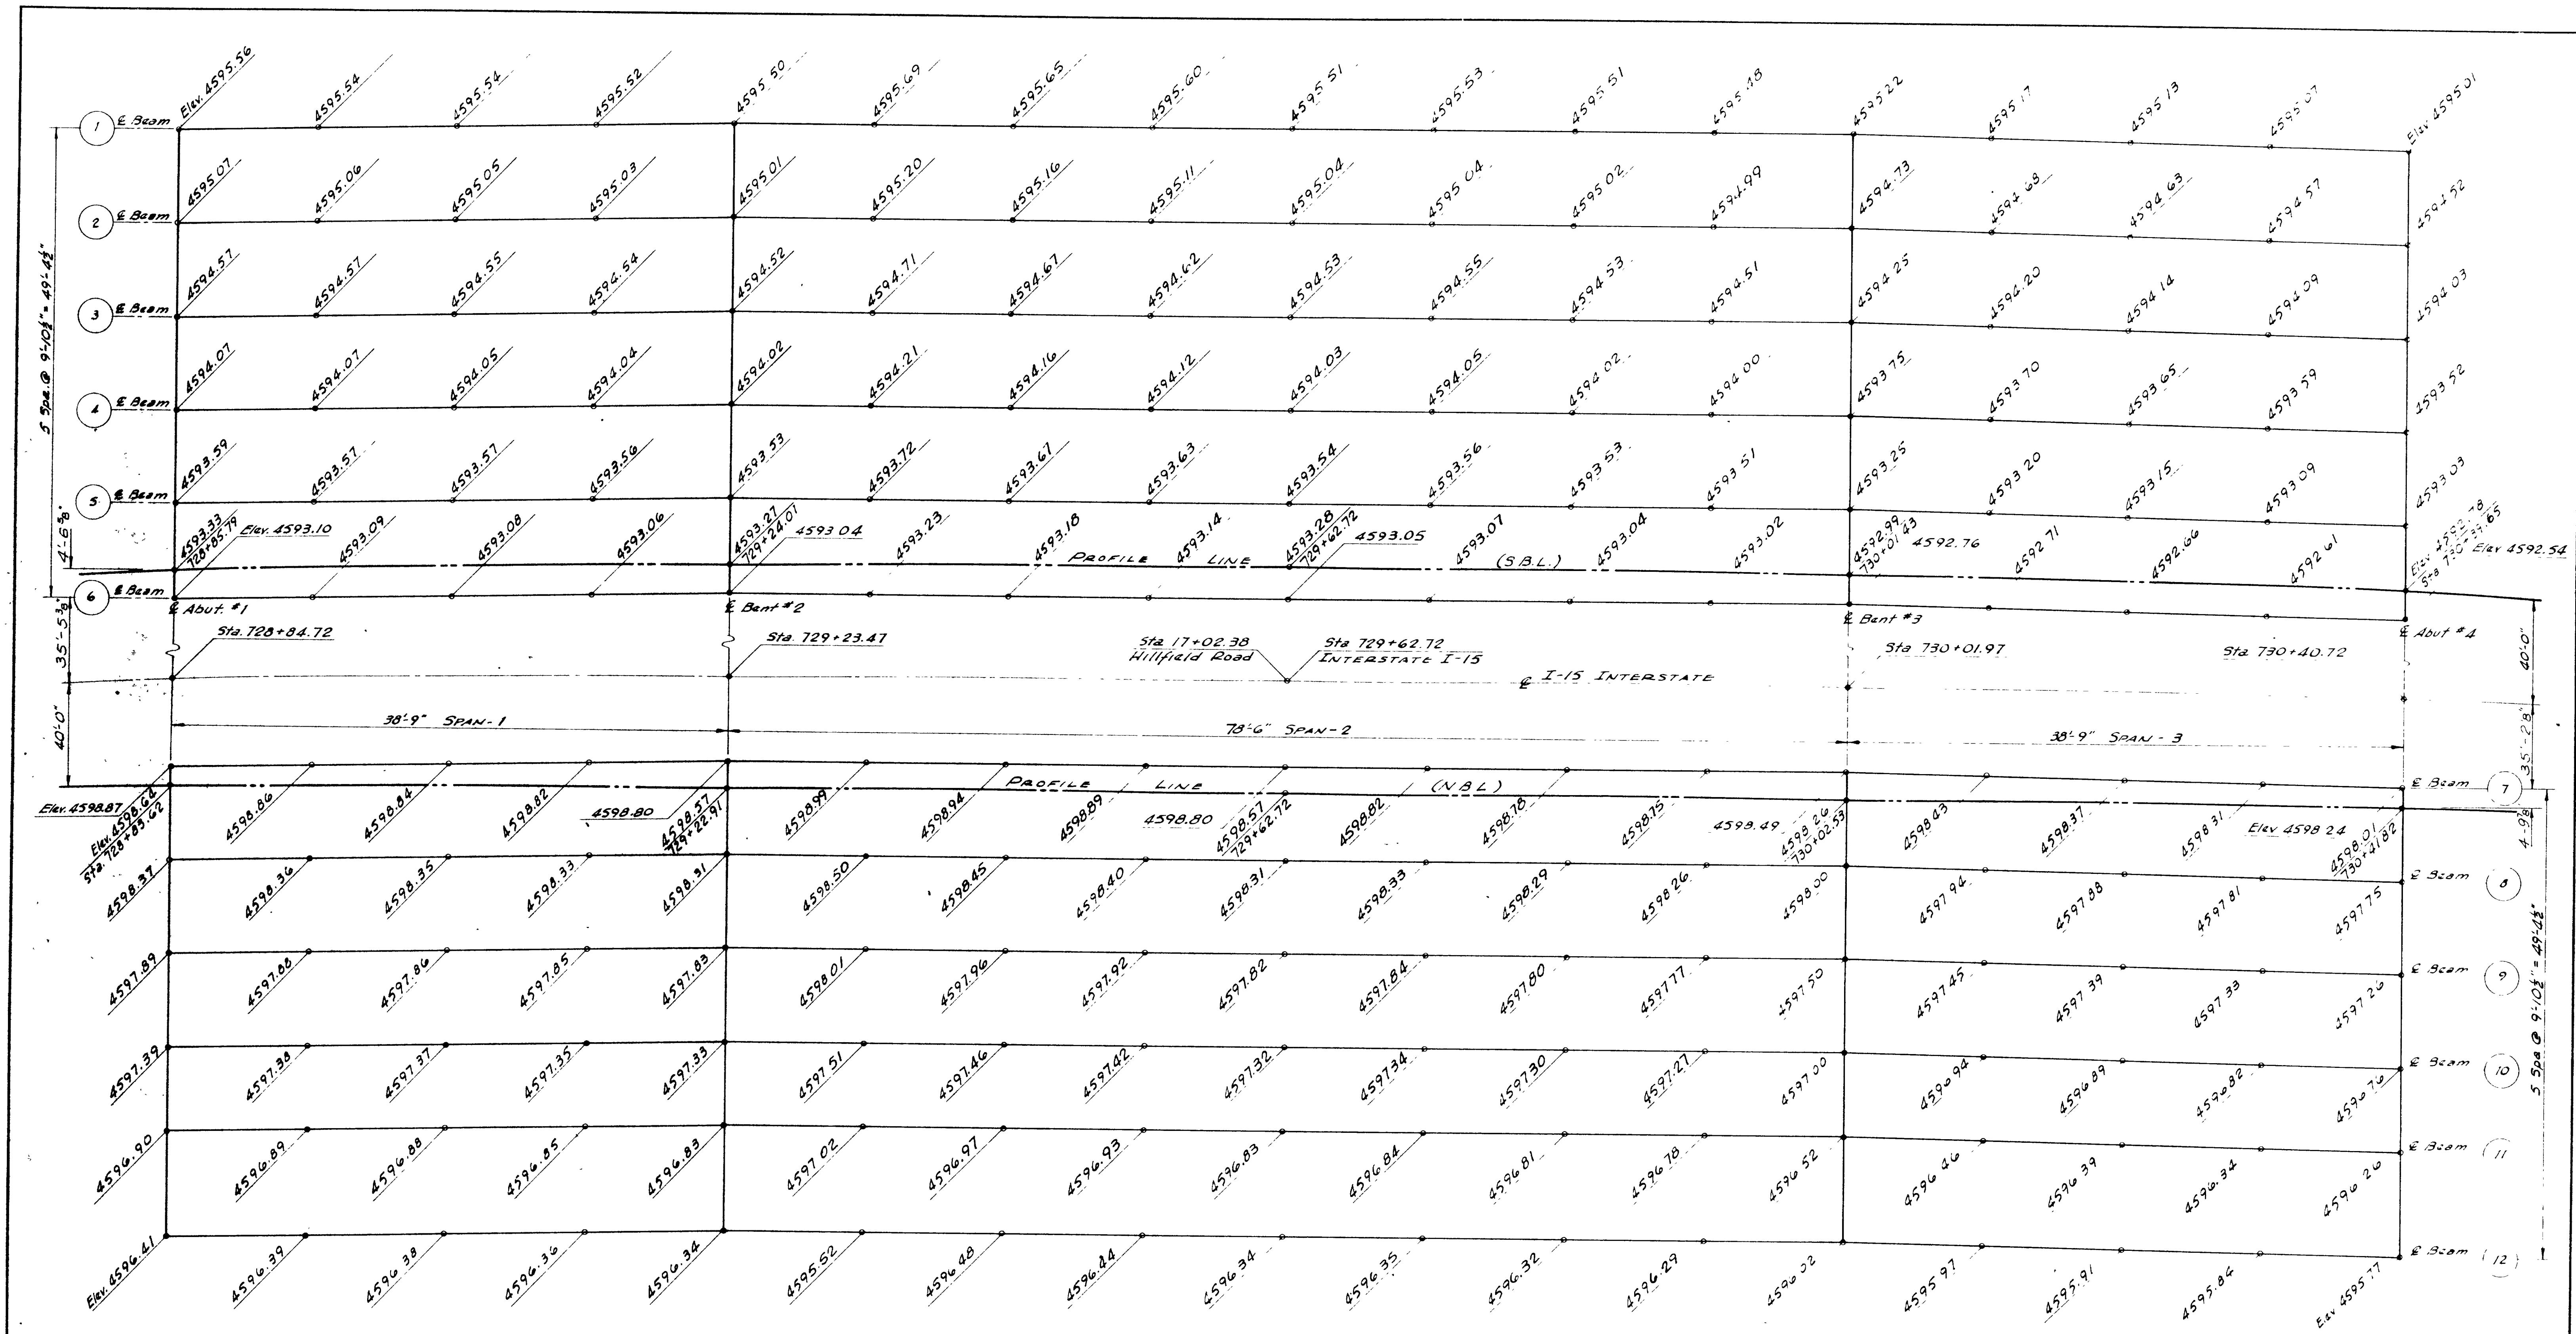

NOTE
Elevations shown are finished grade plus
 $1.25 \times$ total dead load deflection


UTAH STATE DEPARTMENT OF HIGHWAYS			
A. A. F. C. I. Y. - M.			
STRUCTURES DIVISION			
HILLFIELD INTERCHANGE TO DAVIS-WEBER CO LINE			
HILL FIELD RD. INTERCH O'PASS			
SCREED ELEVATIONS			
DESIGNER BY	MW	HE K. R.	M J C
DESIGNER BY	SEF	HE K. R.	H J S
PLAN & EST. BY	H J S	HE K. R.	I-15-7(38)332
APPROVAL			PP COTN MBR
RECOMMENDATION	by Gary Christiansen		STATION
APPROVAL	Aug 21 1982	+	DAVIS
BR N.			INTY
	D-719	9 OF 13	

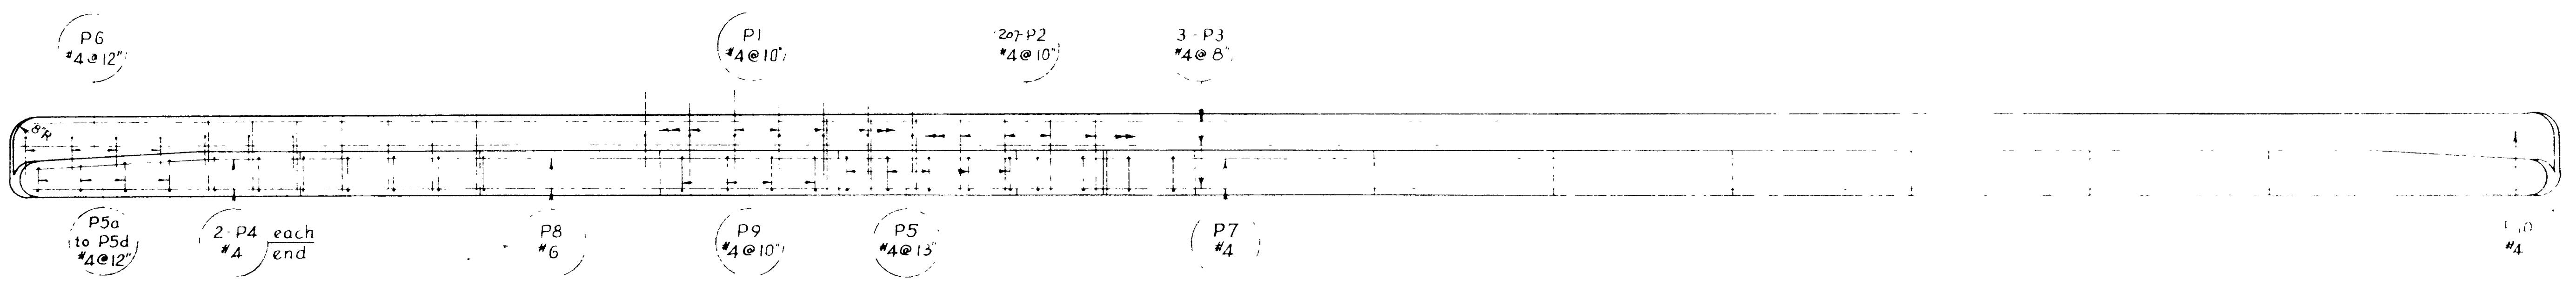

PARAPET PLAN


NOTE

- 1 The cut and pump it shall not be poured until at least 7 days after the slab has been poured and until all shoring has been removed.
- 2 See Sheet MR 1-6 for Details of Rail Installation.

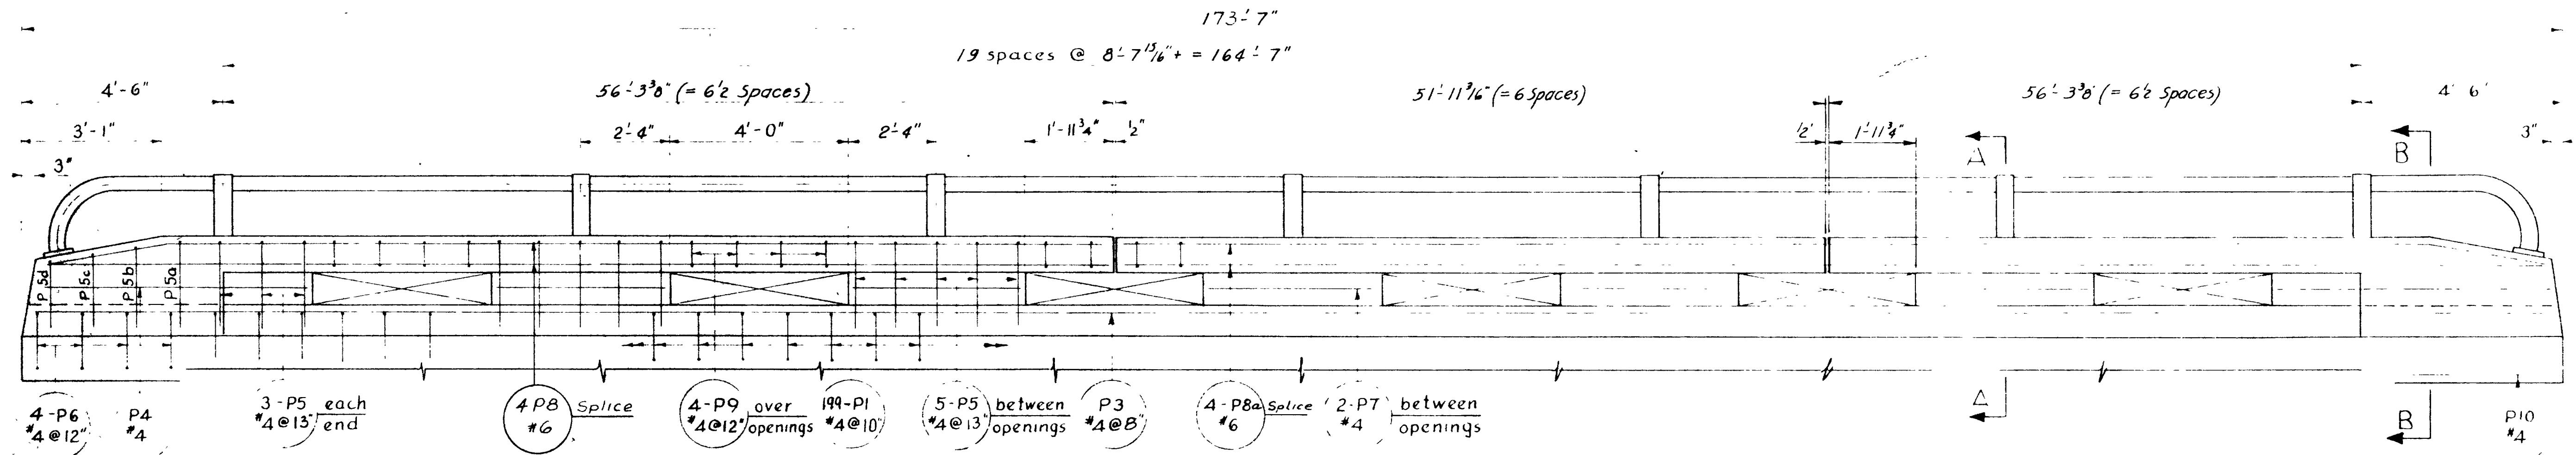


PARAPET ELEVATION


Continue rail parallel to ends of parapet until the curve is reached.

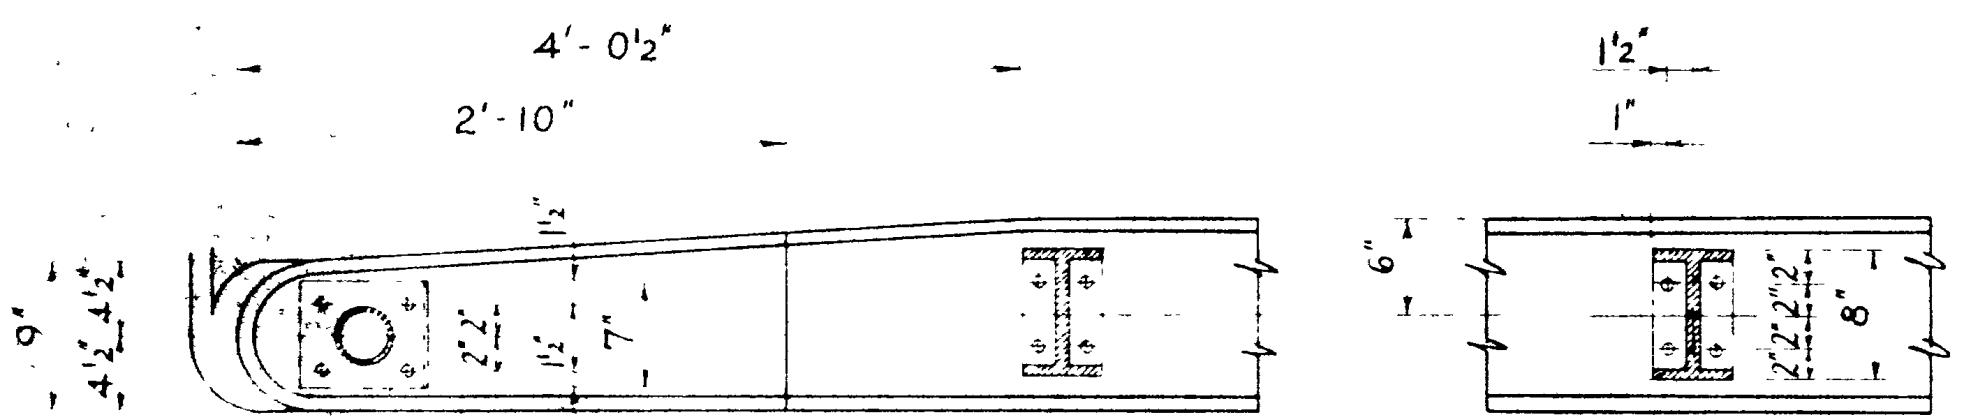

RAILING PLAN

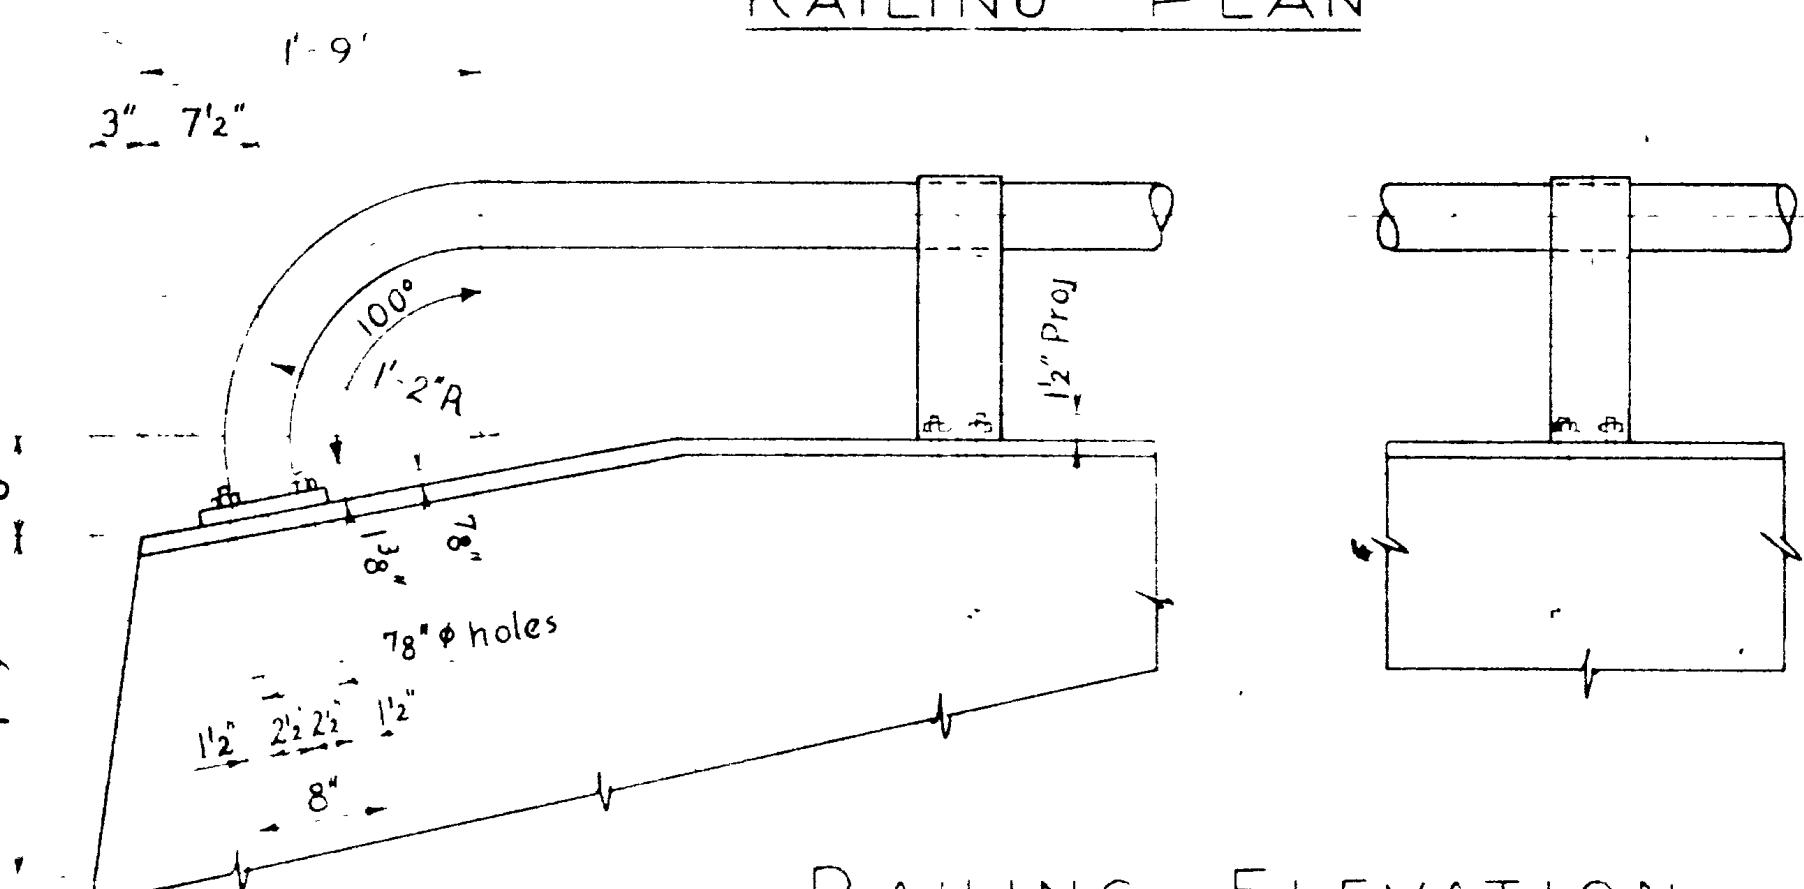


RAILING ELEVATION

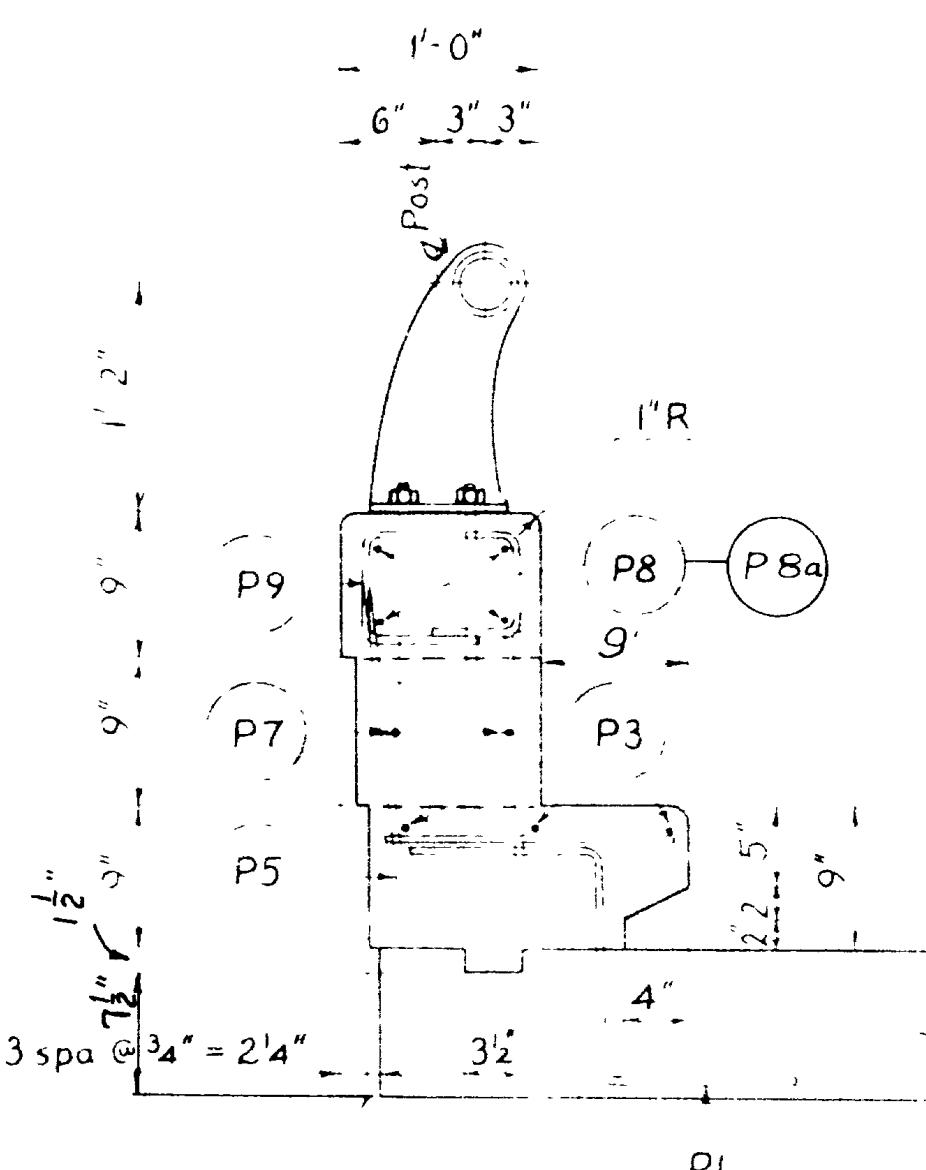

RAILING DETAILS

SEC'D OR. "A-3"

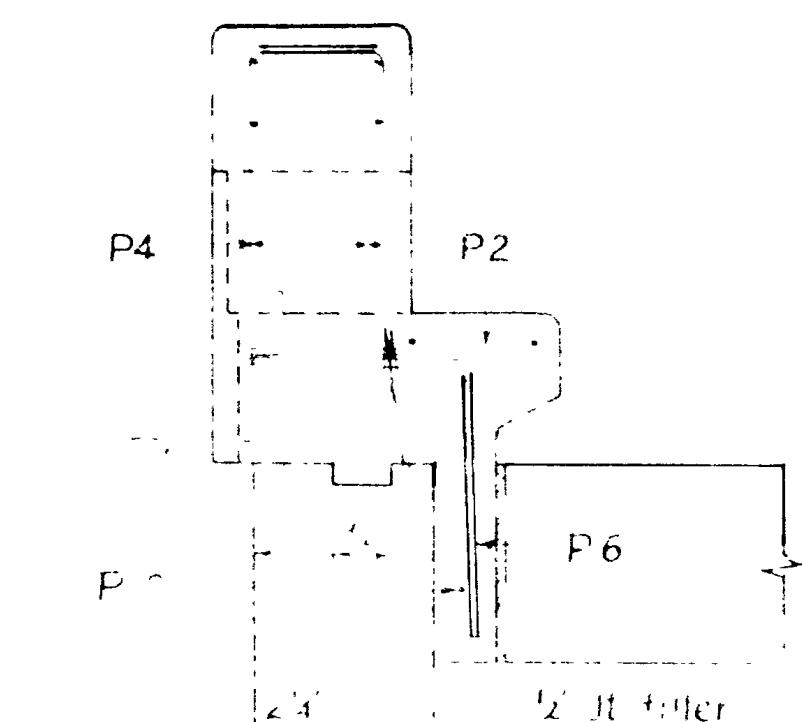



卷之三

HILLFIELD INTERCHANGE TO DAVIS-WEBER CO LINE
HILLFIELD N. IAH 75
FATIGUE 1.5
M.W MTS I-15-7(58)332
HFT HJS
HHS BMW .29 + 62.72
m/jay Christiansen.
I-15-7(58)333 DAVIS

CONC SLOPE PROTECTION					
Location No.	Avg Slope	Area	Area 1"	Area 2"	Area 3"
1	38'-1 1/2"	7.7	382.55	334.81	
2	38 - 7 1/2"	2.7	37.23	33.243	
3	38'-1 1/2"	2.7	32.85	29.54	33.049
4	38 - 4 1/2"	2.1	27.55	27 + 51	33.335
					337.08

NOTES

- ① Quantity in q Yds per linear foot of surface
- ② Area 1" = Berm Width x Average Slope x Length
- ③ Area 2" or "3" = Slope Area 1" x Length x 1/2
- ④ Elevations of the toe of slope are approximate only and shall be verified in the field by the Engineer at time of construction.

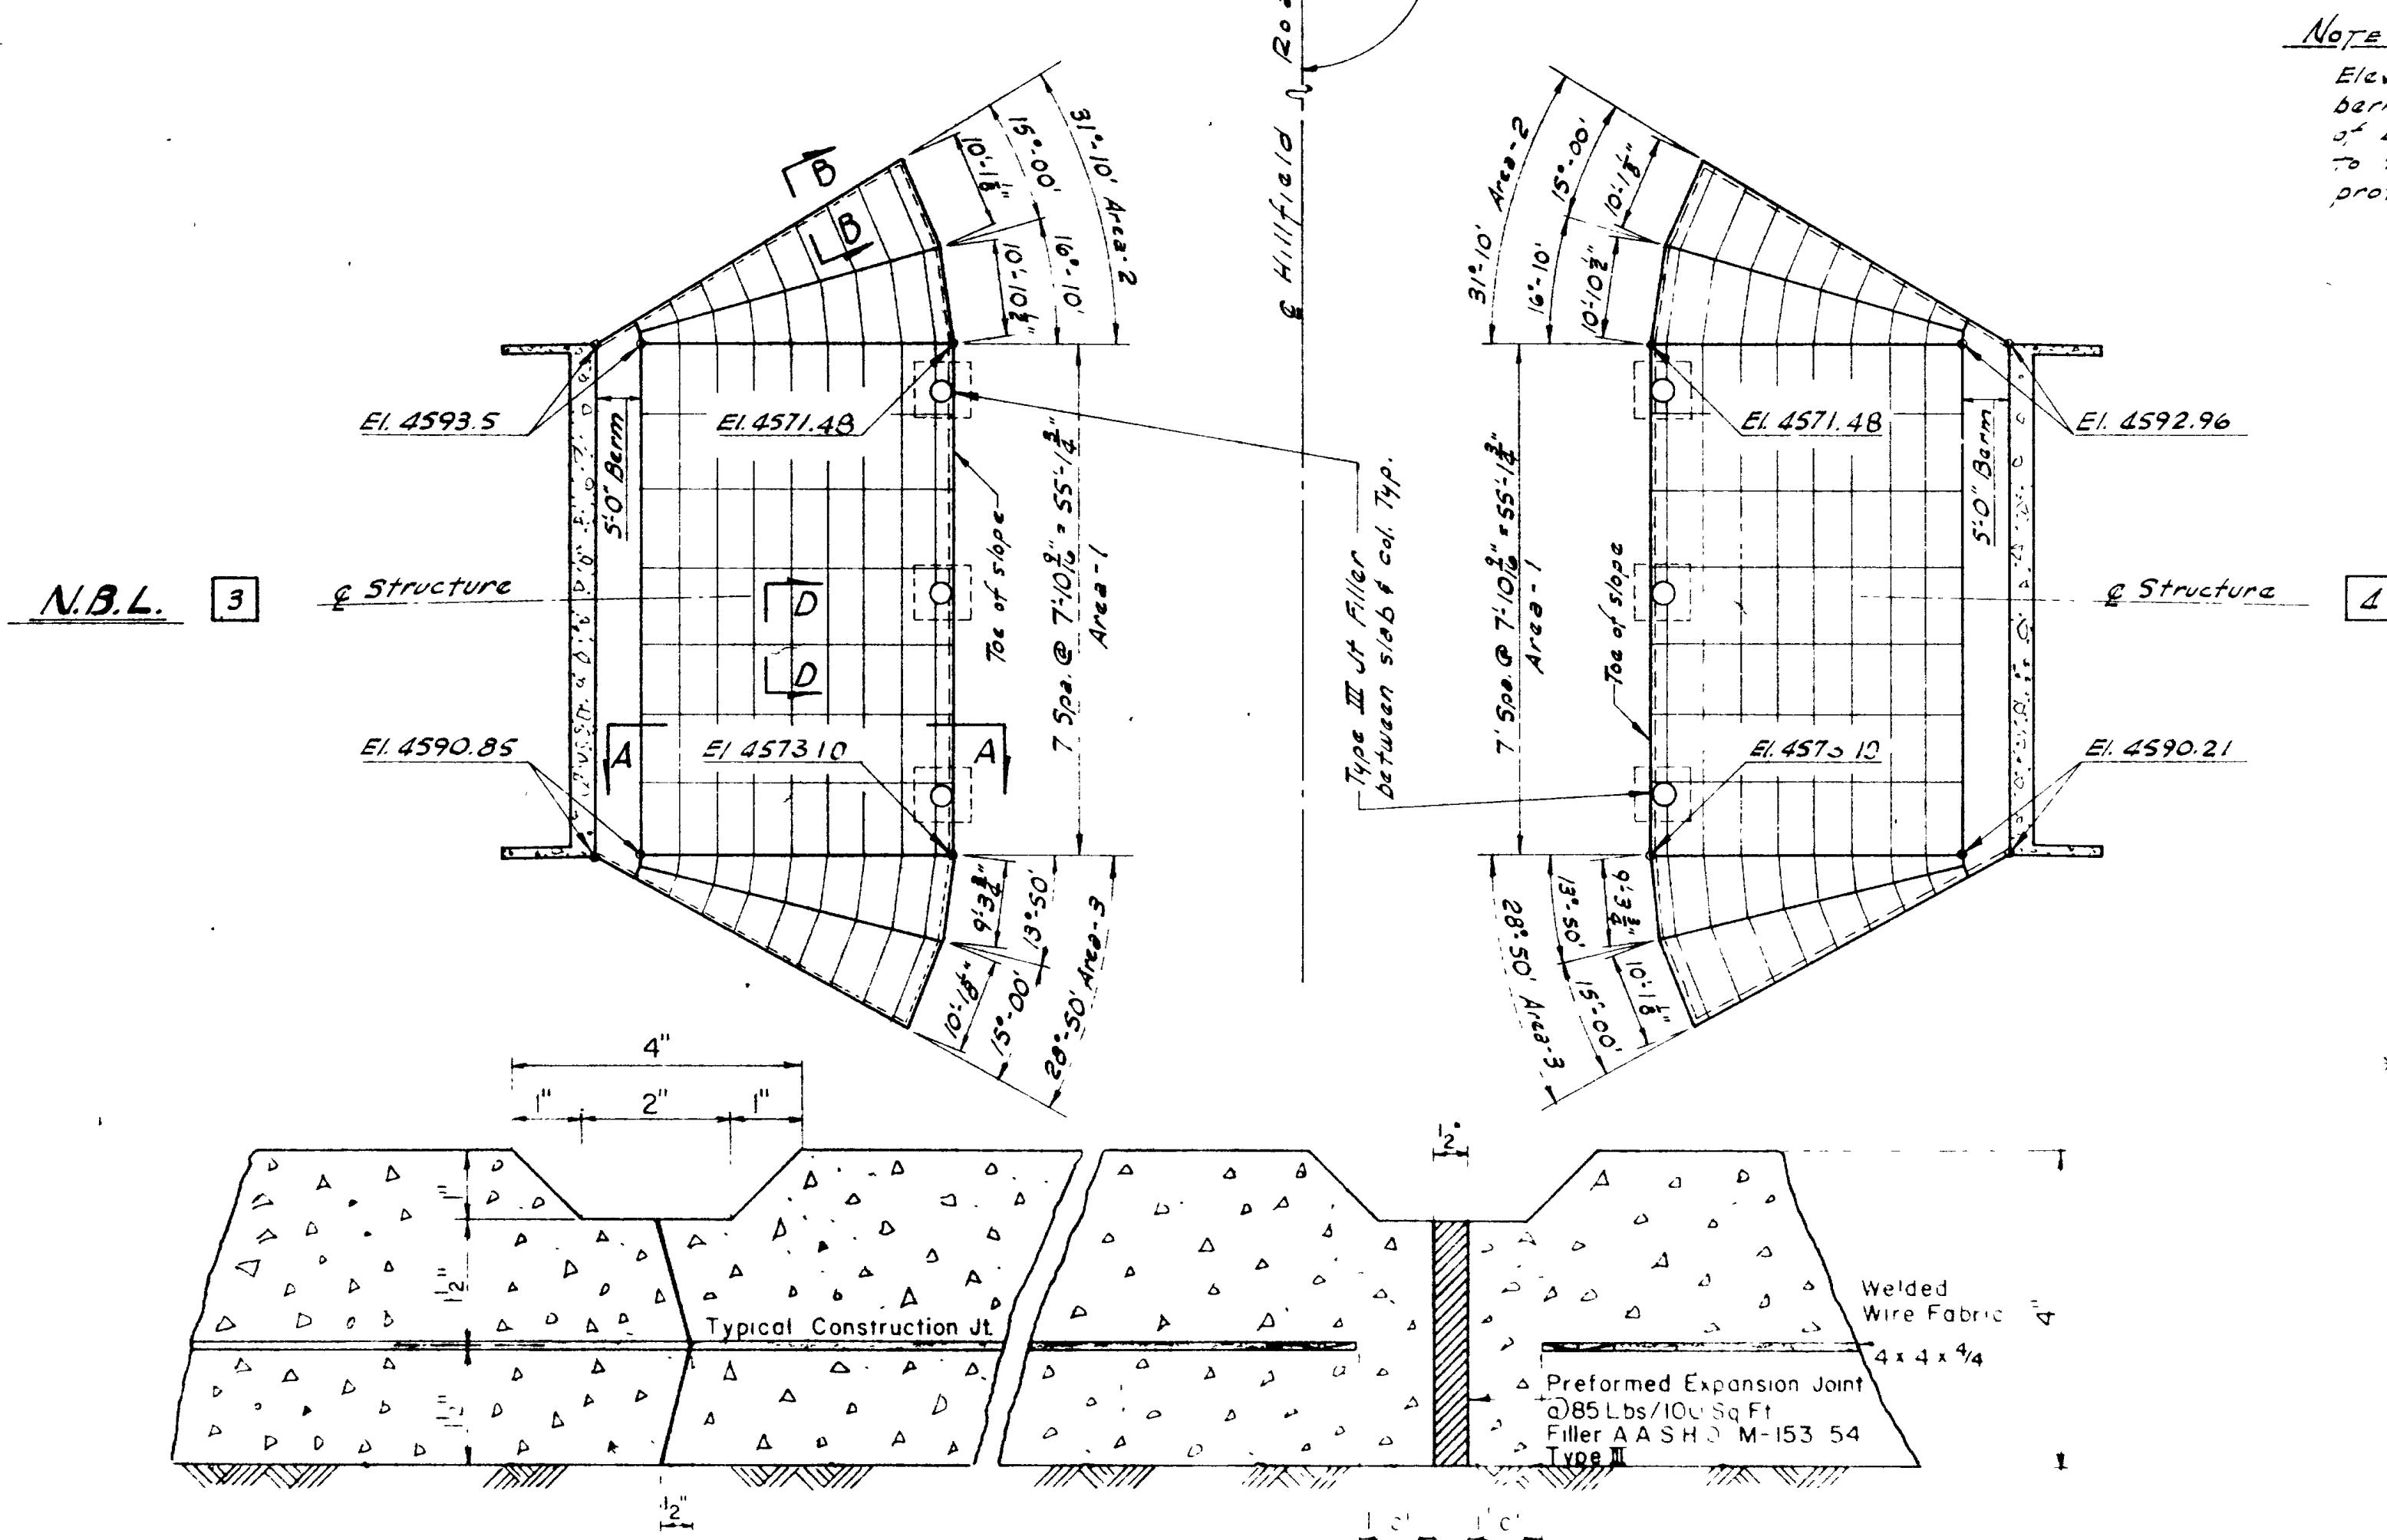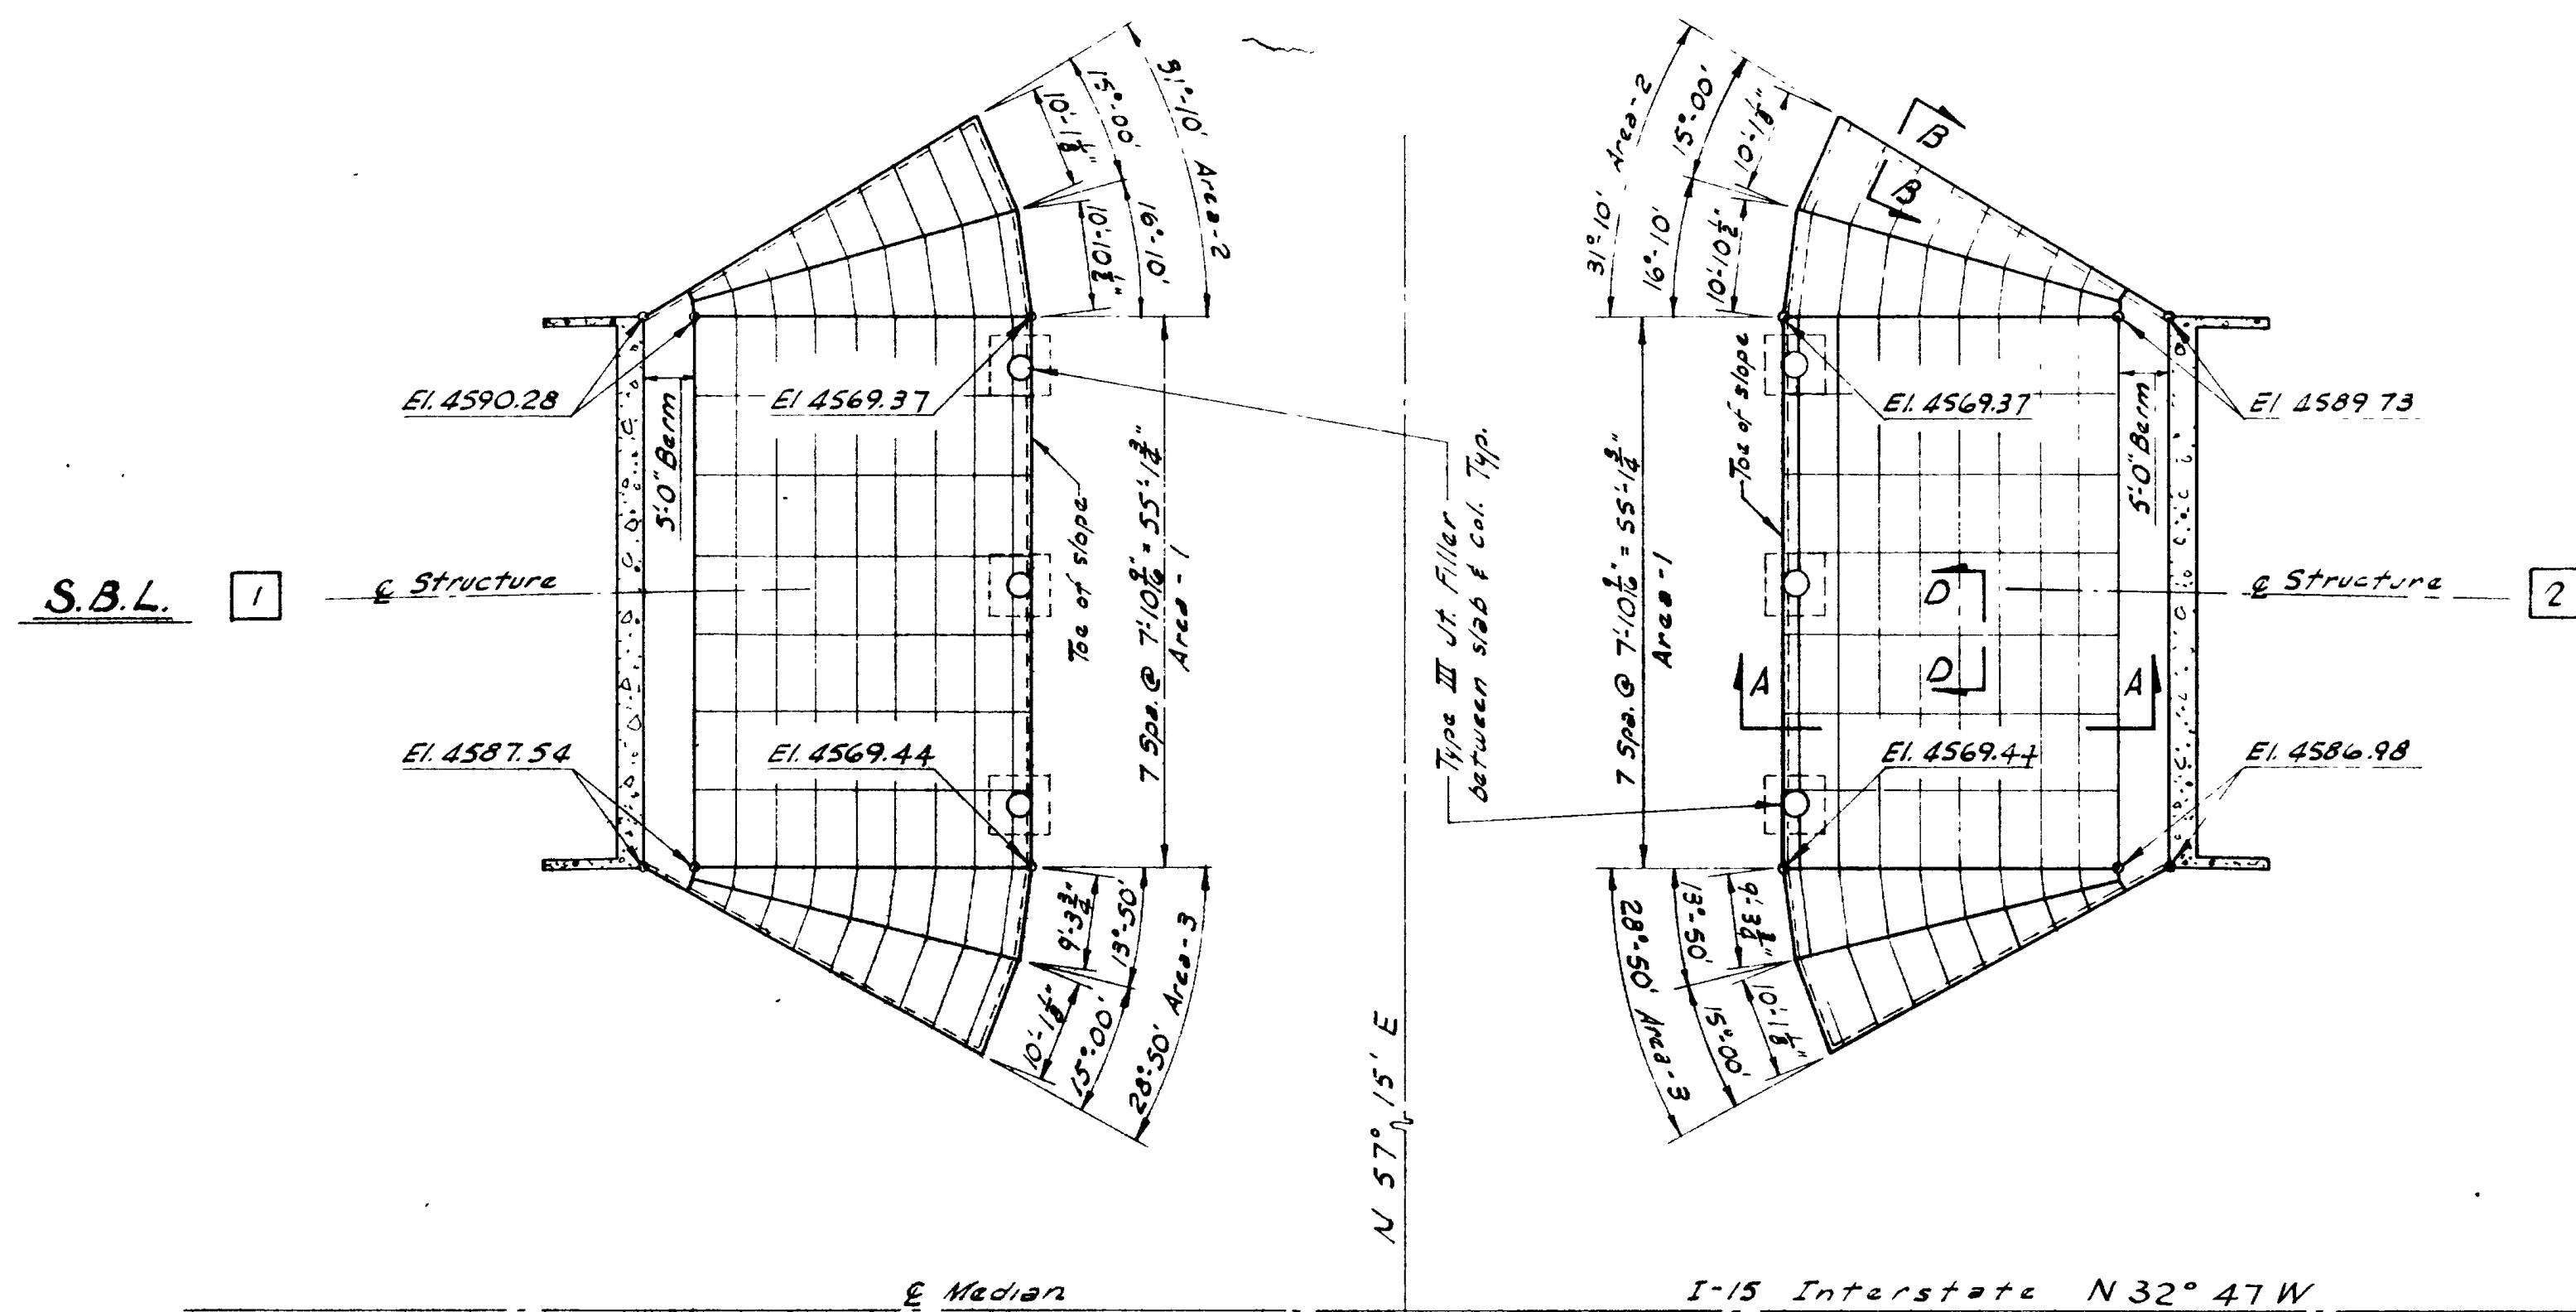


Locate Construction Joints as needed in placing concrete slab

Locate vertical Expansion Joints at 40'-0" max spacing in slab


SECTION C-C

SECTION D-D

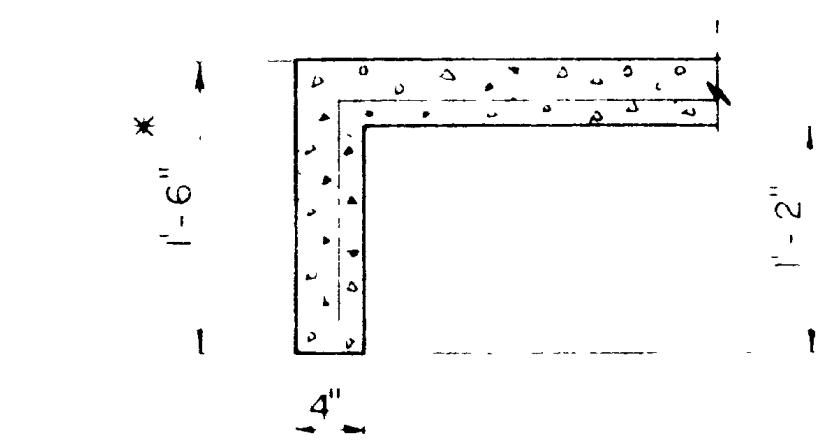

SECTION A-A

* NOTE
Cut off Wall is not included in exposed finished surface

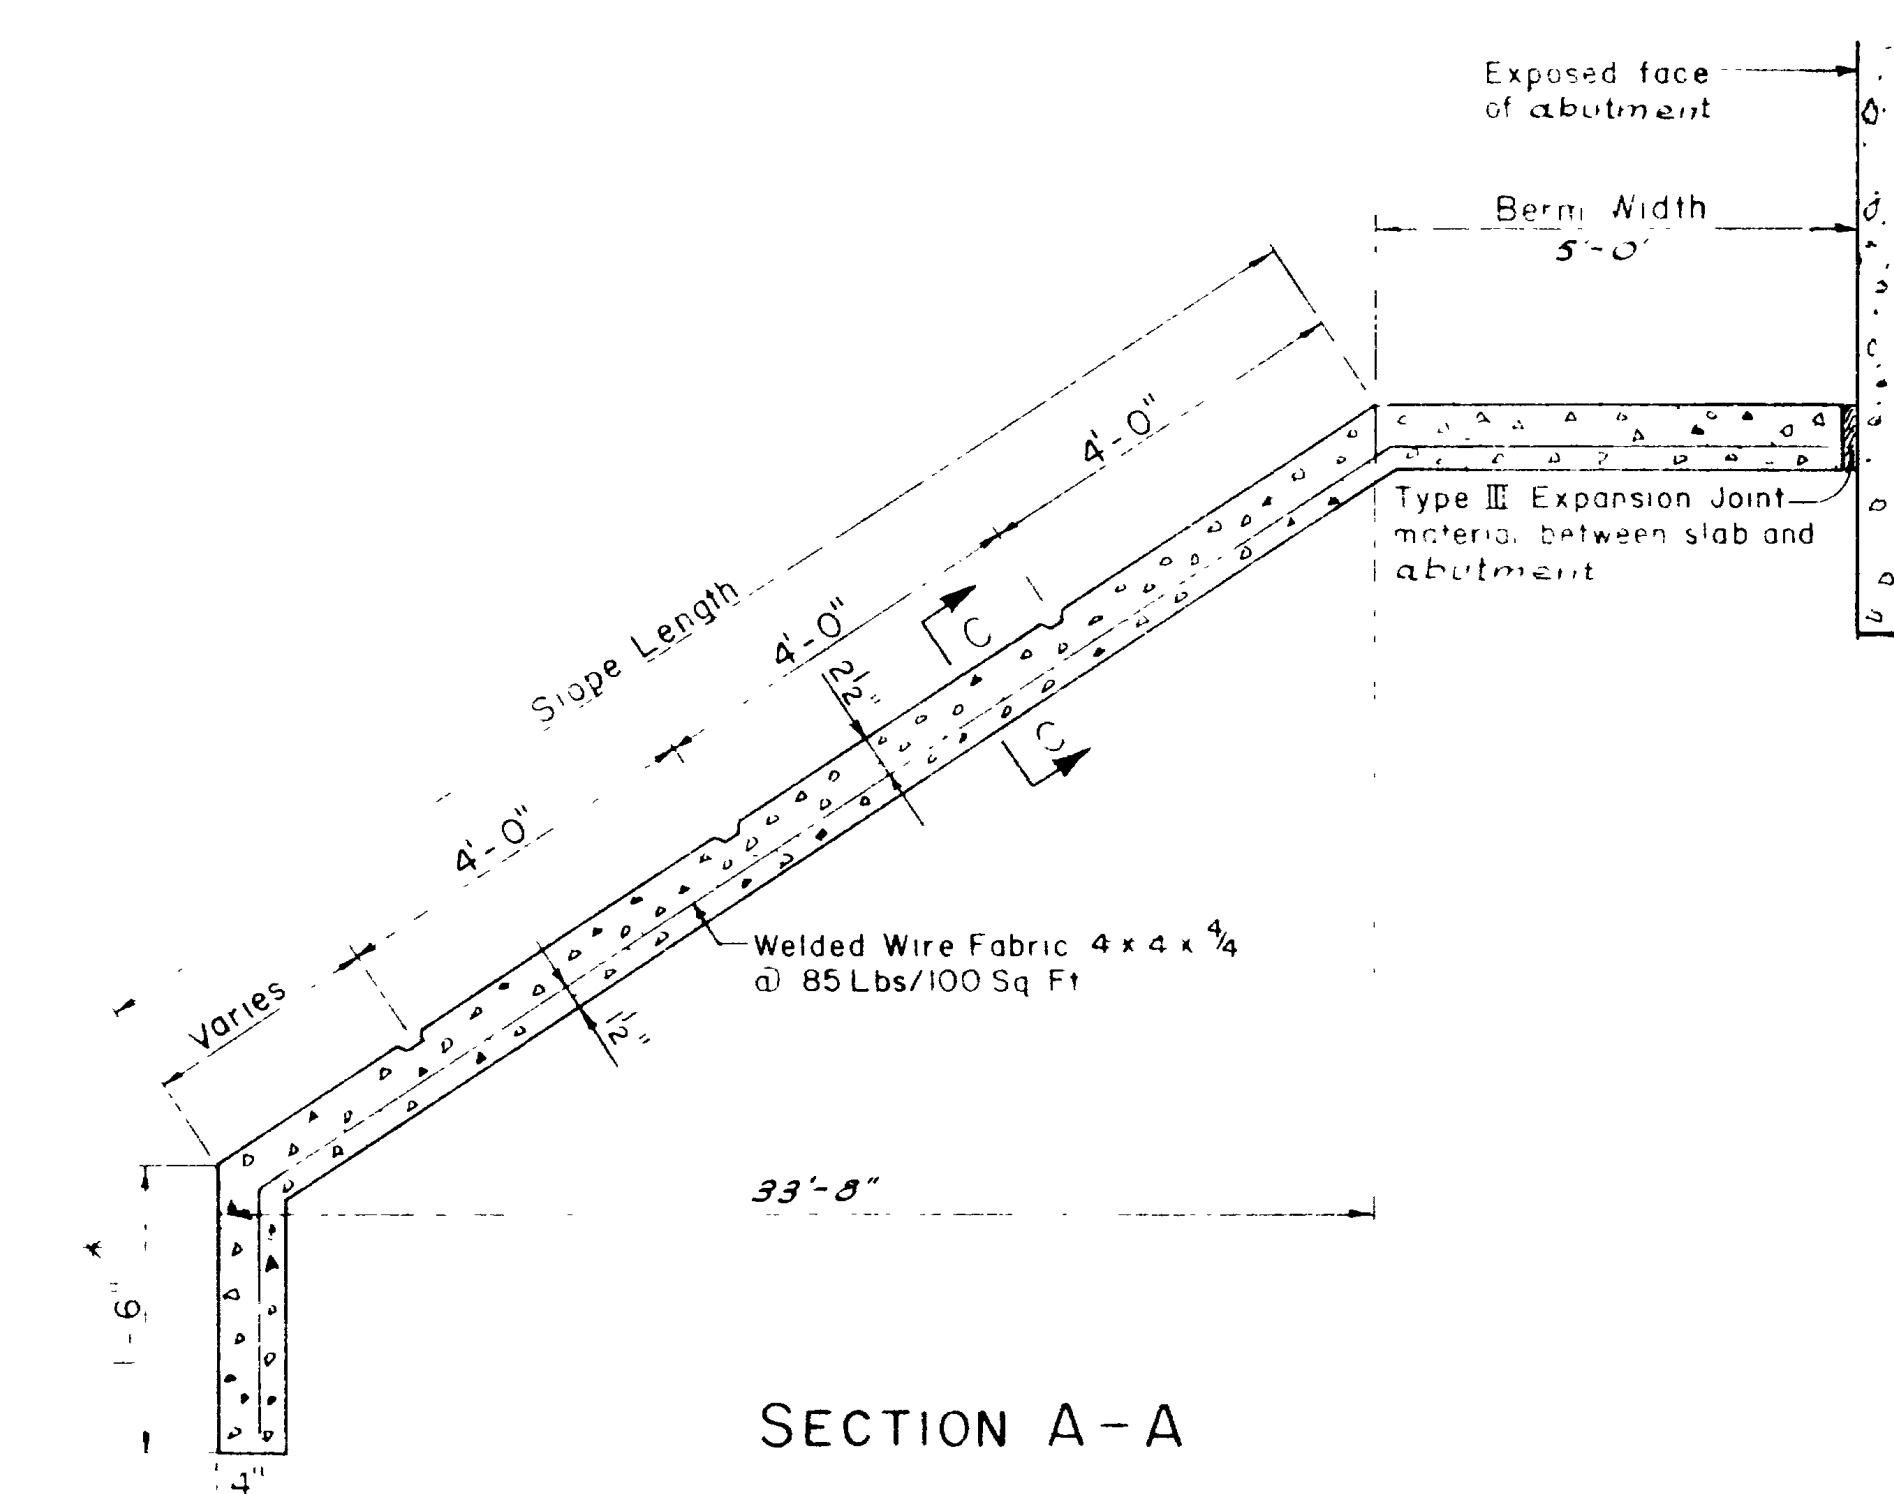


SECTION B-B
(Cut-off wall detail)

UTAH STATE DEPARTMENT OF HIGHWAYS		
STRUCTURES DIVISION		
HILLFIELD INTERCHANGE TO DAVIS-WEBER CO LINE		
HILLFIELD RD INTERCH. OPNS		
REINF CONC SLOPE PROTECTION		
MW	NJC	I-5-7(58)332
HGE WEF	HJS	
HJS		
Mary Christianen		221/5
Aug 2 1983		

D-7-9 11-13


MARK	LOCATION	SIZE NO	LENGTH	NO BARS	TOTAL LENGTH	SKETCH
A1	ABUTMENTS	4	17'-II"	128	2293'-4	
A2		4	27'-10"	48	1336'-0	
A3		6	28'-6"	64	1824'-0	
A4		5	3'-0"	144	432'-0	
A5	ABUTMENTS	4	11'-6"	48	552'-0	
AS1	APPROACH SLAB	4	17'-10"	212	3780'-8	
AS2		7	14'-8"	284	4165'-4	
AS3		4	26'-10"	256	6869'-4	
AS4	APPROACH SLAB	7	27'-2"	24	652'-0	
B1	BEAMS	II	60'-0"	48	2880'-0	
B2		II	45'-6"	24	1092'-0	
B3		II	40'-0"	96	3840'-0	
B4		II	24'-0"	144	3456'-0	
B5		8	53'-7"	72	3858'-0	
B6		4	50'-5"	96	2920'-0	
B7		4	49'-10"	96	4784'-0	
B8		II	42'-0"	48	2016'-0	
B9		II	42'-0"	48	2016'-0	
B10		II	56'-0"	48	2688'-0	
B11		II	51'-6"	96	4944'-0	
B12		4	8'-3"	48	396'-0	
B13		1	8'-5"	404	0' 2"-11"	
B14		8'-7"	412	0' 3"-0"		
B15		8'-7"	412	0' 3"-0"		
B16		8'-9"	420	0' 3'-1"		
B17		8'-11"	428	0' 3'-2"		
B18		9'-1"	436	0' 3'-3"		
B19		9'-3"	444	0' 3'-4"		
B20		9'-3"	444	0' 3'-4"		
B21		9'-5"	452	0' 3'-5"		
B22		9'-7"	460	0' 3'-6"		
B23		9'-9"	468	0' 3'-7"		
B24		9'-11"	476	0' 3'-8"		
B25		10'-1"	484	0' 3'-9"		
B26		10'-3"	492	0' 3'-10"		
B27		10'-3"	492	0' 3'-10"		
B28		10'-5"	500	0' 3'-11"		
B29		10'-7"	508	0' 4'-0"		
B30		10'-9"	516	0' 4'-1"		
B31		10'-11"	524	0' 4'-2"		
B32		10'-11"	524	0' 4'-2"		
B33		11'-1"	532	0' 4'-3"		
B34		11'-3"	540	0' 4'-4"		
B35		11'-5"	48	548	0' 4'-5"	
B36	BEAMS	4	11'-7"	1512	17514'-0 4'-6"	
C1	COLUMNS	II	21'-7"	72	1554'-0	
C2		II	19'-10"	56	1110'-8	
C2a		II	23'-4"	56	1306'-8	
C3		4	7'-11"	268	2121'-8	
C4		II	6'-0"	192	1152'-0	
C5	COLUMNS	5	2'-3"	48	108'-0	
D1	DIAPHRAGMS	4	10'-5"	90	937'-6	
D2	DIAPHRAGMS	5	26'-5"	16	422'-8	
F1	FOOTINGS	II	5'-0"	184	920'-0	
F2		8	9'-6"	480	4560'-0	
F3		6	14'-6"	48	696'-0	
F4	FOOTINGS	4	6'-4"	72	456'-0	
H1	CAPS	5	12'-6"	368	4600'-0	
H2		II	51'-0"	16	816'-0	
H3		10	51'-0"	16	816'-0	
H4		II	12'-0"	24	288'-0	
H5		10	12'-6"	40	500'-0	
H6		10	8'-3"	24	198'-0	
H7	CAPS	4	25'-11"	32	829'-4	
P1	PARAPETS	4	2'-11"	796	2321'-8	
P2						
P3						
P4						
P5						
P5a						
P5b						
P5c						
P5d						
P6						
P7						
P8						
P8a						
P9						
P10	PARAPETS	4	4'-2"	8	33'-4"	
S1	DECK SLAB	5	56'-6"	370	20805'-0	SEE SKETCH SI
S2		1	54'-10"	740	40576'-8	
S3		1	40'-9"	640	26080'-0	
S4		1	26'-3"	48	1260'-0	
S5	DECK SLAB	5	33'-0"	48	1584'-0	
SKETCH SI						
REVISIONS						
NO BY DATE						
REMARKS						
BR NO						
D-719						
12 OF 13						

65,512'-2" OF #4 BARS @ 0.668#/FT = 43,762 LB
 96,883'-0" OF #5 BARS @ 1.043#/FT = 101,048 LB
 5,357'-4" OF #6 BARS @ 1.502#/FT = 8,046.7 LB<br

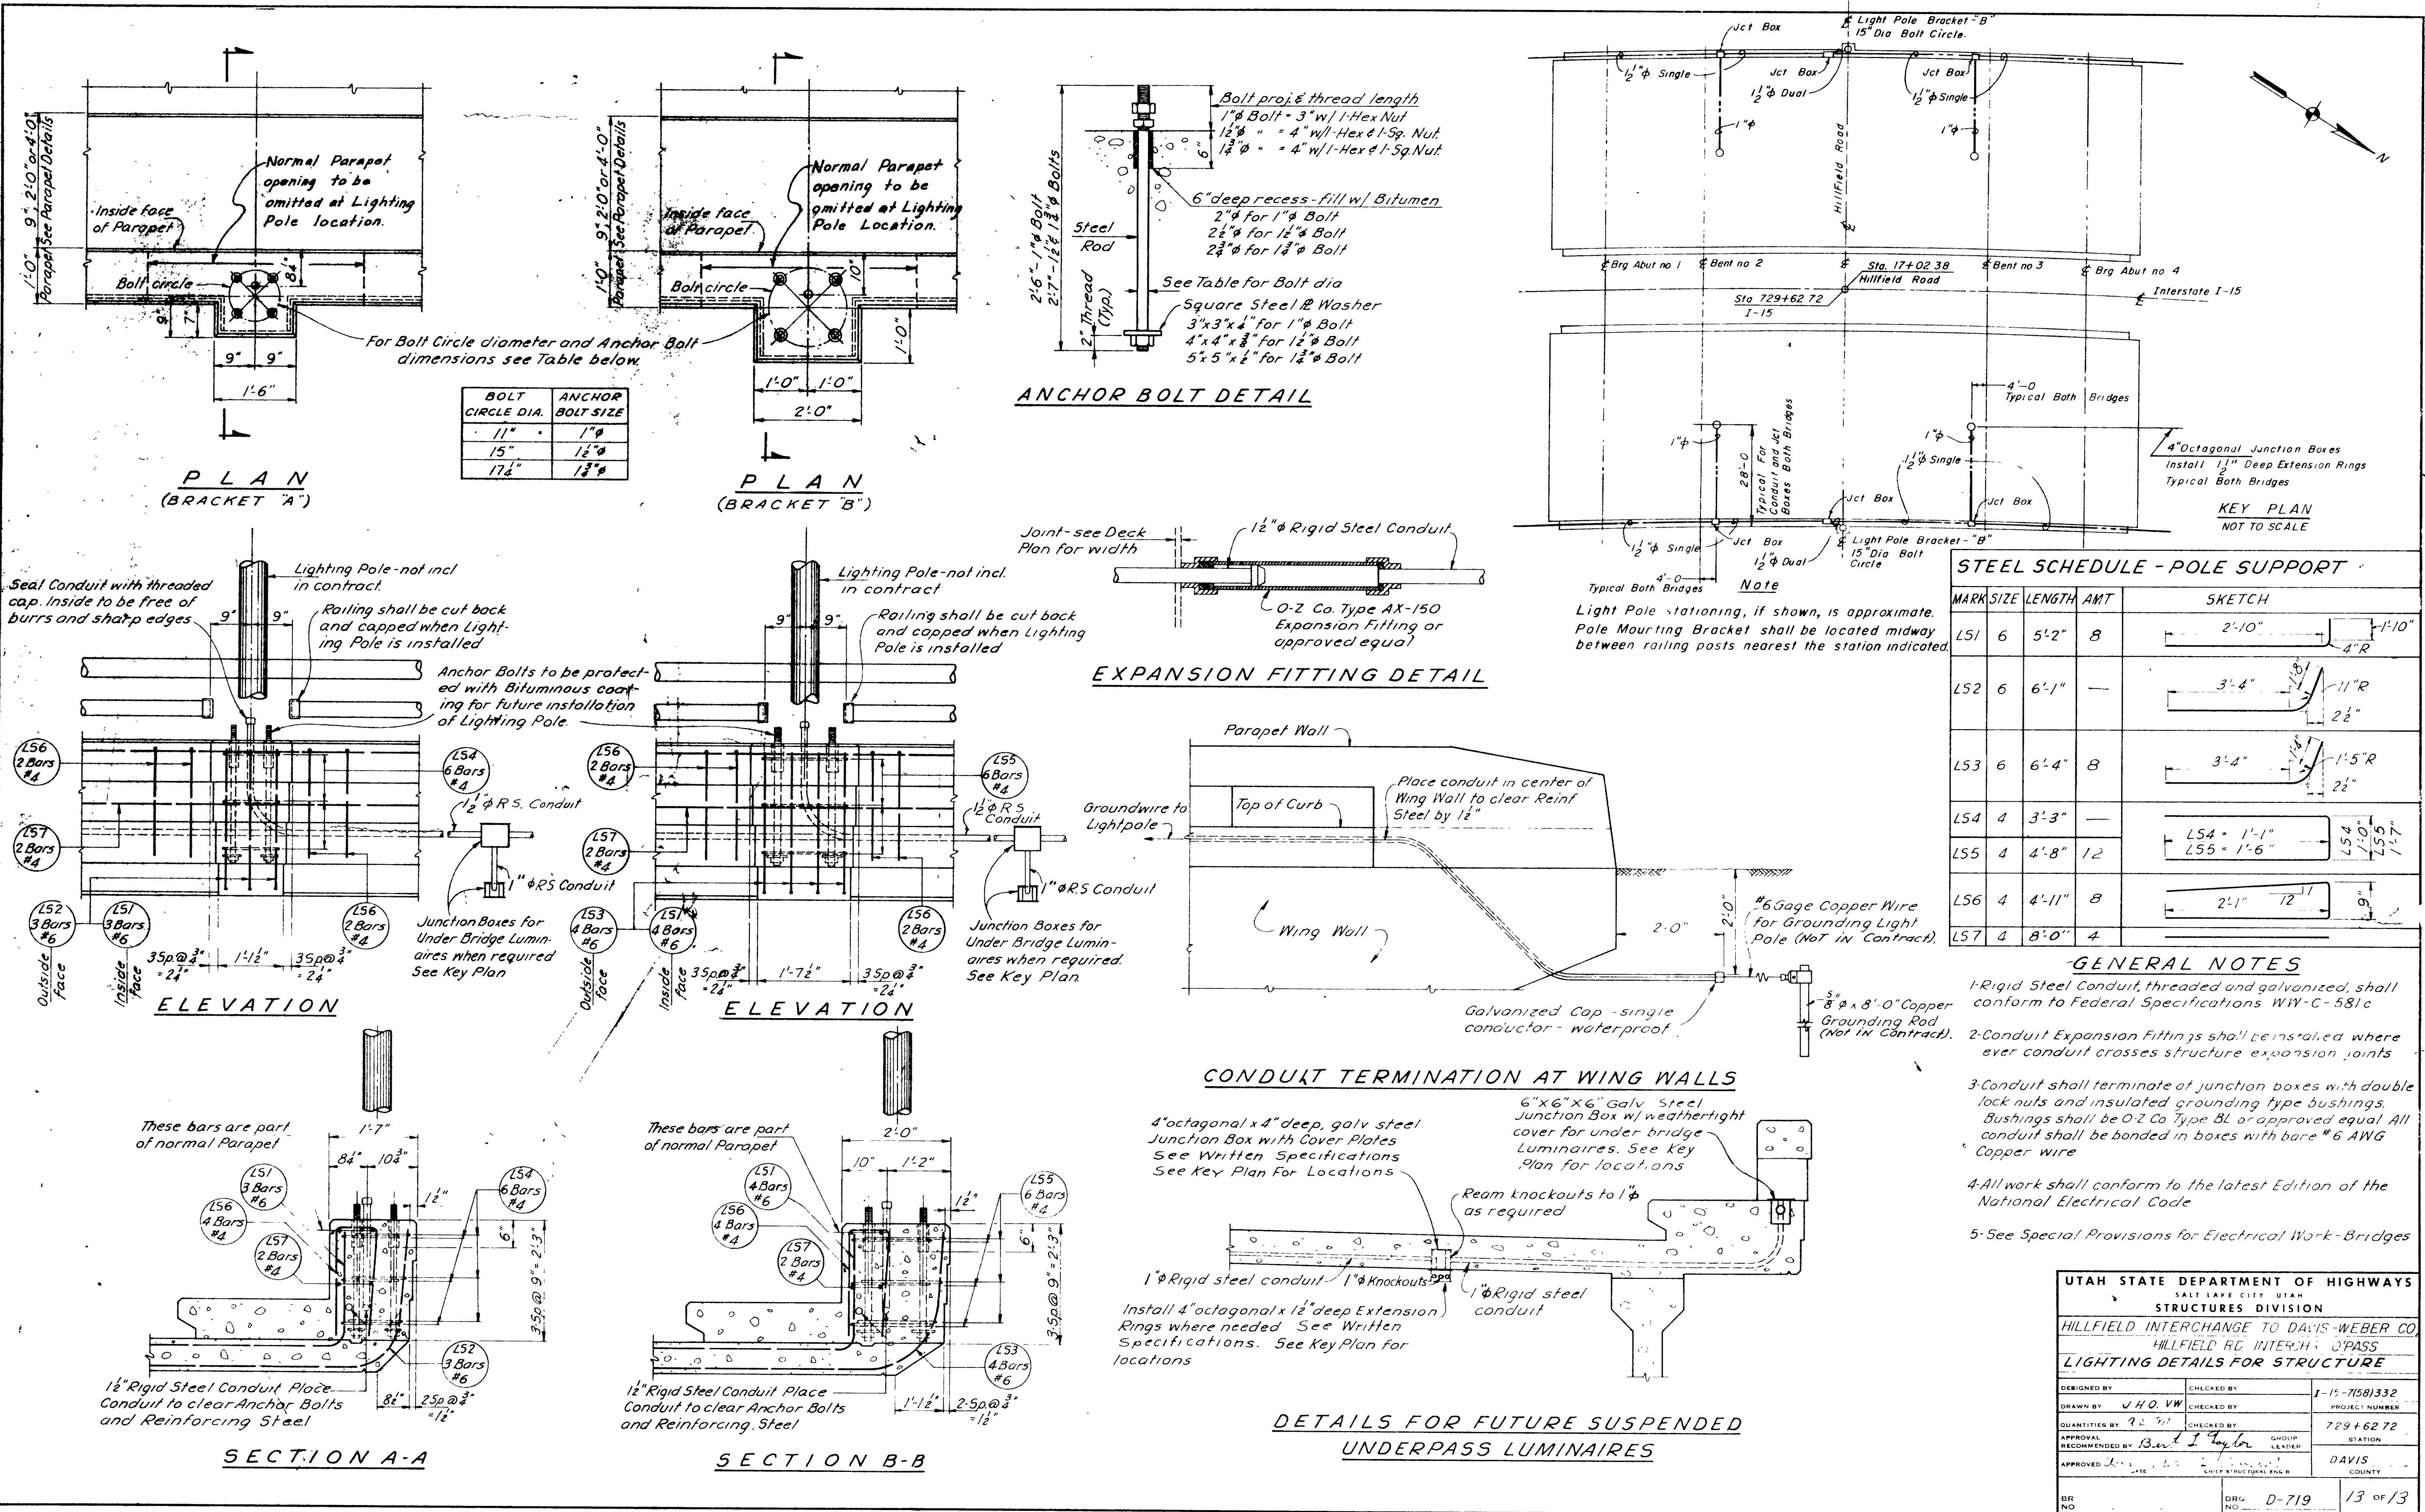

FED. ROAD DIST. NO.	STATE	FED. AID PROJ. NO.	FISCAL YEAR	SHEET NO.	TOTAL SHEETS
UTAH	UTAH	I-15-7(58) 332 I-15-8(20) 334	1963	1	1

IG-15-8(18) 334

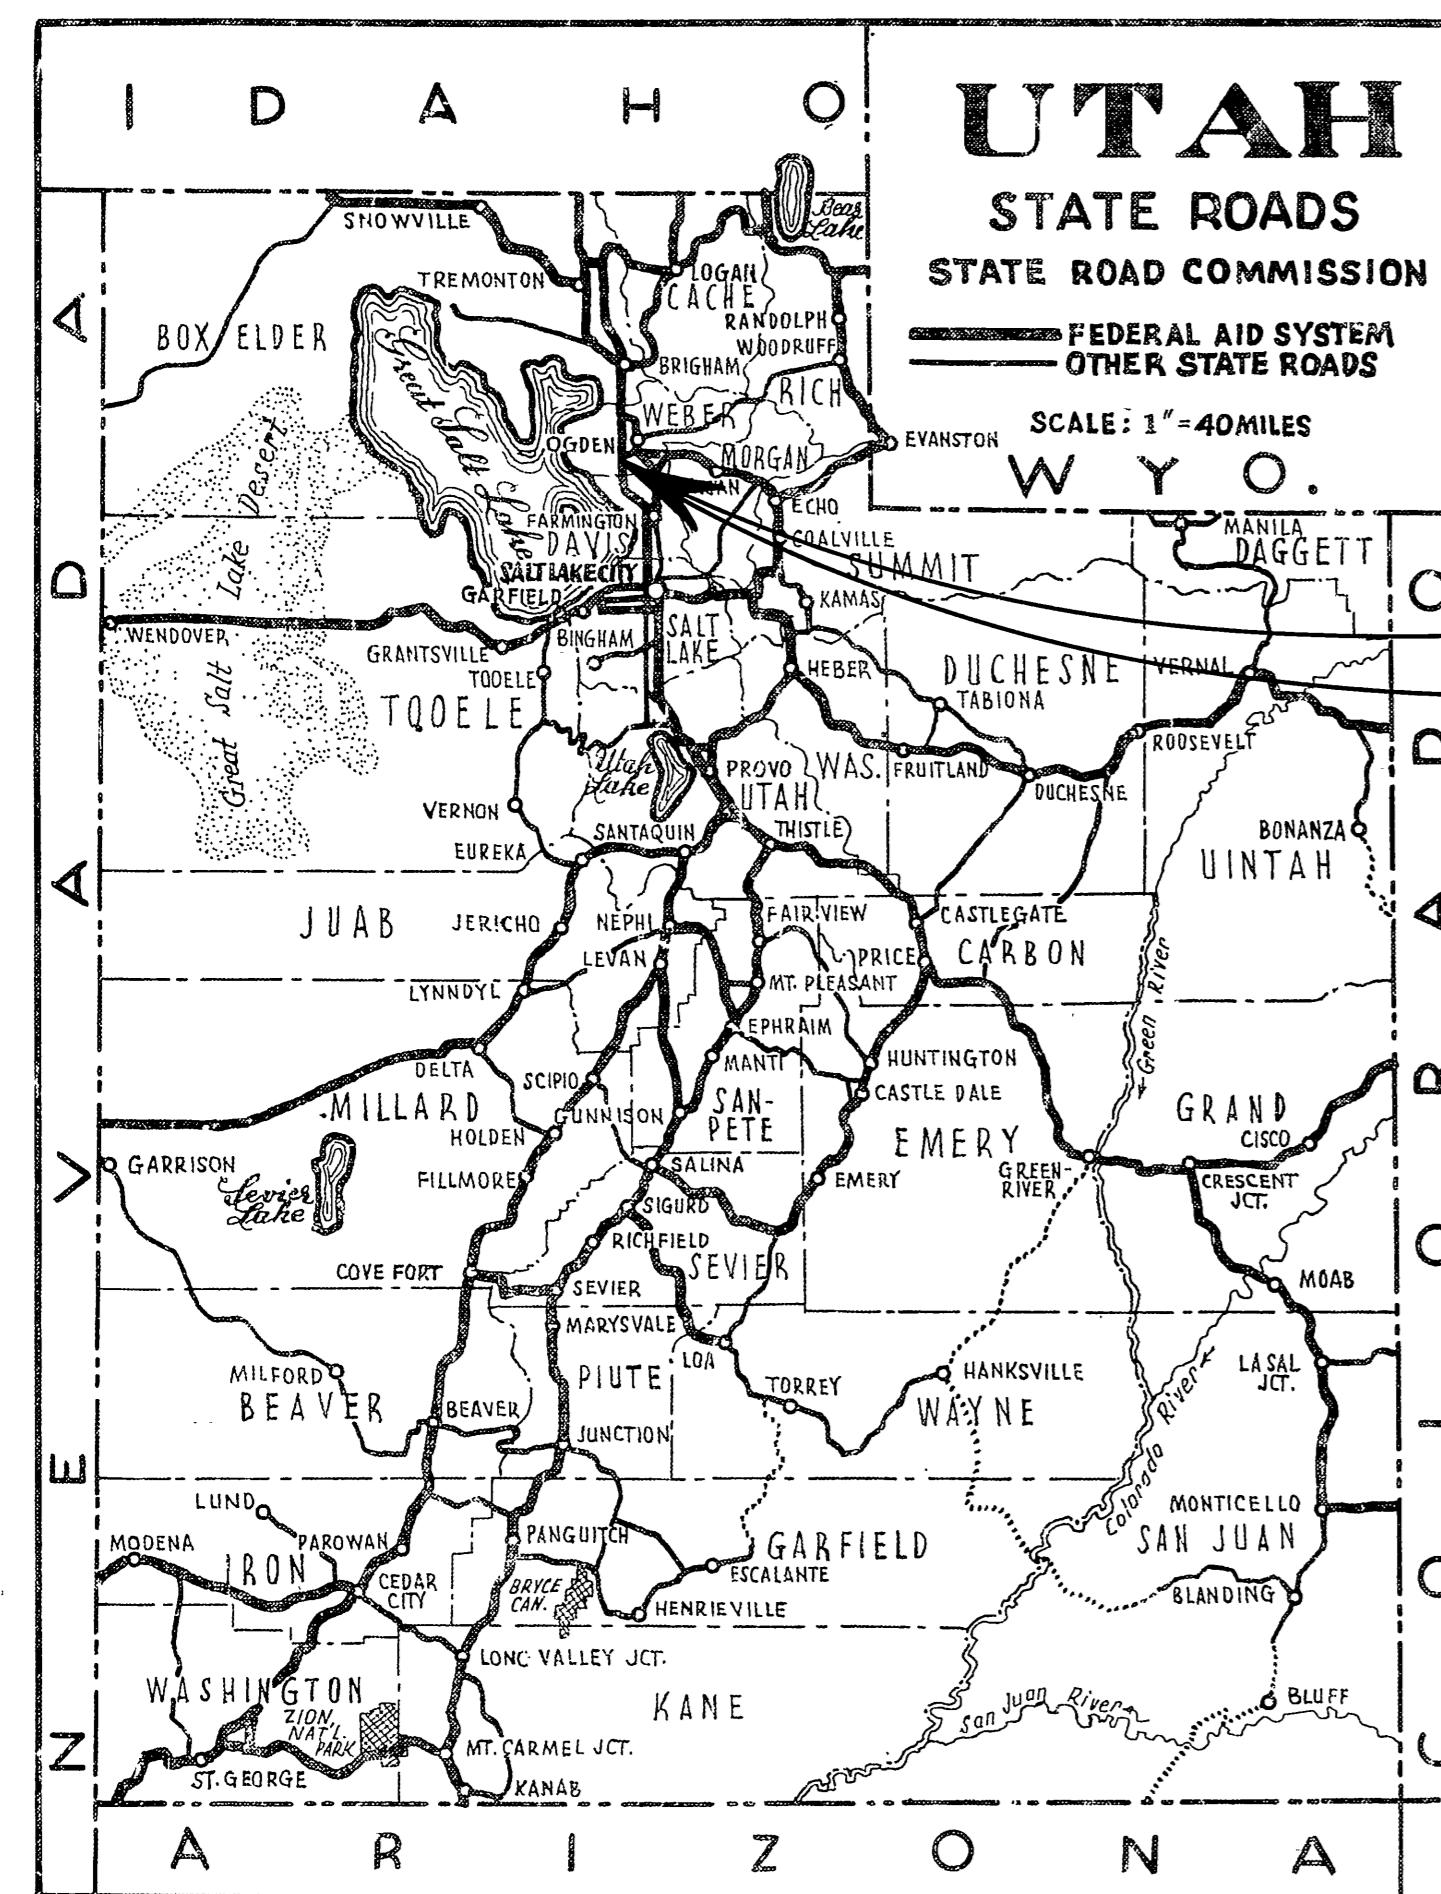

I-15-7(58) 332
I-15-8(20) 334
IG-15-8(18) 334

STATE OF UTAH STATE ROAD COMMISSION

PLANS OF PROPOSED STATE ROAD

FEDERAL AID PROJECT


I-15-7 (58) 332
LENGTH = 2.585 MILES
DAVIS COUNTY

I-15-8 (20) 334
LENGTH = 2.043 MILES
WEBER COUNTY

IG-15-8(18) 334
LENGTH = 0.380 MILES
WEBER COUNTY

INDEX TO SHEETS

SHEET NO.	DESCRIPTION	DRAWING NO.	STATION
1	TITLE SHEET		
2-A-C	TYPICAL SECTIONS & MATLS. SHT.		
3-A-E	SUMMARY SHEETS		
4-31	PLAN AND PROFILE		
32-44	HILL FIELD OVERPASS	D-719	794-6272
45-69	UPRR. OVERPASS	F-80	854-470
70-95	5600 SOUTH OVERPASS	F-66	859-4730
96-101	5600 SOUTH CANAL X-ING	D-744	121-073600
102-131	RIVERDALE ROAD UNDERPASS	C-453	304-44380
132-145	4400 SOUTH UNDERPASS	D-735	955-2884
146	STD. RAILING DETAILS	MR-1	
147	CONCRETE PILES	SP-1	
148	STD. STEEL DETAILS	SS-3	
149	STD. CATCH BASINS	V-752	
150	STD. CATCH BASINS	V-753	
151	STD. CLEANOUT BOXES	V-777	
152-156	STD. ROAD SIGNS	500-1-5	
157	STD. FLARED END SEC. R.C.P.	B-160-1	
158	RIGHT OF WAY MARKERS	B-164	
159	SUPERELEVATION & WIDENING	202	
160	LEFT TURN MEDIANES	211	
161	CONCRETE CURB & GUTTER	220	
162	DEEP BEAM GUARD RAIL	230	
163	R.C.P. CULVERTS	320	
164	DROP INLETS	346	
165	CONSTRUCTION IDENT. SIGNS	504	
166	CHAIN LINK FENCE	523	

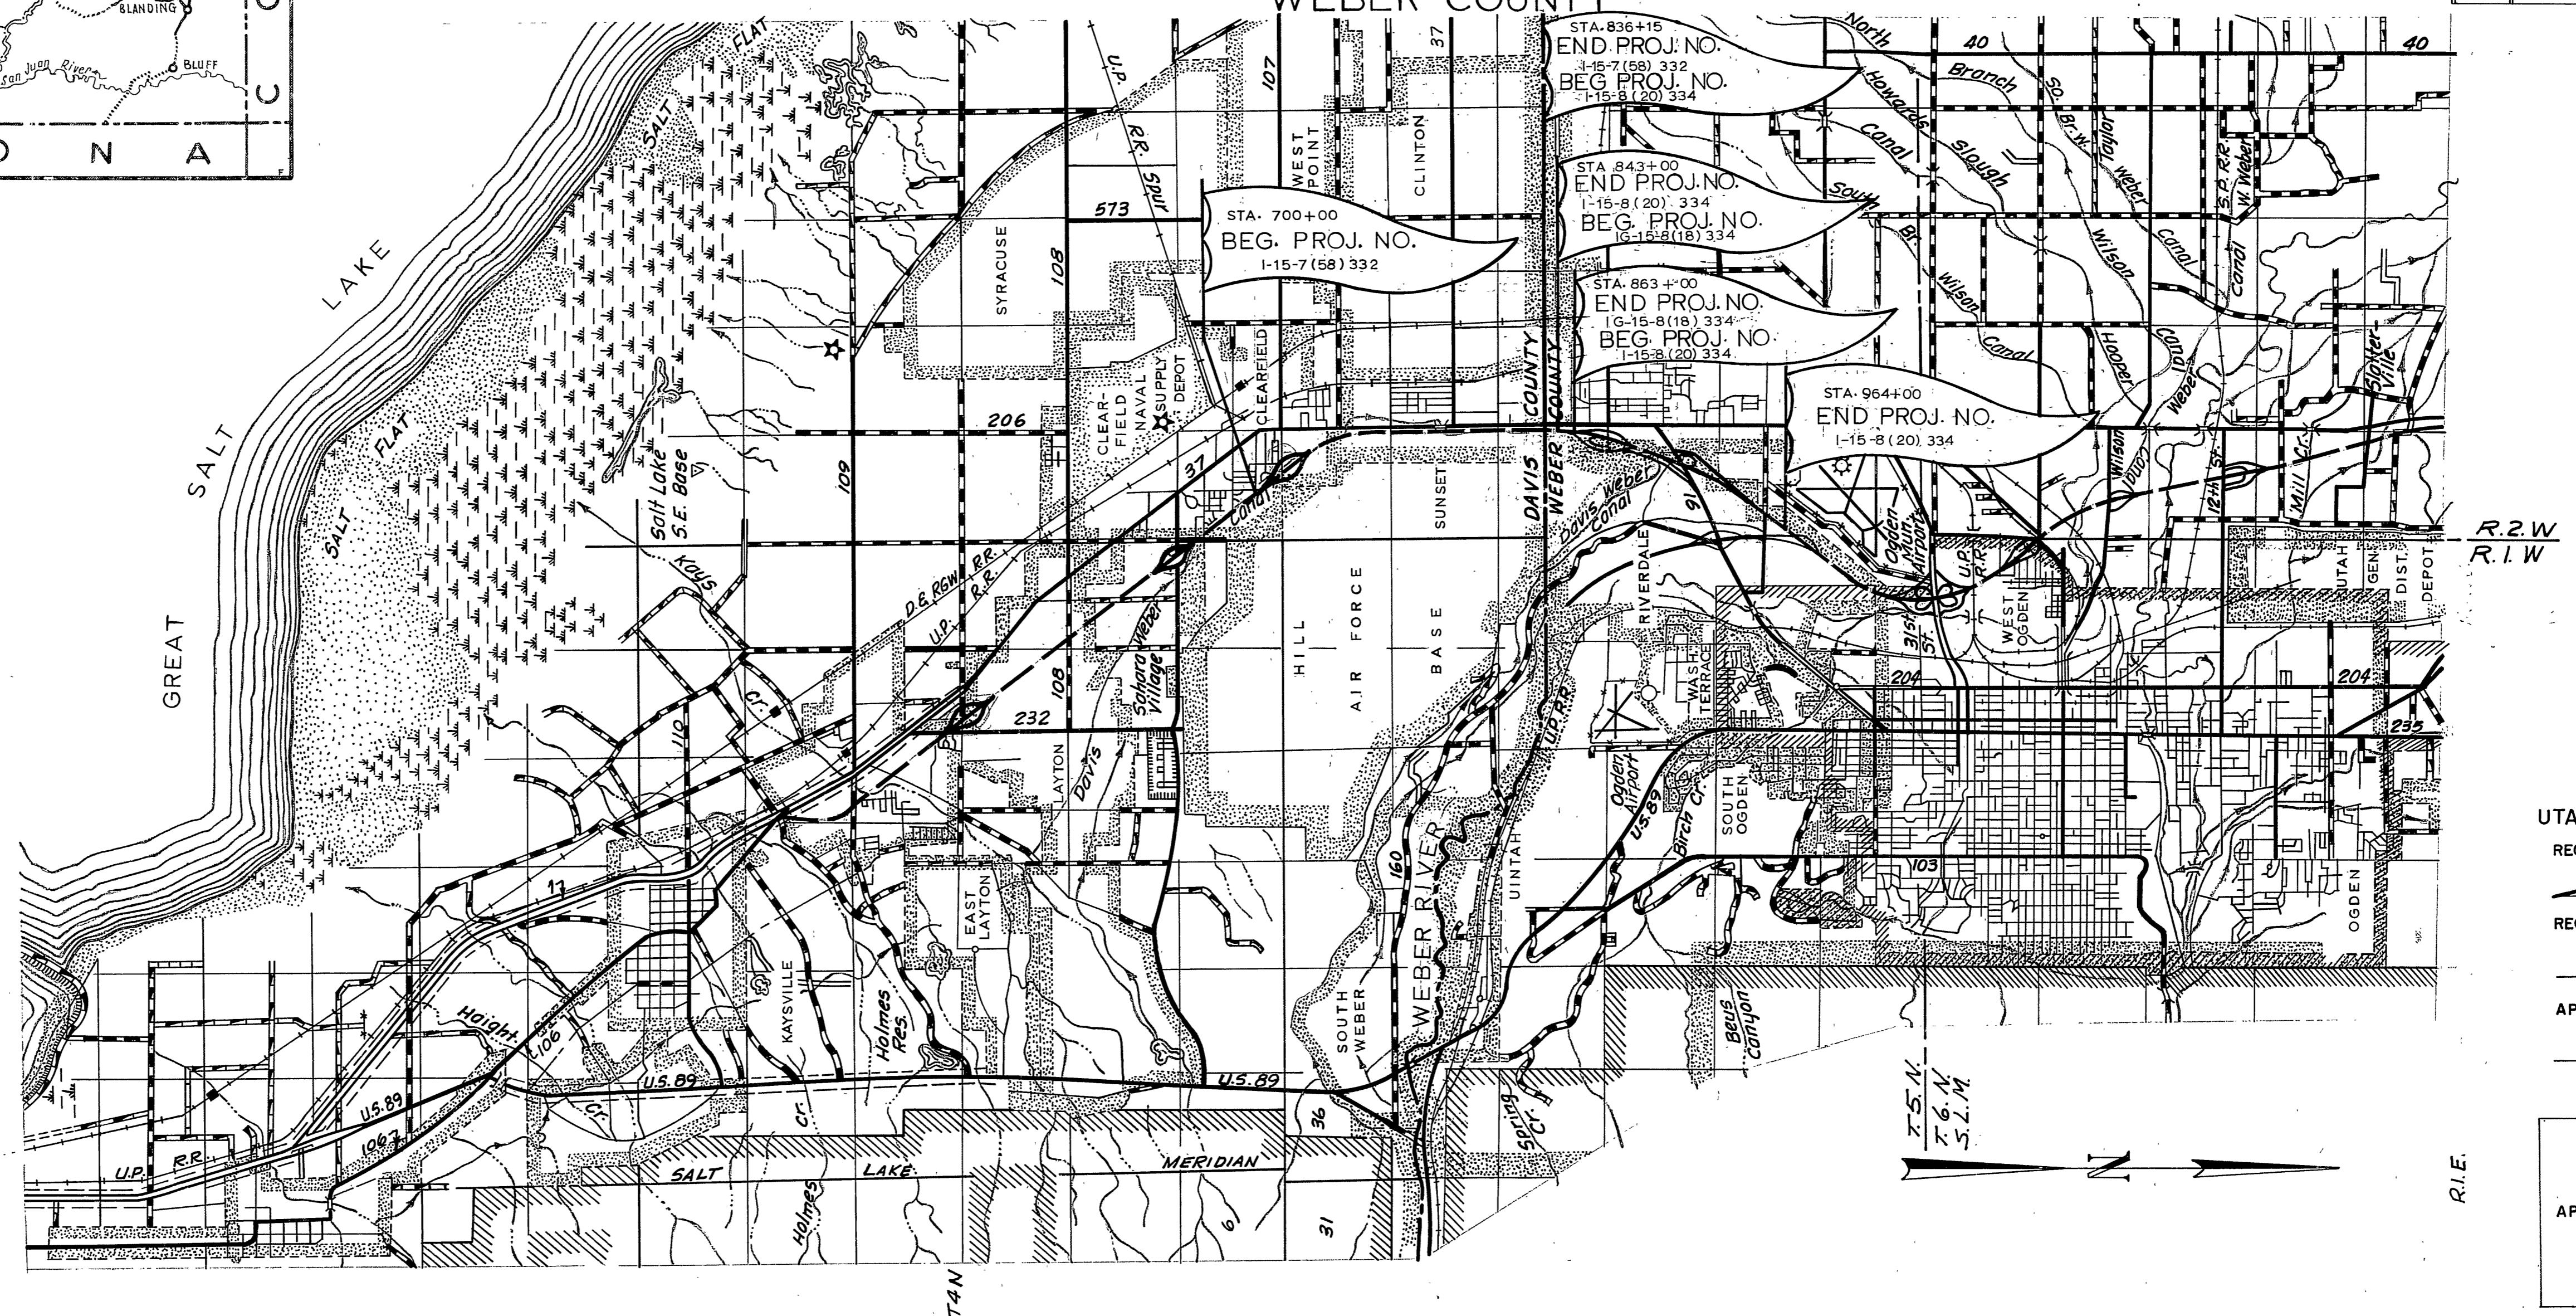

UTAH STATE DEPARTMENT OF HIGHWAYS
RECOMMENDED FOR APPROVAL: AUG., 1963

John H. Knutson
ENGINEER OF ROADWAY DESIGN
RECOMMENDED FOR APPROVAL: AUG., 1963

Blaine J. Kay
ENGINEER OF PLANS AND CONTRACTS
APPROVED: AUG., 1963

James C. Marshall
ACT. DIRECTOR OF HIGHWAYS


DEPARTMENT OF COMMERCE BUREAU OF PUBLIC ROADS
APPROVED:
DIVISION ENGINEER
DATE

TYPICAL SECTIONS

2


FED ROAD DIST NO.	STATE	PERIOD NO.	FISCAL YEAR	THREE YR	TOTAL
UTAH	UTAH	I-15-7(58) 332 I-15-8(20) 334 IG-15-8(18)334		2	

NO. 1

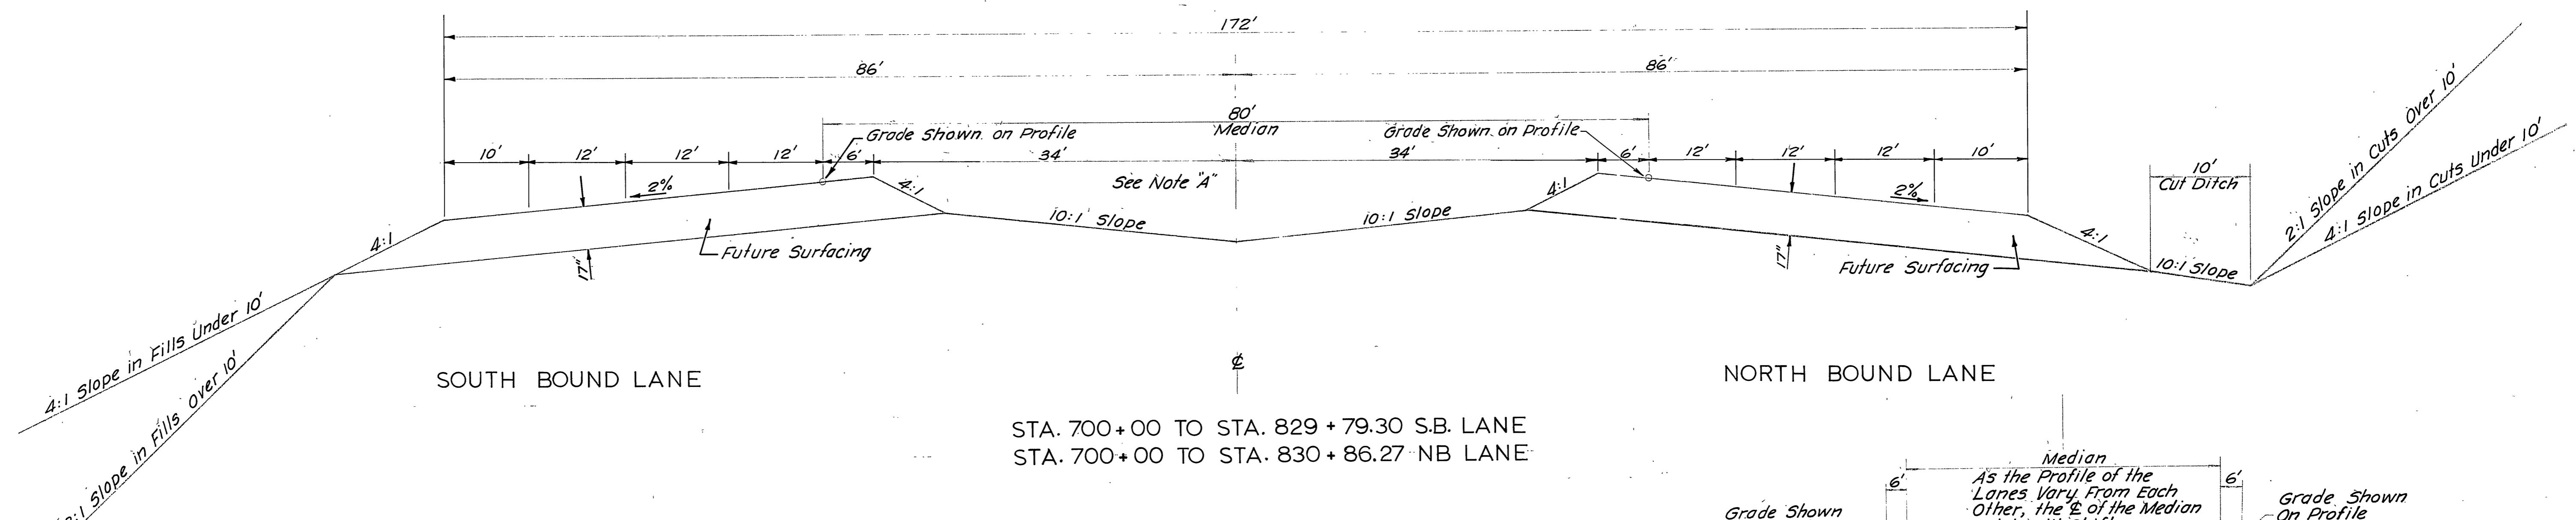


NOTE "B"
Median Width Varies From
80' to 40' In Transition
Through Curve. See Sheet
Number 13 For Details.

NO. 2

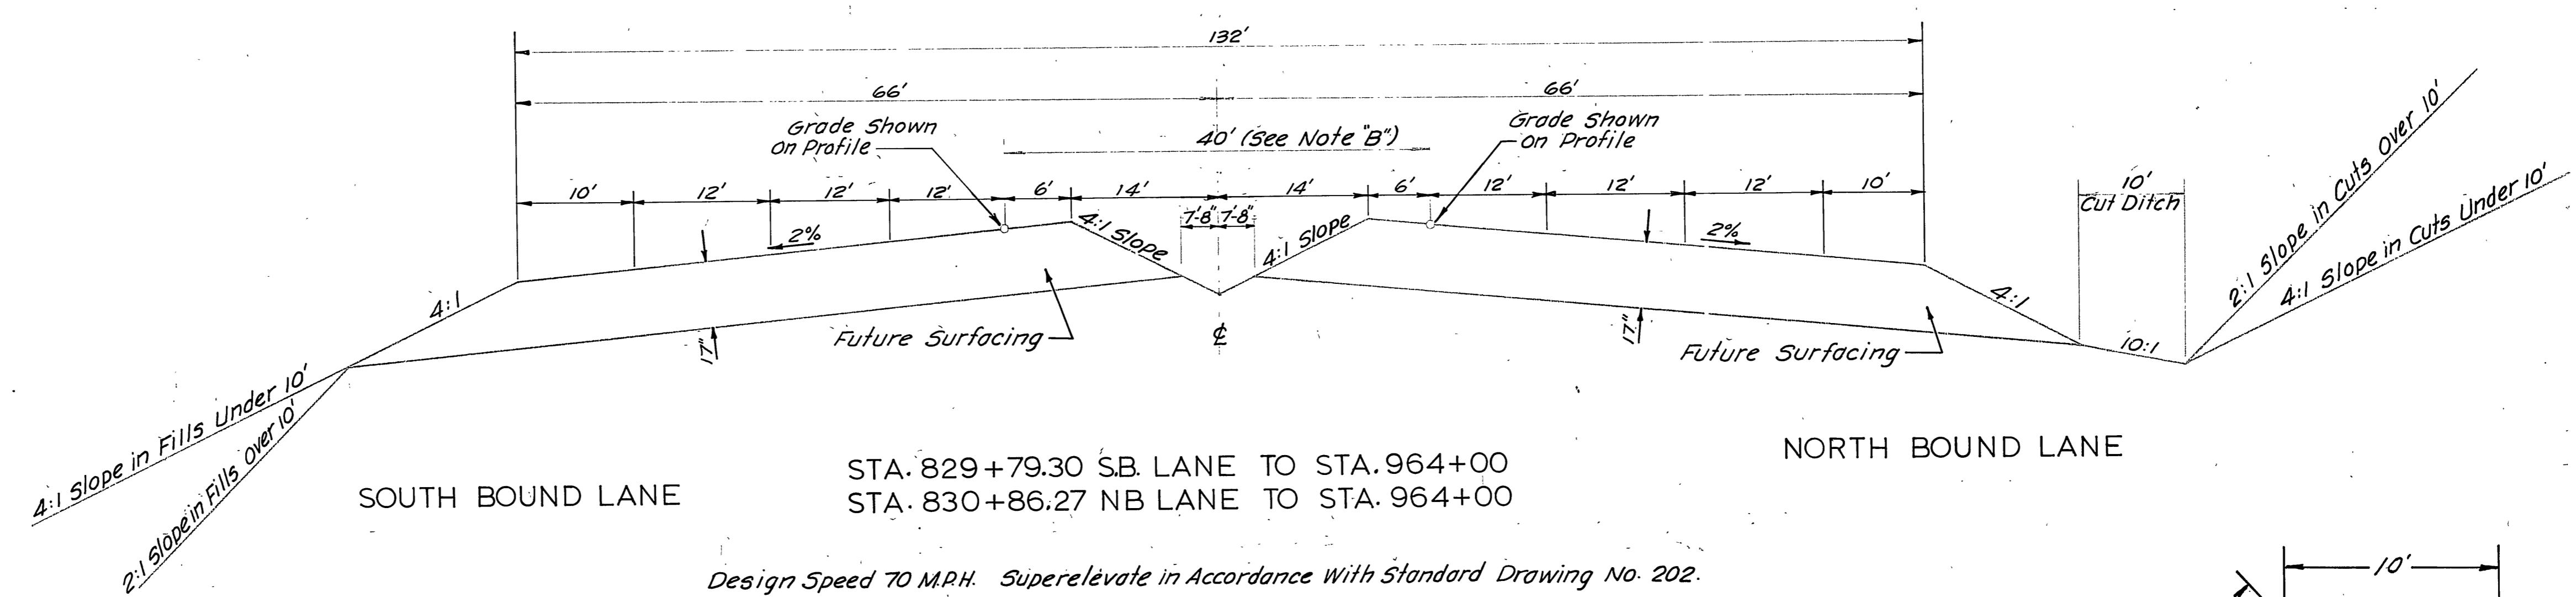

NOTE





SURFACING OF INTERSTATE NOT INCLUDED IN THIS CONTRACT.

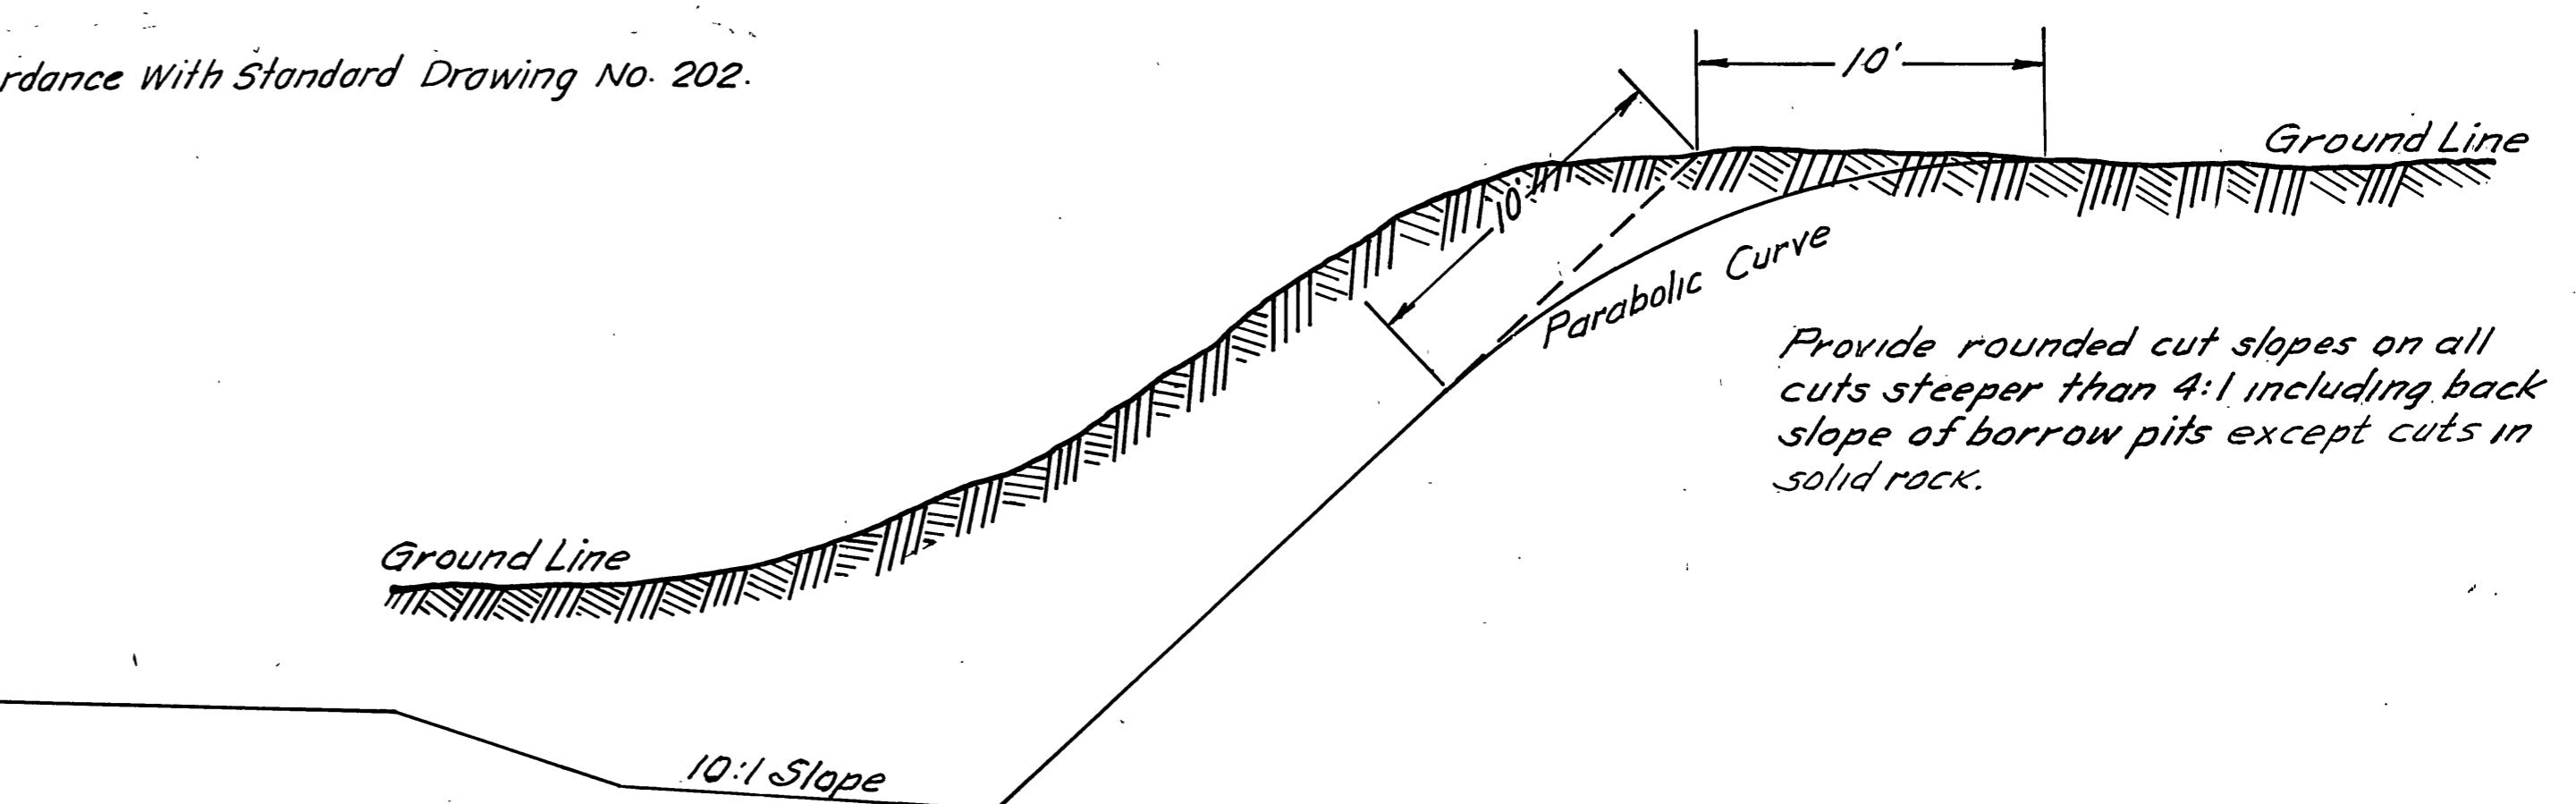


TYPICAL SECTIONS

FED. ROAD DIST. NO.	STATE	PROJ. NO.	FISCAL YEAR	HEET NO.	TOTAL SHEETS
UTAH	UTAH	I-15-7(58)332 I-15-8(20)334	2-A		

REV. 9-16-63

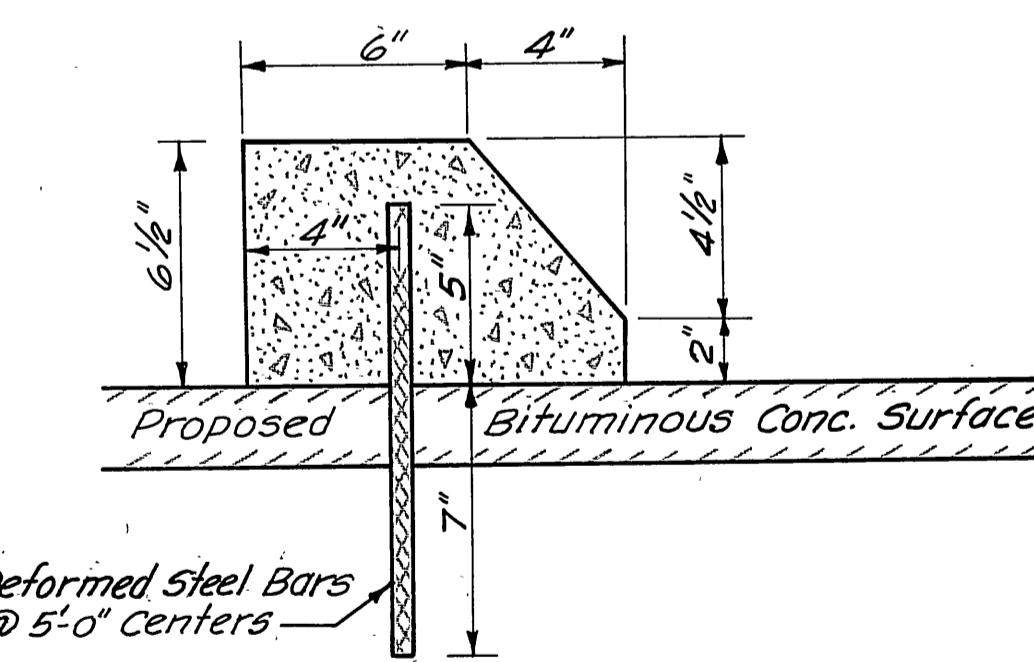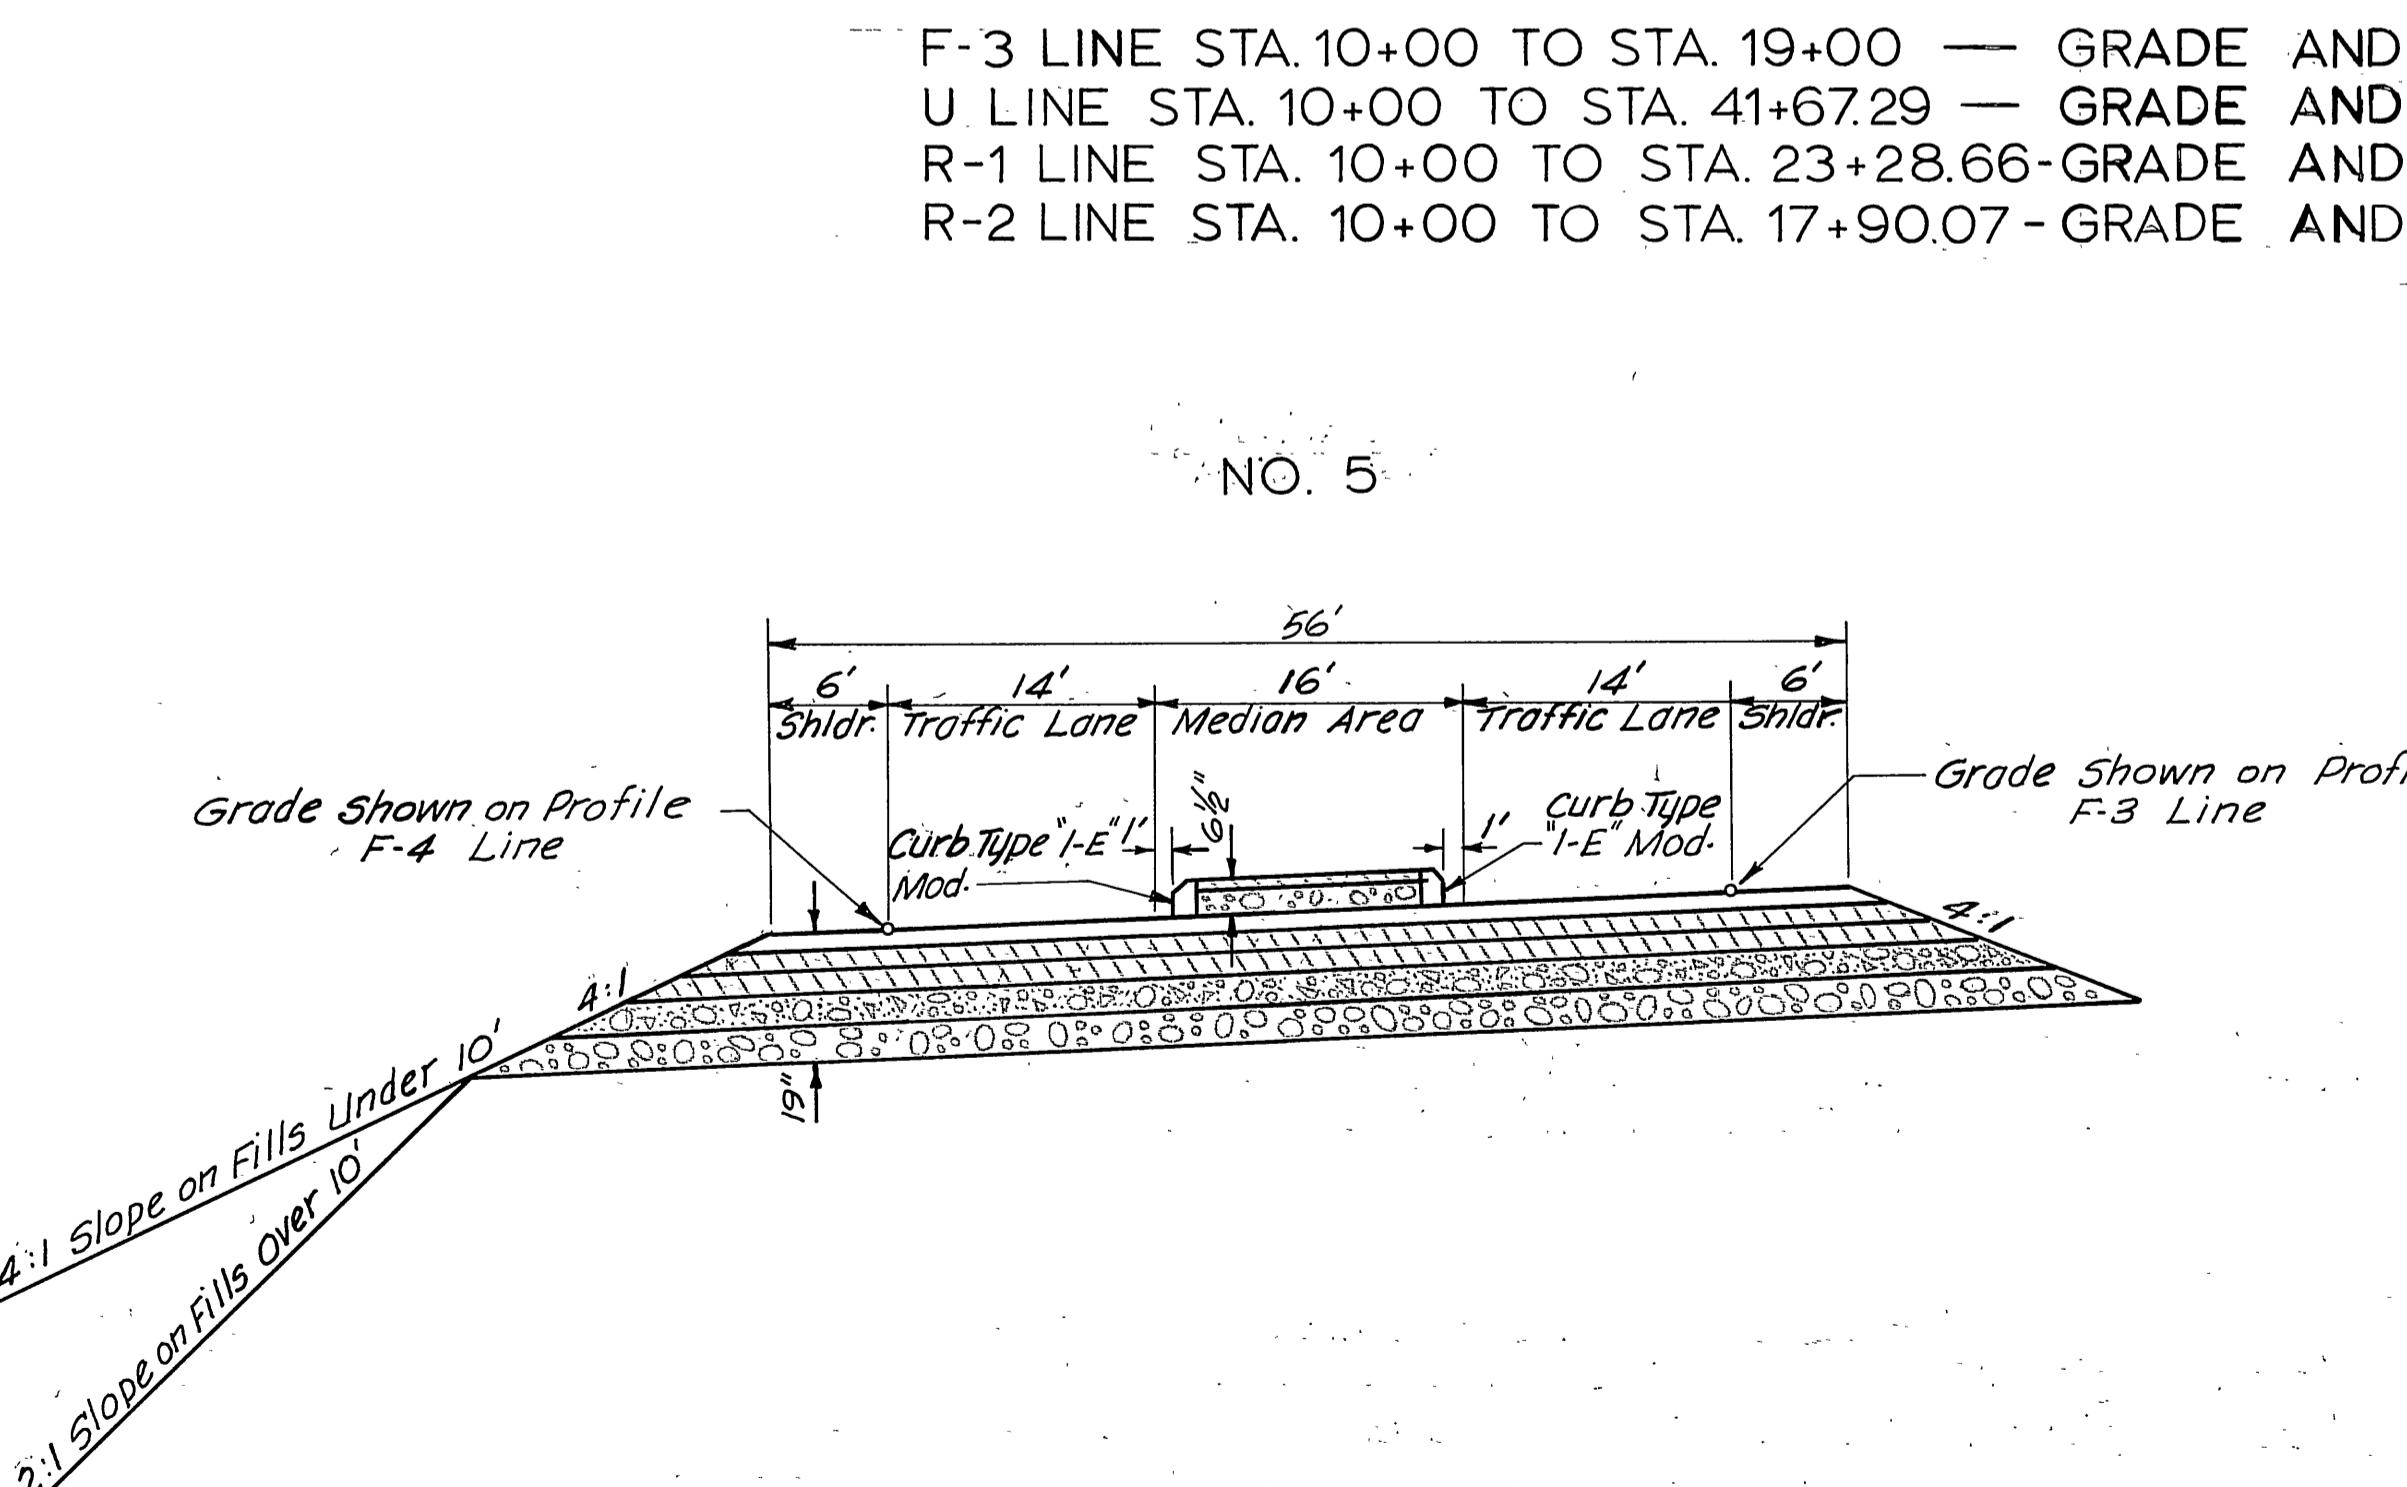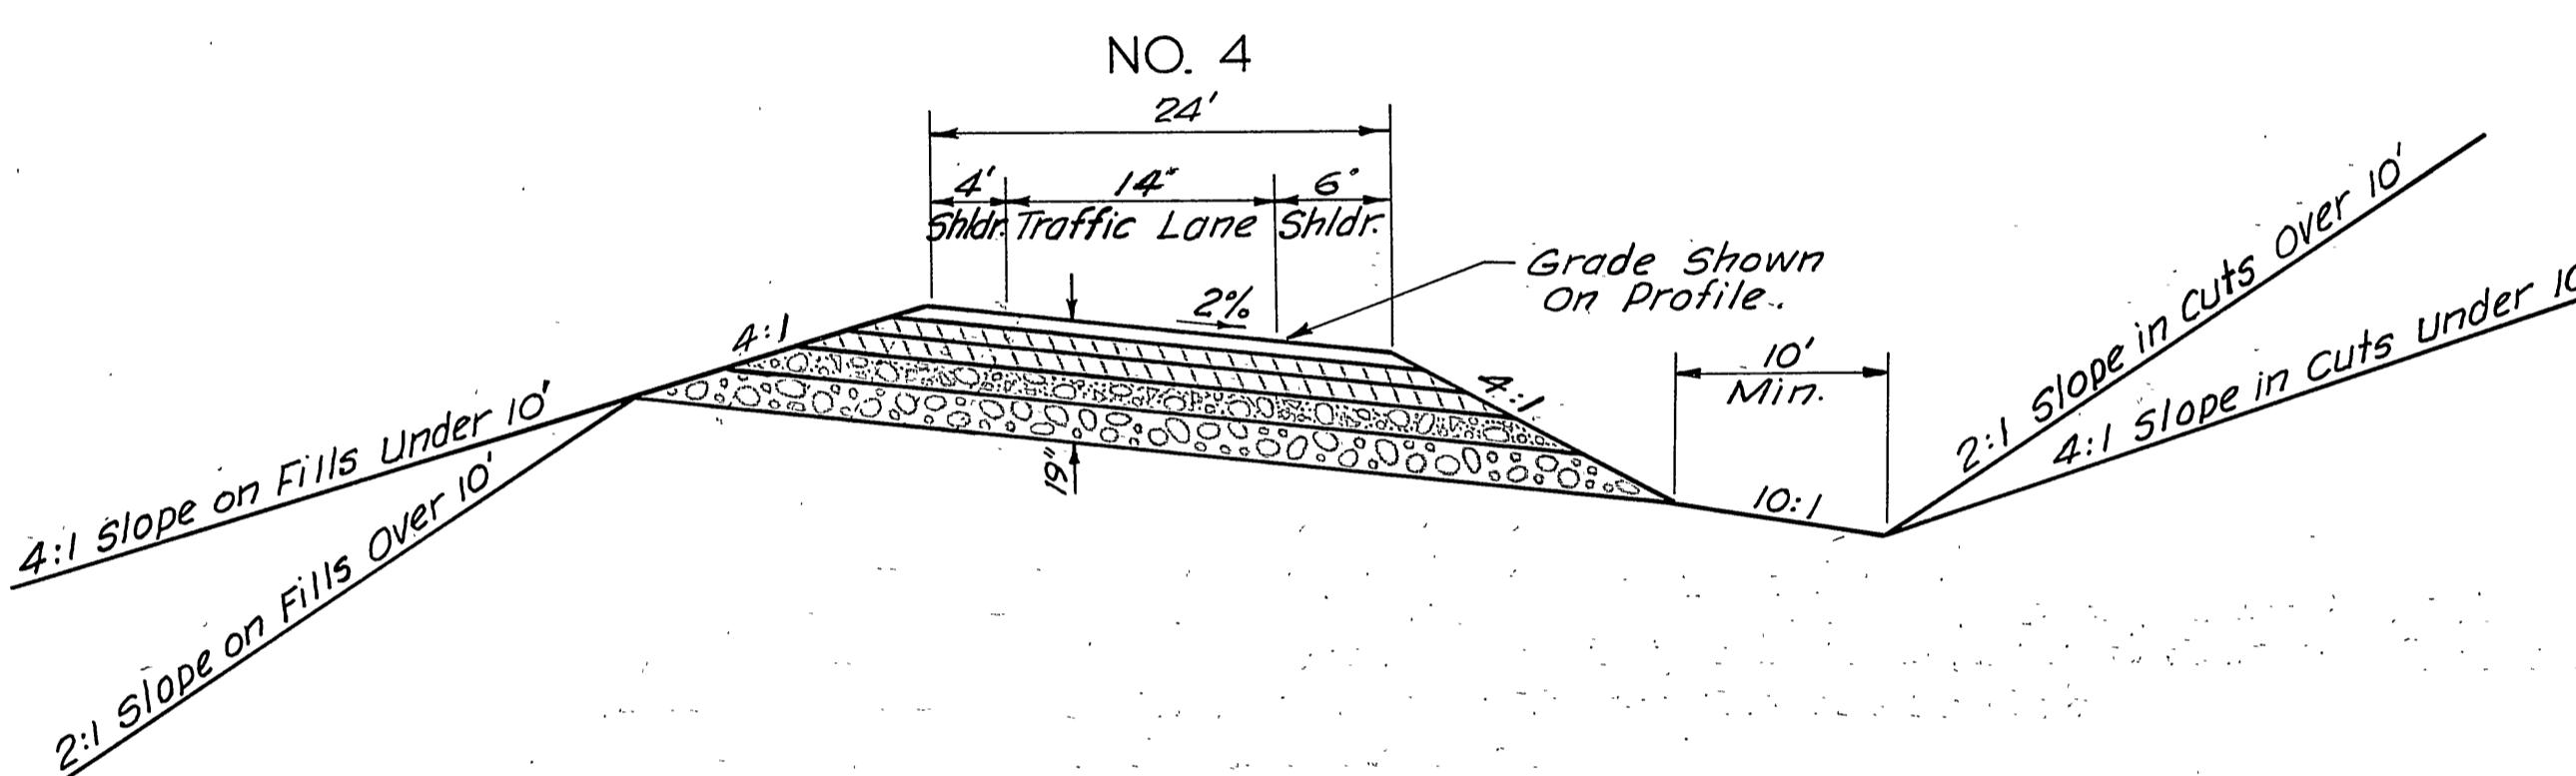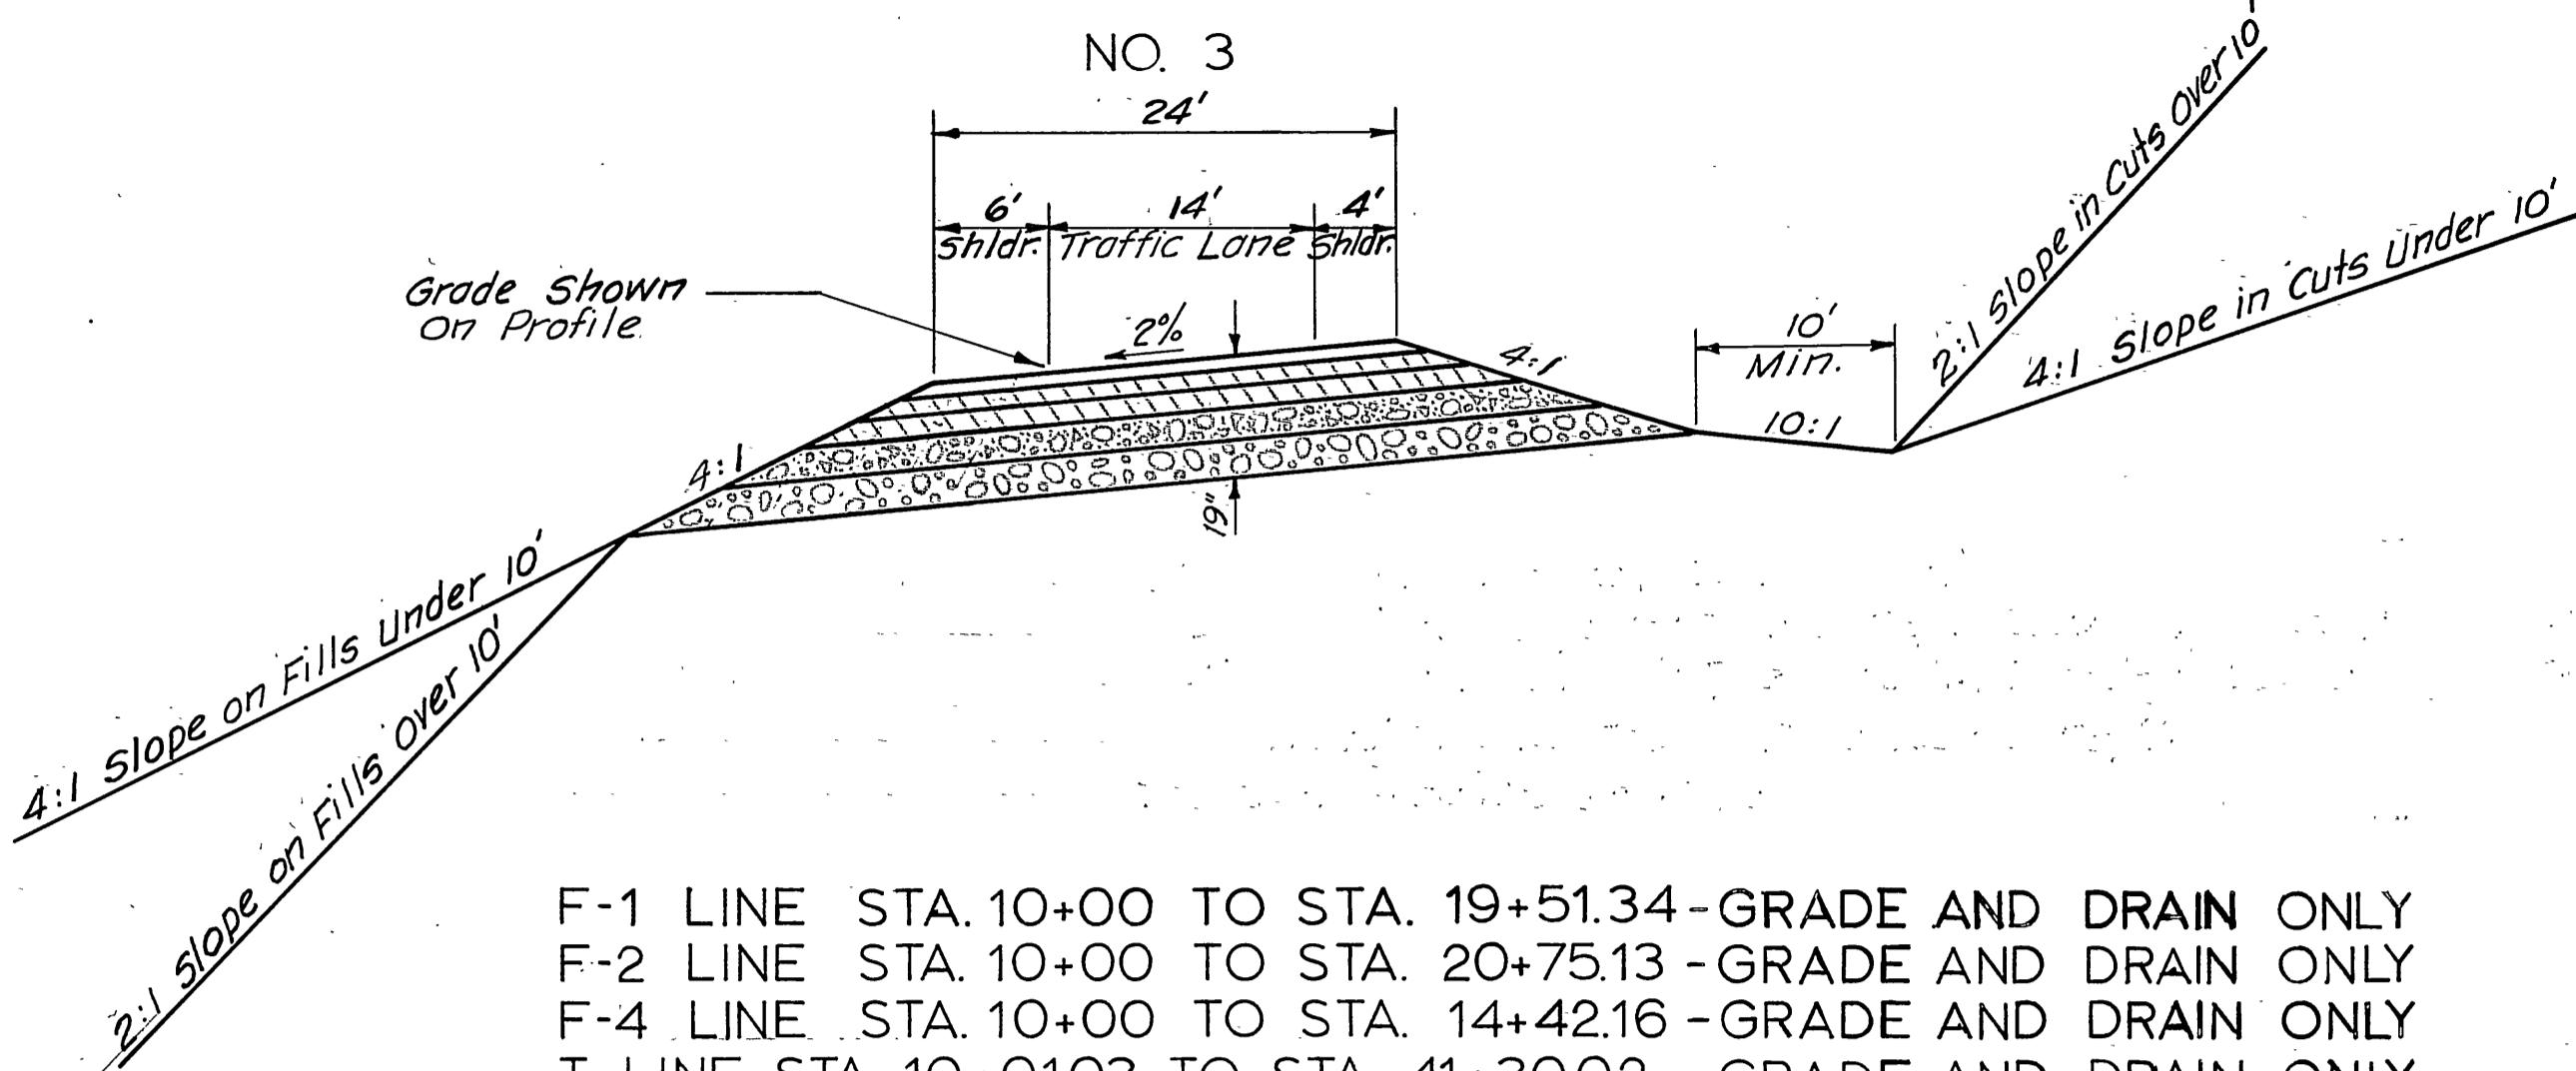


CURB TYPE 1-E MODIFIED

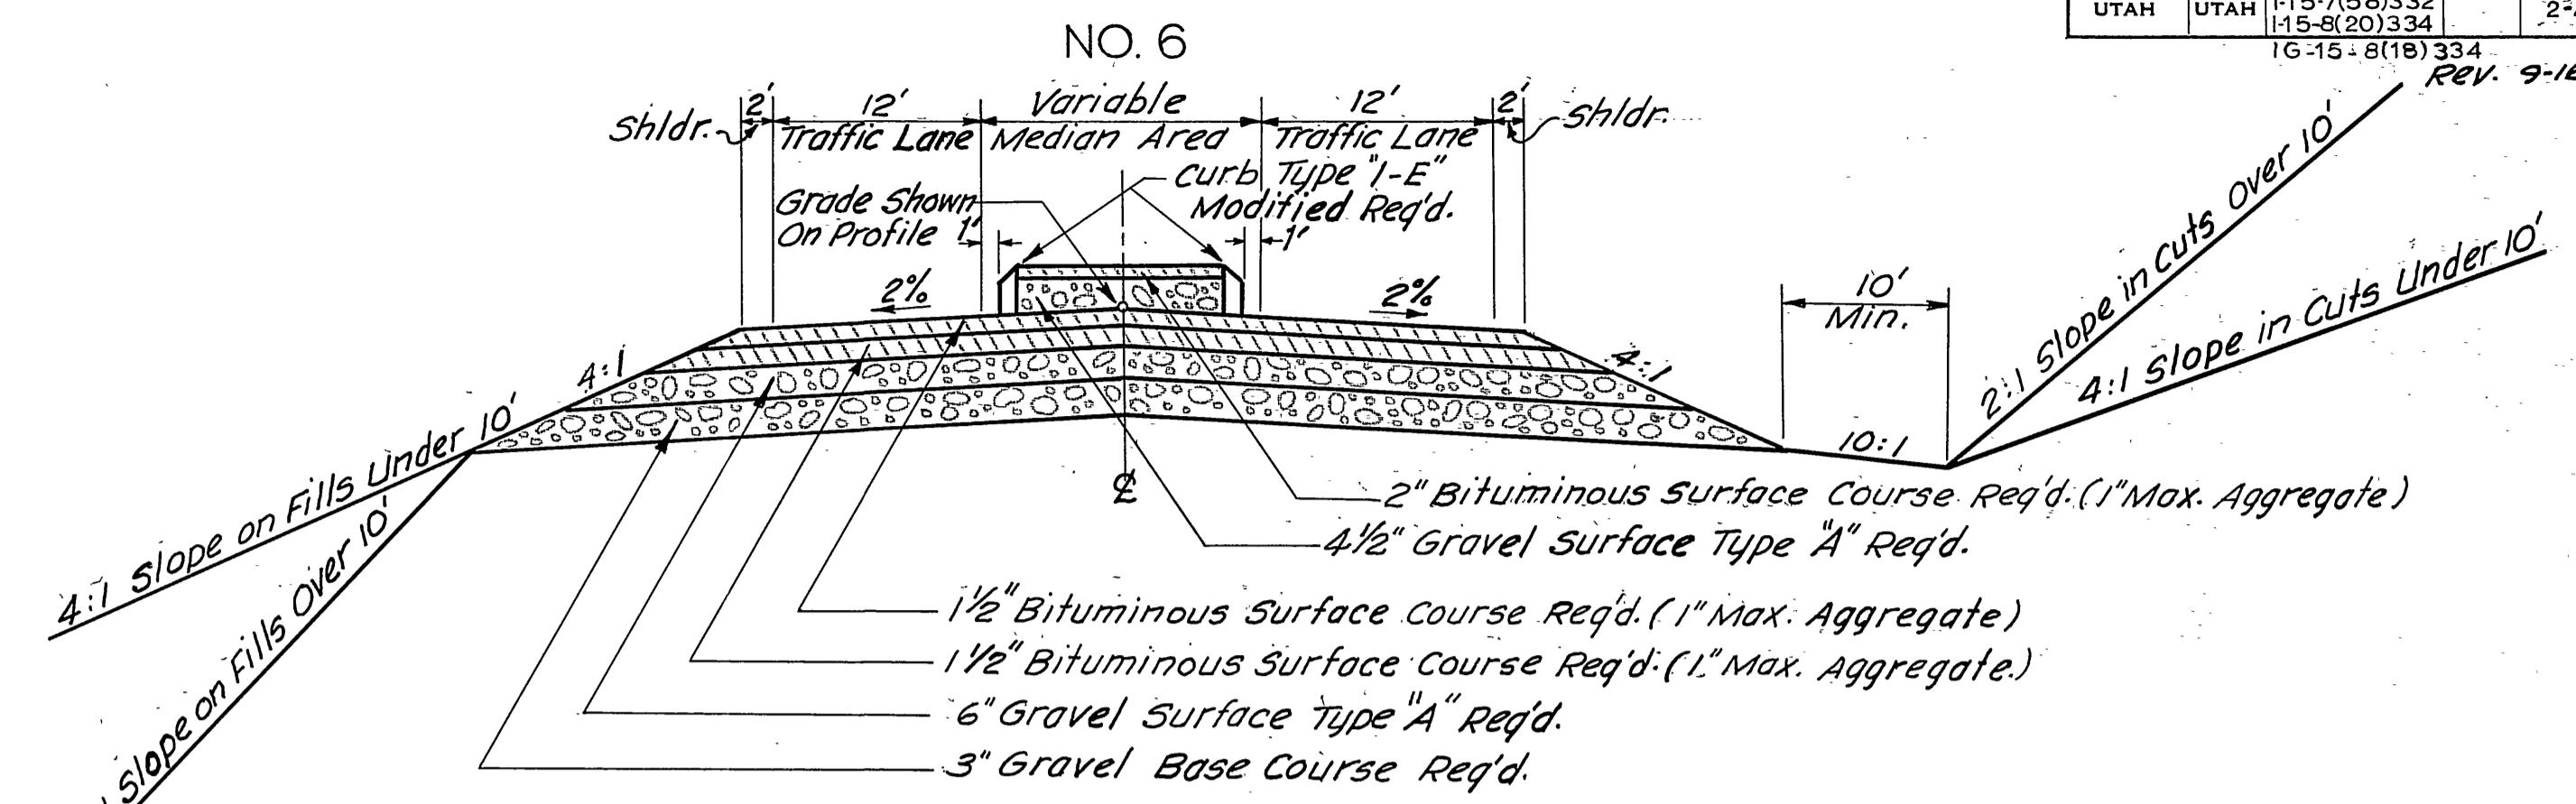


F-5 LINE 16' MEDIAN STA. 10+00 TO STA. 15+21.53
F-5 LINE VAR. MEDIAN STA. 15+21.53 TO STA. 20+54.78
F-5 LINE ZERO MEDIAN STA. 20+54.78 TO STA. 57+08.35

BITUMINOUS MATERIAL
Plant Mix - Penetration 60-70. Use 5.5% Gravel By Weight.
Seal Coat - RC. 800. Use 25 Gal./59 Yd. With Type A Cover Material.
Tack Coat - RC. 70. Use 15 Gal./59 Yd. Between Plant Mix Bituminous Courses.
Prime Coat - MC-400. Use 0.5 Gal./sq. Yd.
Curing Coat - MC-400. Use 0.15 Gal./sq. Yd.

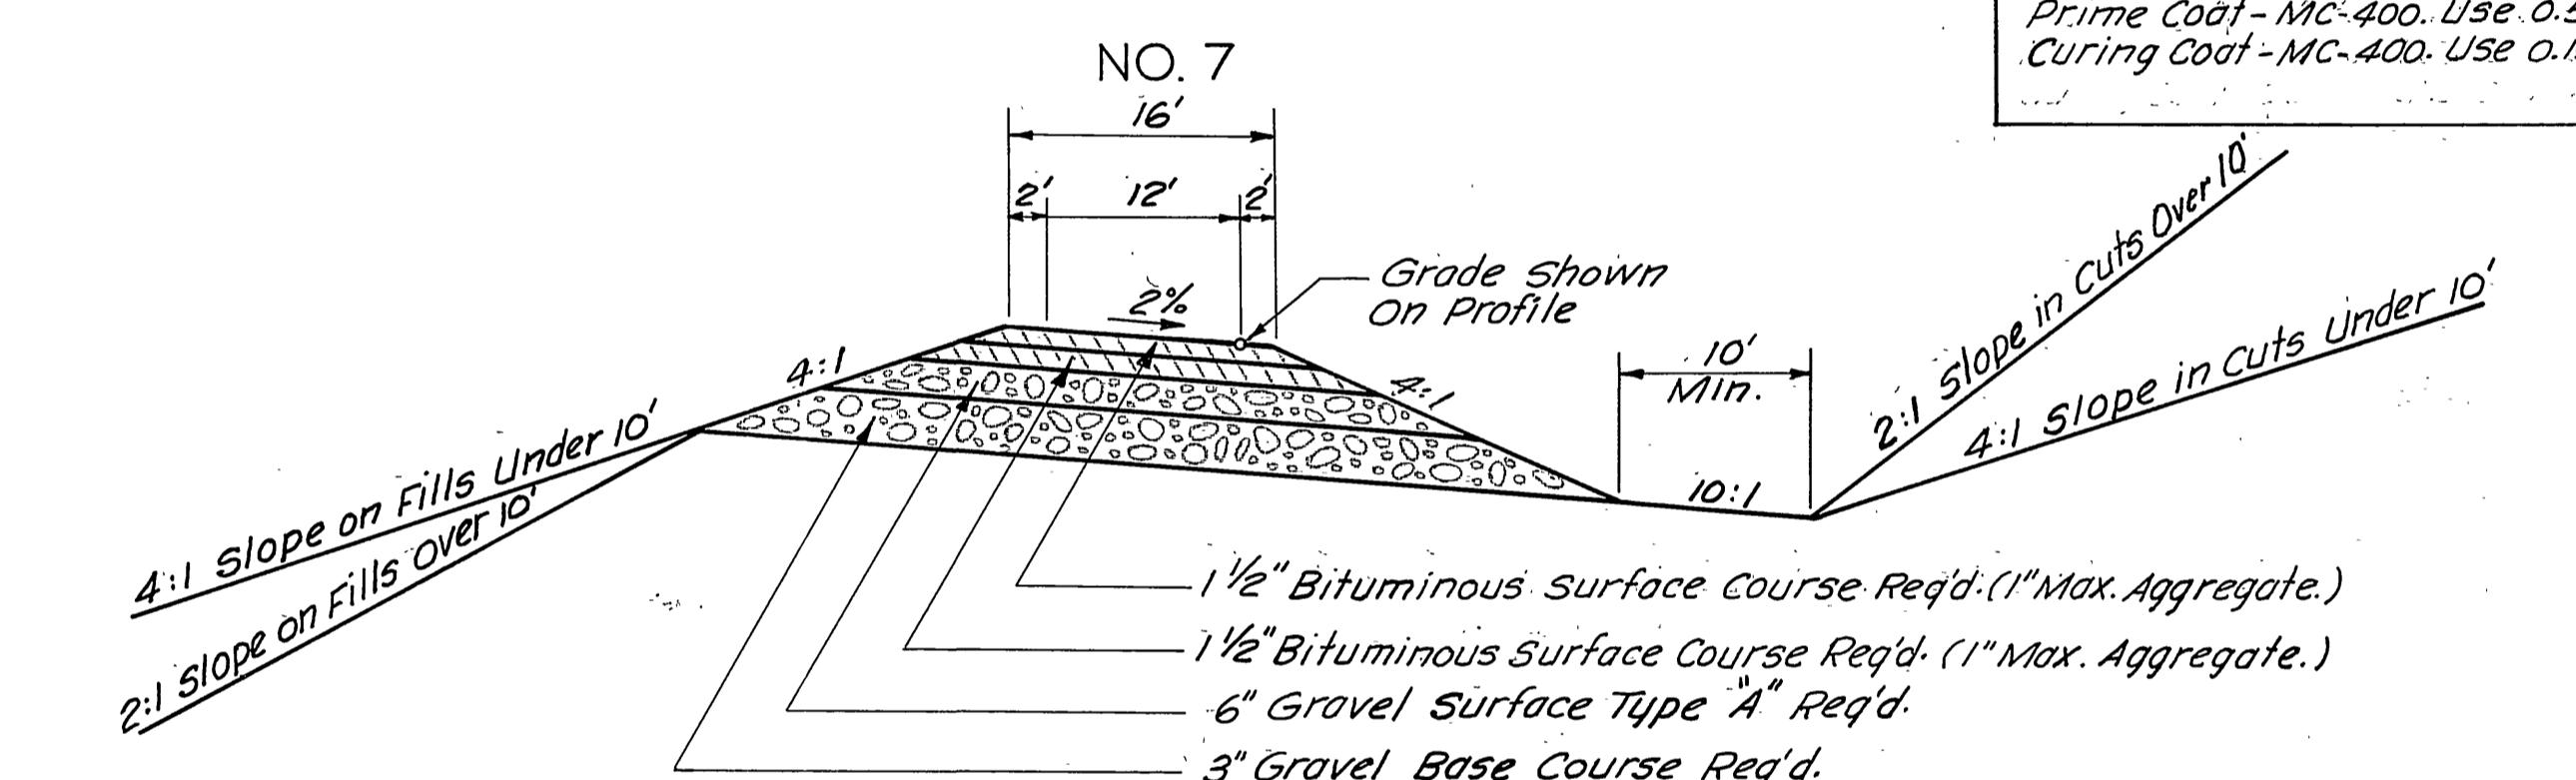

F-5A LINE STA. 10+00 TO STA. 12+87

GRAVEL MATERIAL
Cover Material - Type "A" - 25#/sq. yd.
Gravel Surface - Type "A" - 140#/cu. ft. compacted.
Portland Cement (2% by weight) Treated Base Course - 140#/cu. ft. compacted.
Gravel Base Course - 140#/cu. ft. compacted.
Bituminous Surface Course - 148#/cu. ft.

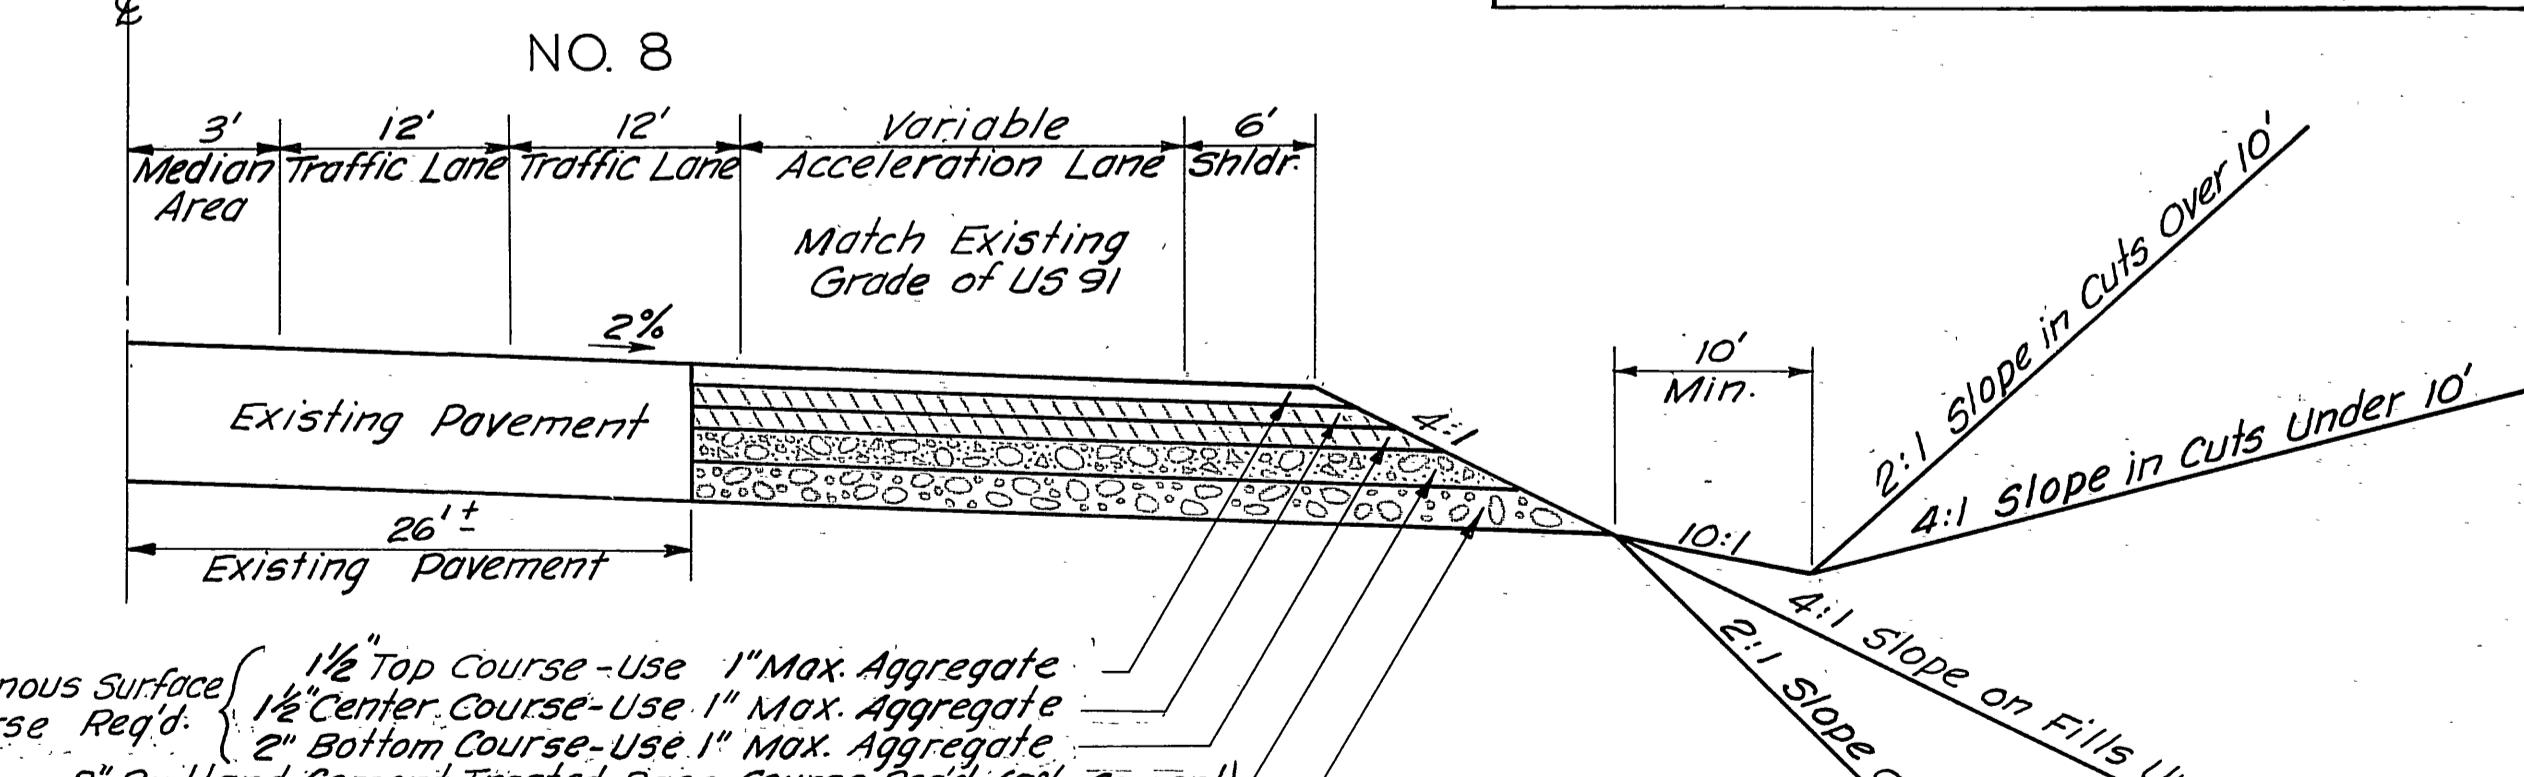


RIVERDALE ROAD AT R-2 AND F-5A LINES

TYPICAL SECTIONS


FED. ROAD DIST. NO.	STATE	PROJ. NO.	FISCAL YEAR	HEET NO.	TOTAL SHEETS
UTAH	UTAH	1157(58)332 1158(20)334		2-8	10-15 5(8)334

Rev. 9-16-63
Rev. 9-18-63

NO. 9

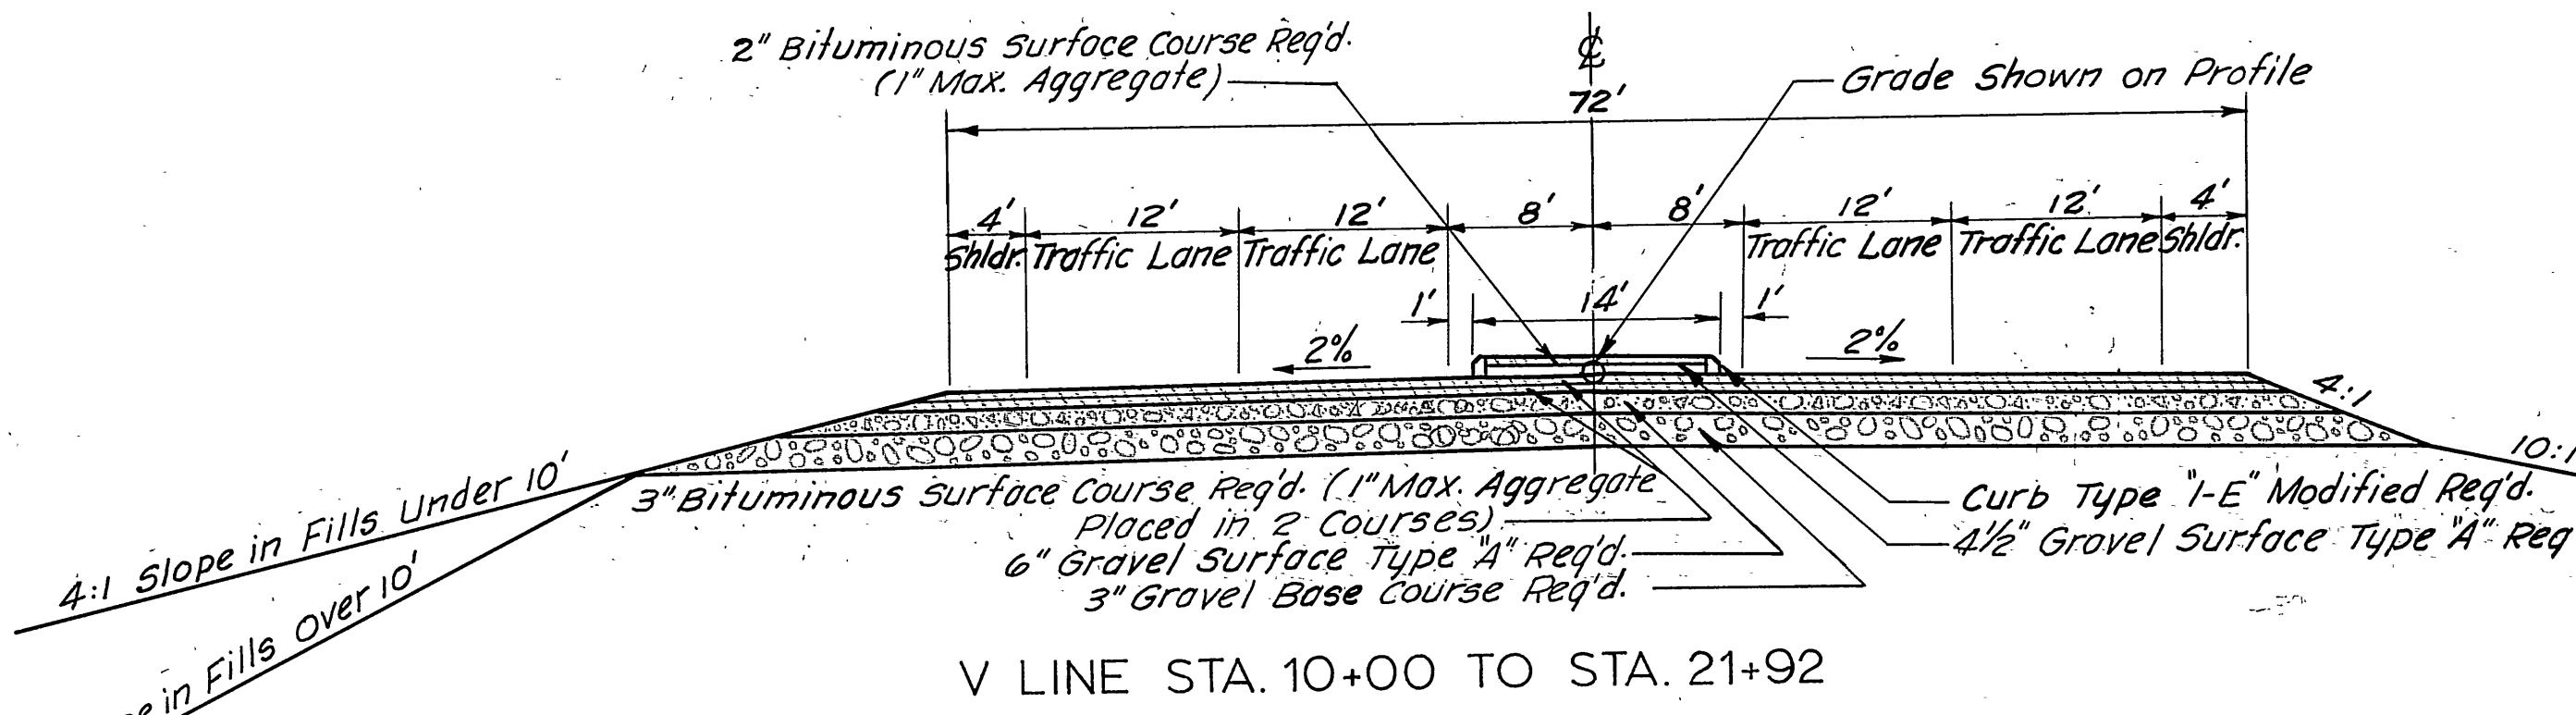


NO. 10

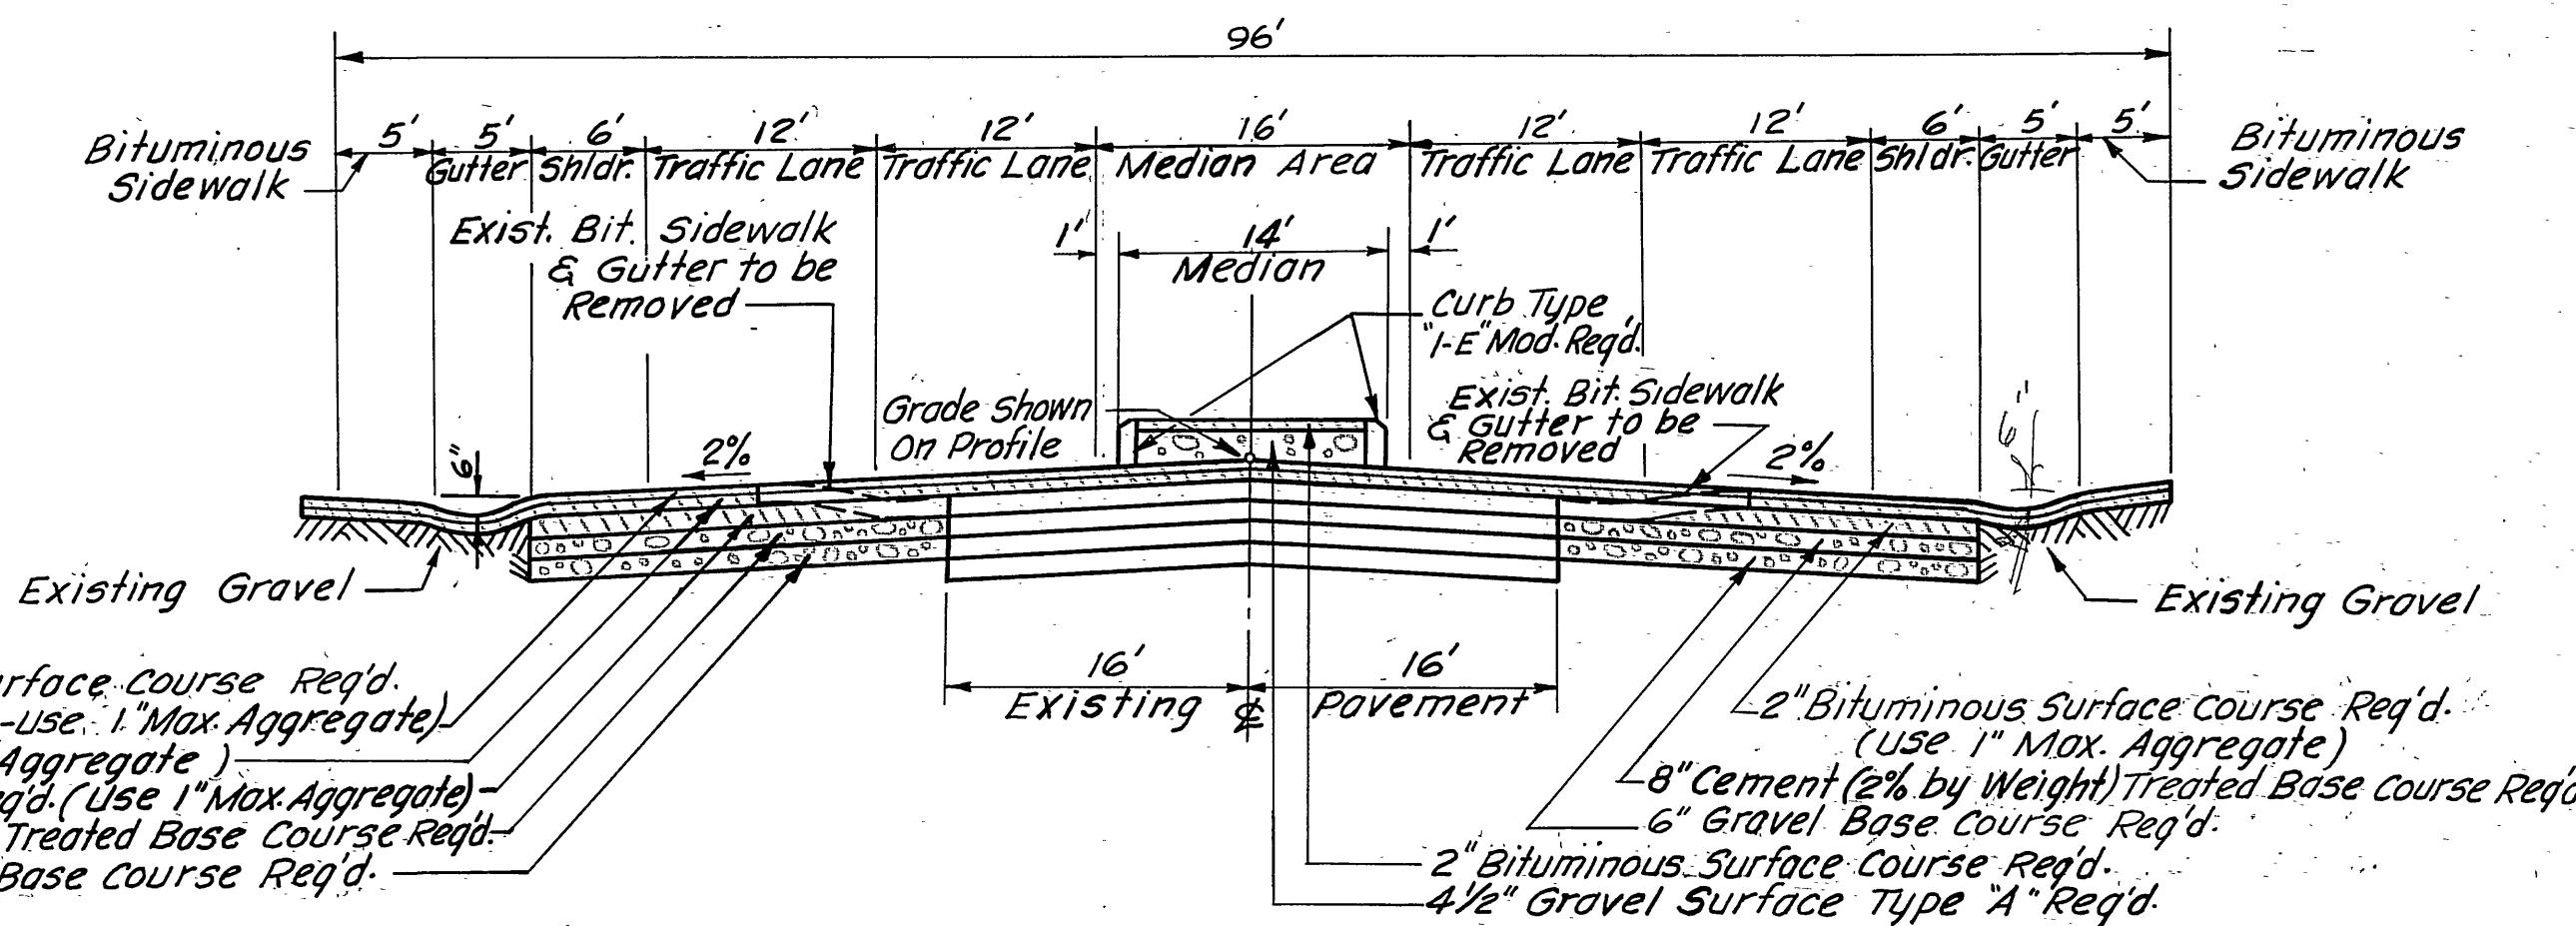


NOTE:
Shaping of Rolled Gutter
Will Not be Paid for Separately
But Will be Included in Other
Bid Items of Work.

5600 SOUTH STA. 4+20 TO STA. 13+20


TYPICAL
SMALL DITCH

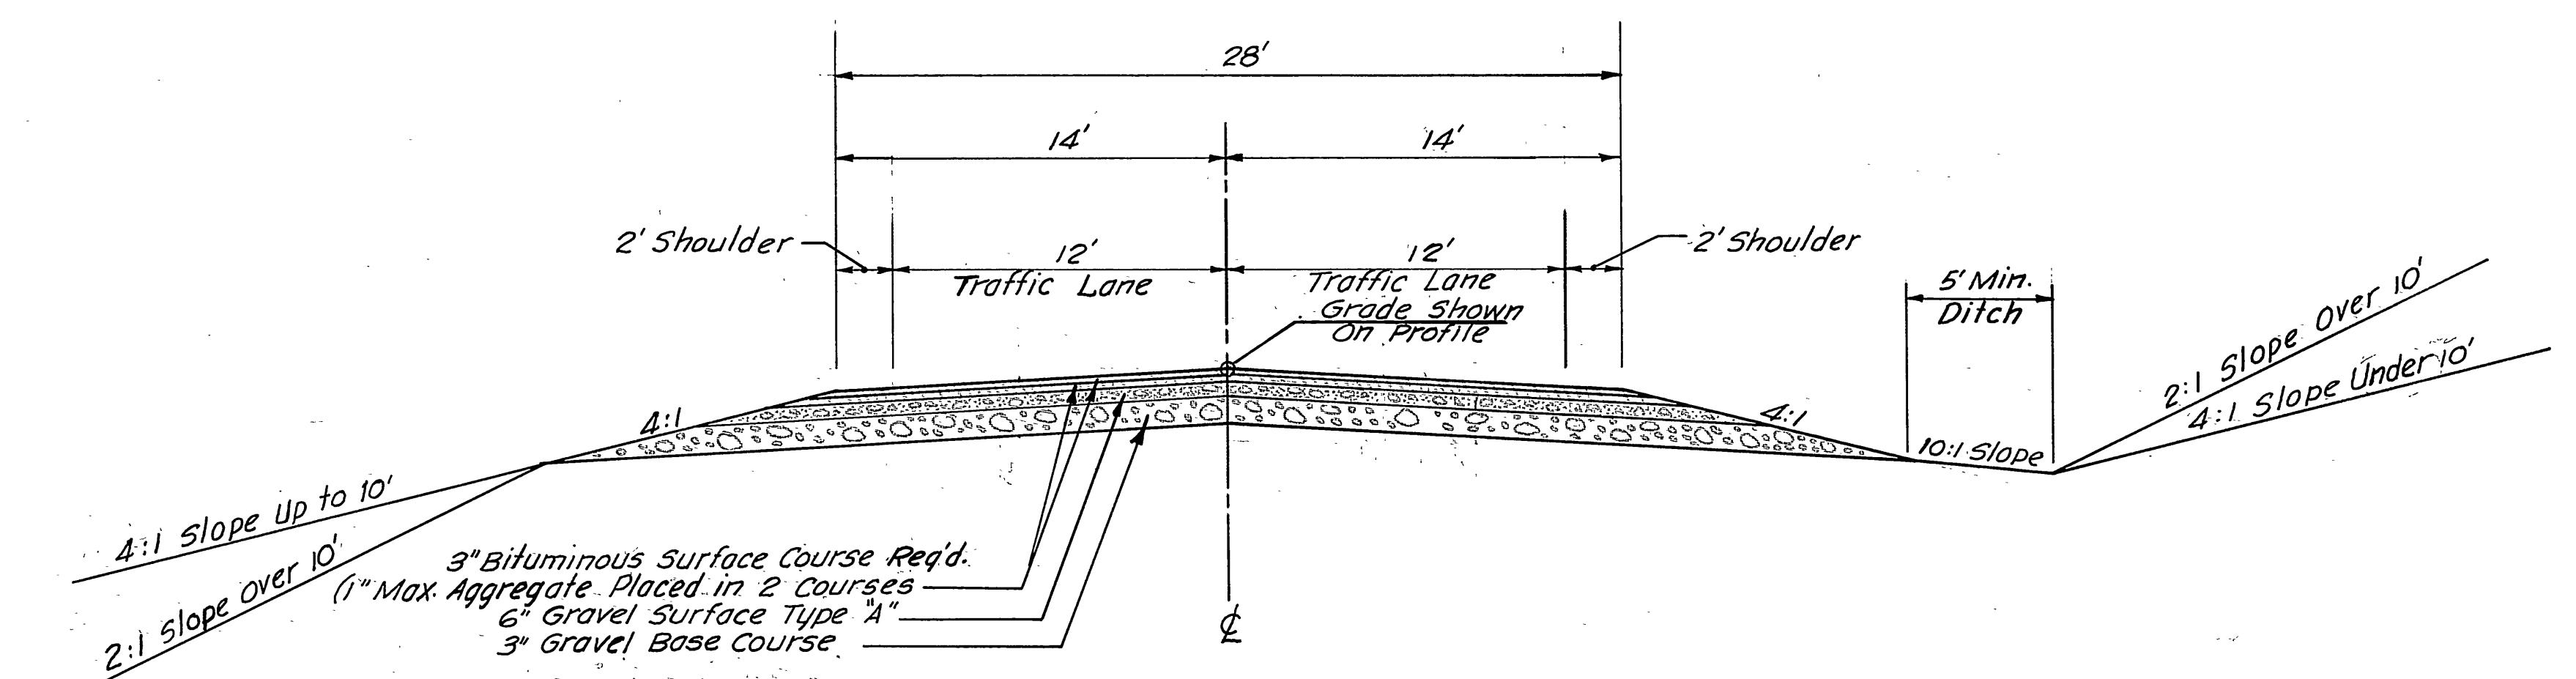

R-7 LINE STA. 10+00 TO STA. 21+41.04
R-9 LINE STA. 10+00 TO STA. 22+42.63
R-10 LINE STA. 10+00 TO STA. 19+54.17
R-8 LINE STA. 10+00 TO STA. 22+94.38

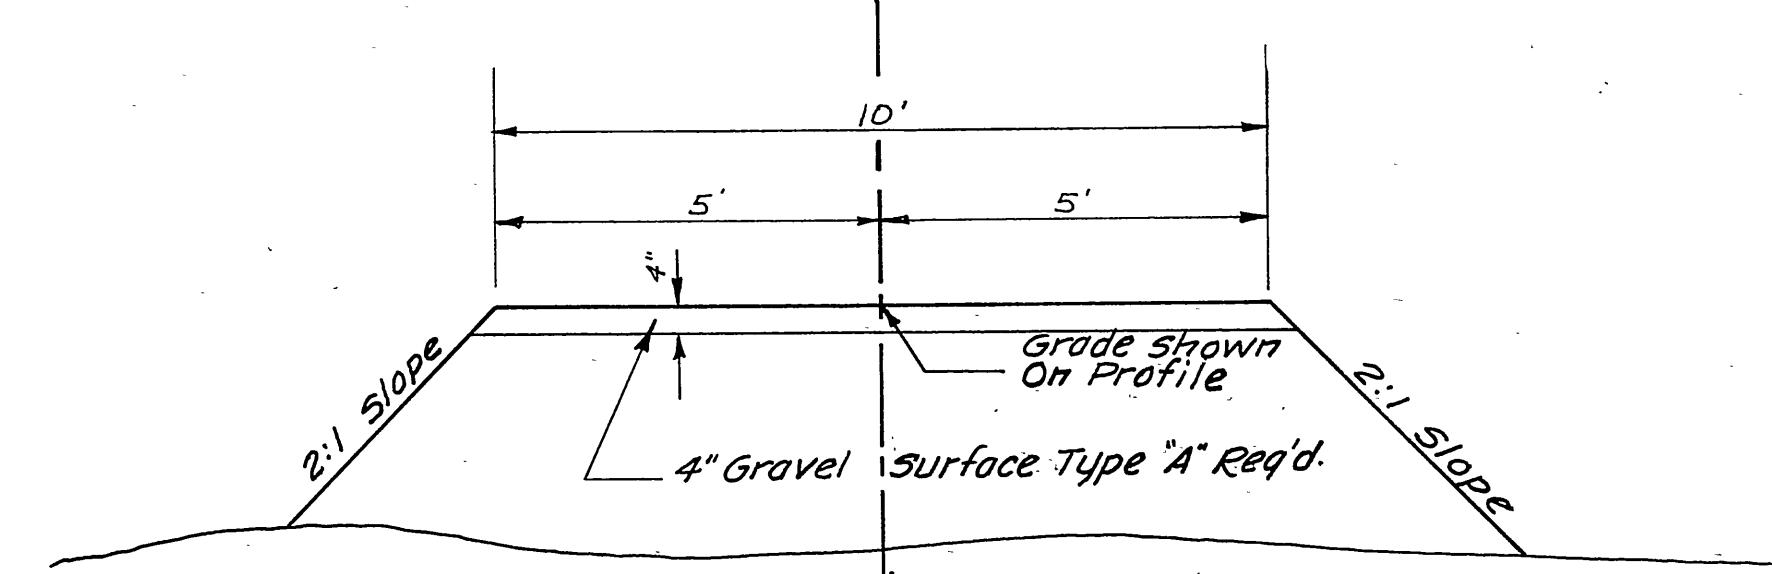

RELOCATED CANAL ROAD
STA. 10+00 TO STA. 44+09.94

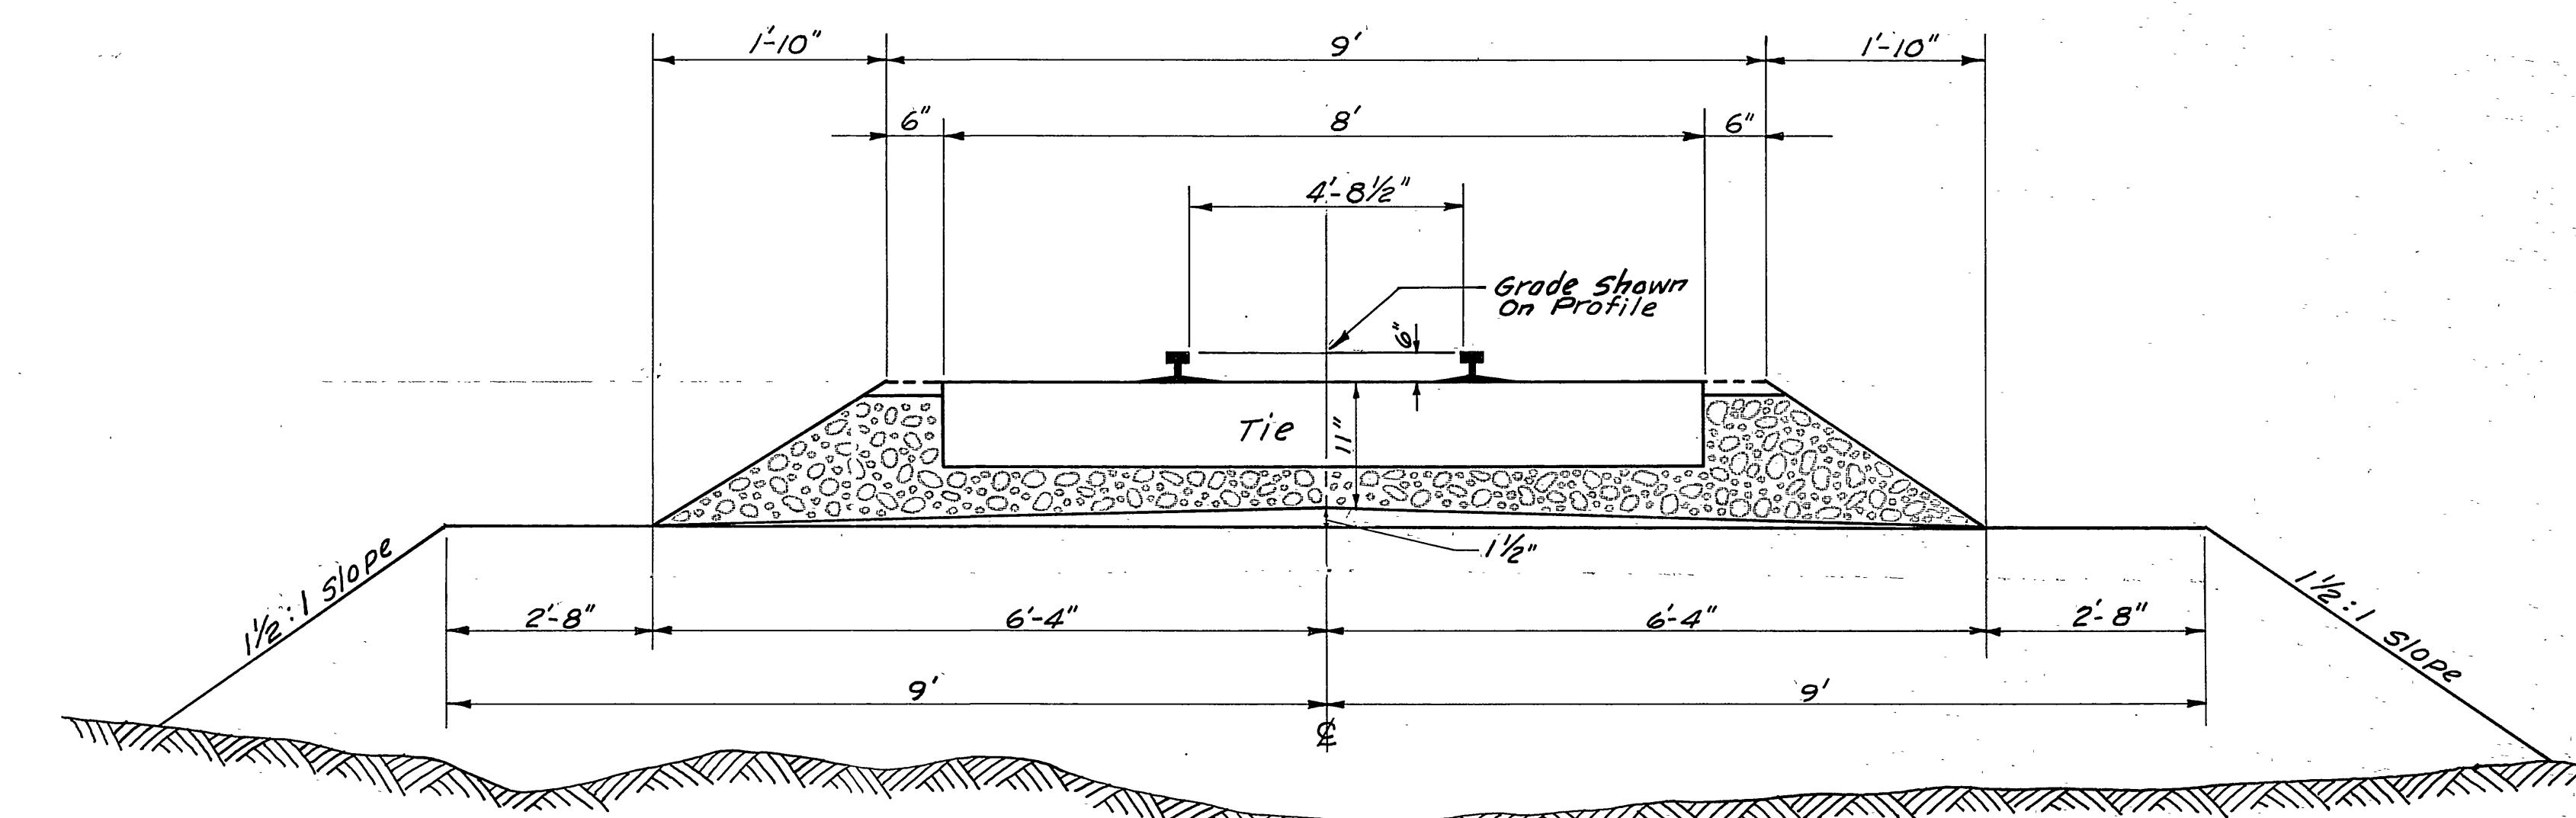


U.P.R.R. RELOCATION
STA. 10+06.62 TO STA. 28+67.14
(GRADING ONLY)

NOTE:
Ballast Ties and
Rails to be Constructed
By Others.

FED. ROAD DIST. NO.	STATE	PROJ. NO.	FISCAL YEAR	SHET. NO.	TOTAL SHEETS
UTAH	UTAH	115 7(58)332 115 8(20)334	16 15 8(18)334	28	28


REV. 9-16-63

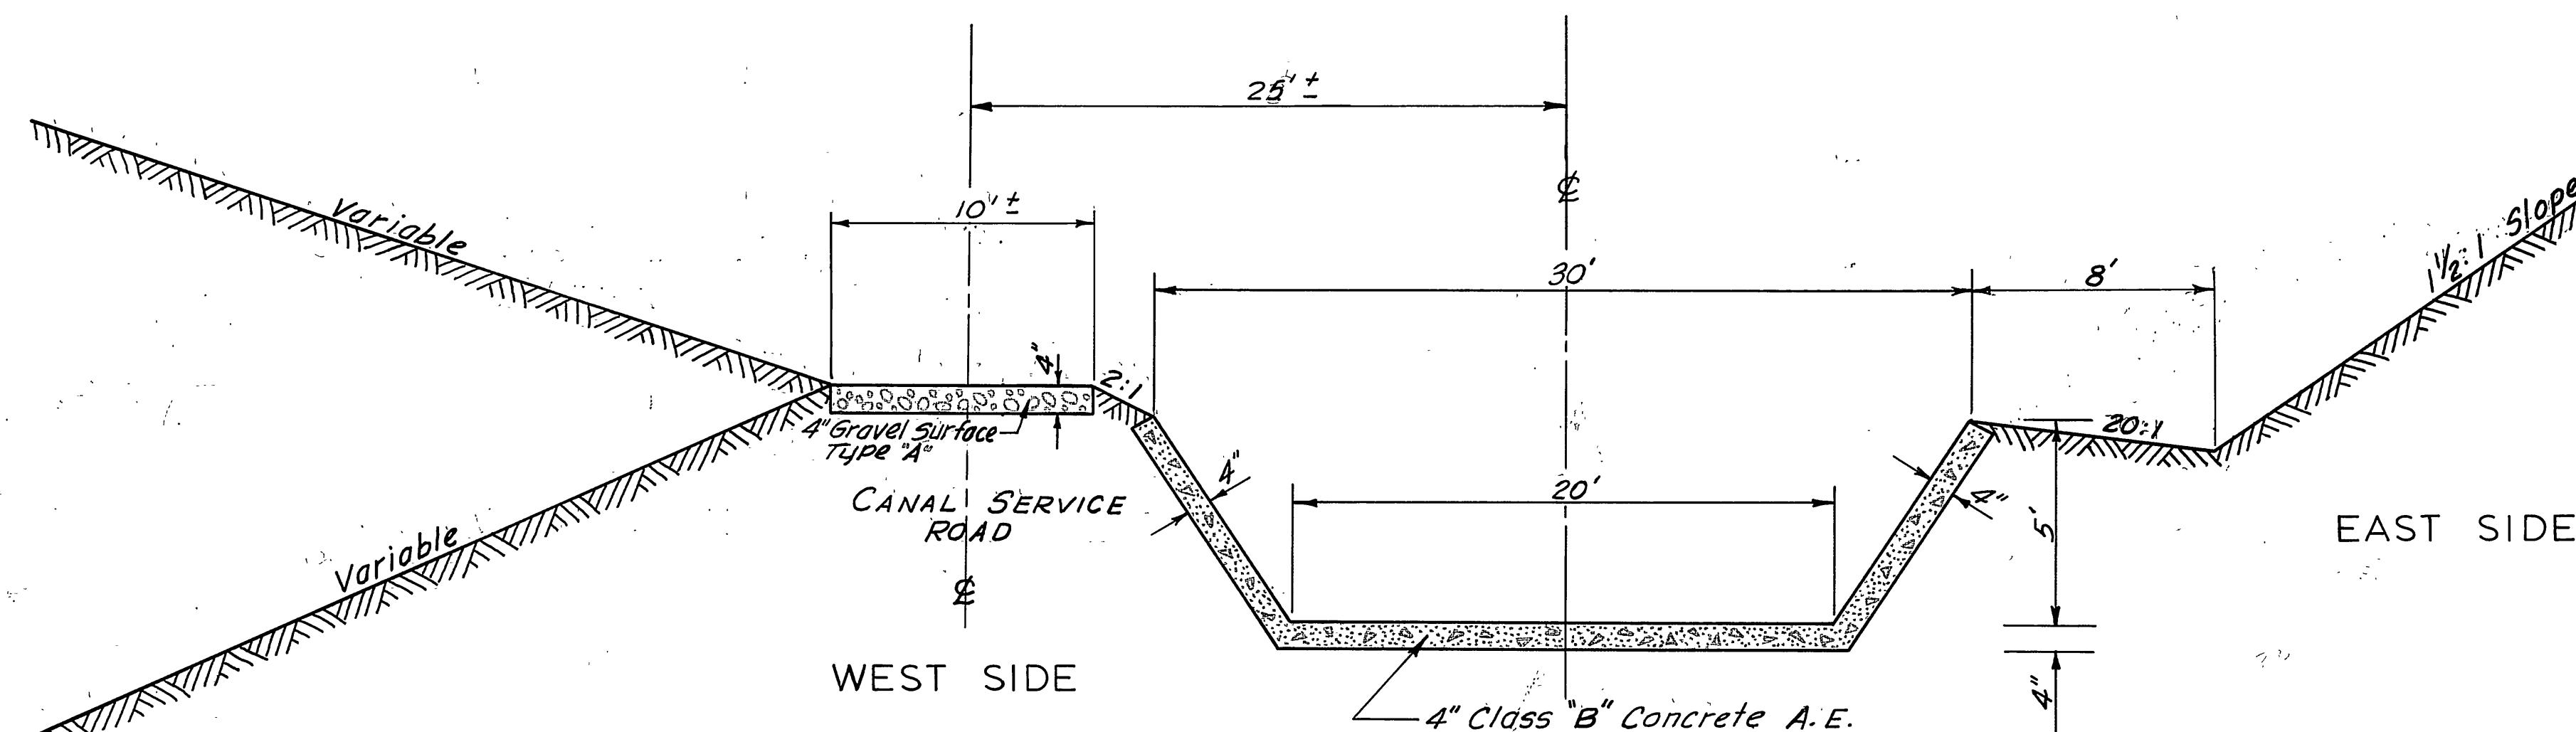


CROSS SECTION — DAVIS WEBER CANAL
STA. 10+00 TO STA. 35+66.58
NORTHWEST CORNER OF HILL FIELD

I-15-8 (12) 334


CONSTRUCTION OF CANAL IS NOT INCLUDED
IN THIS CONTRACT.

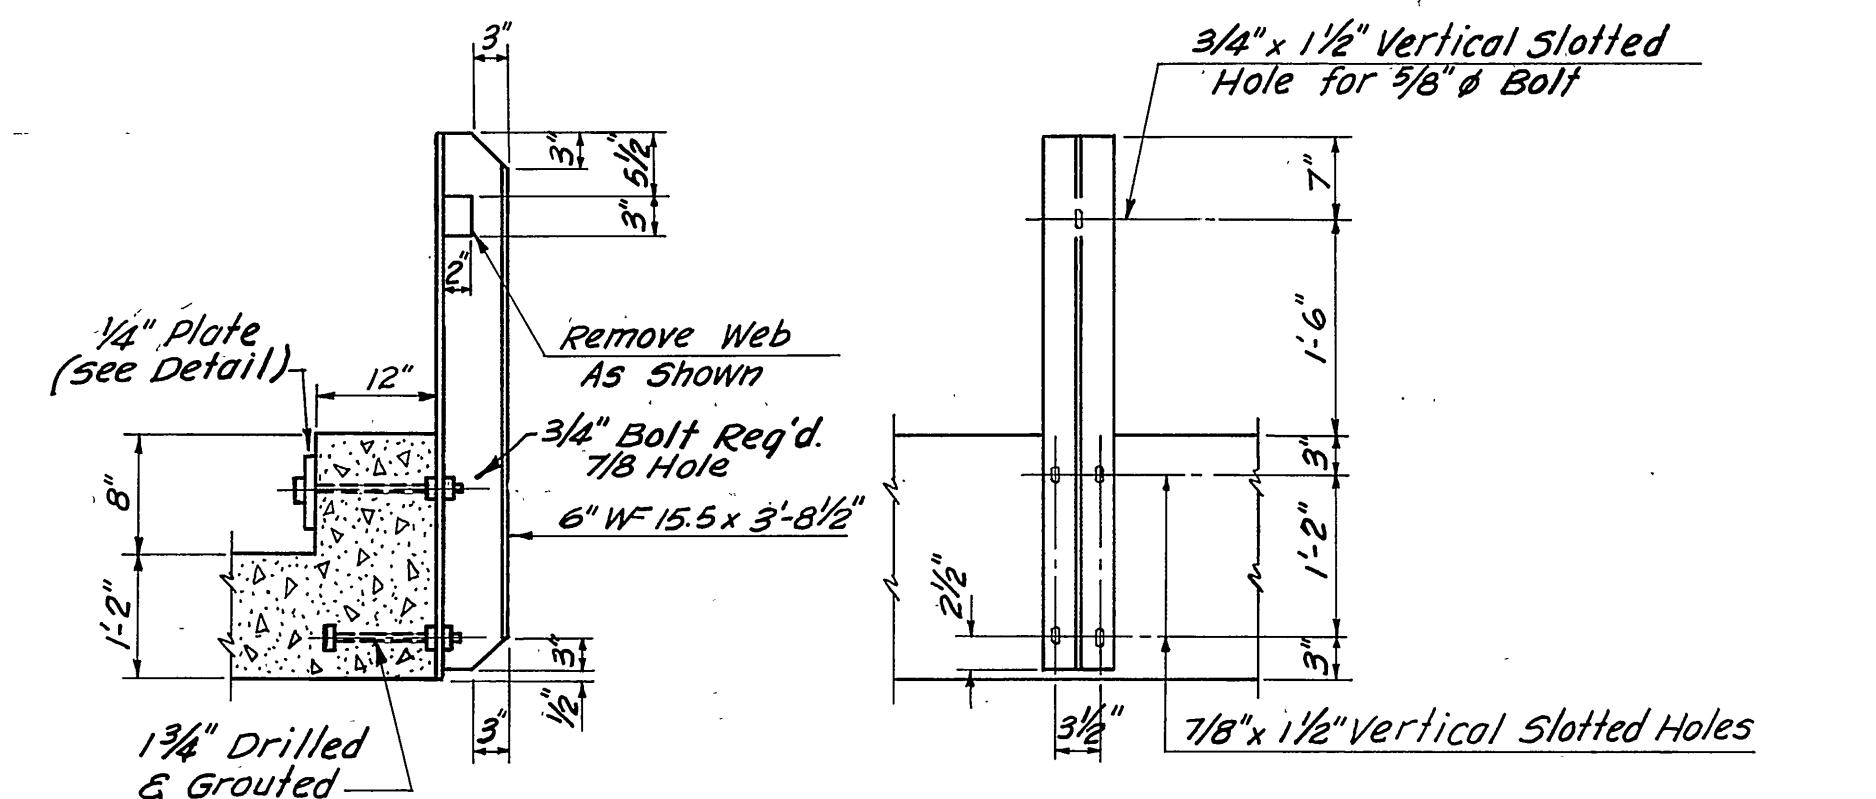


GUARDRAIL POST
(2 required)
"V" LINE

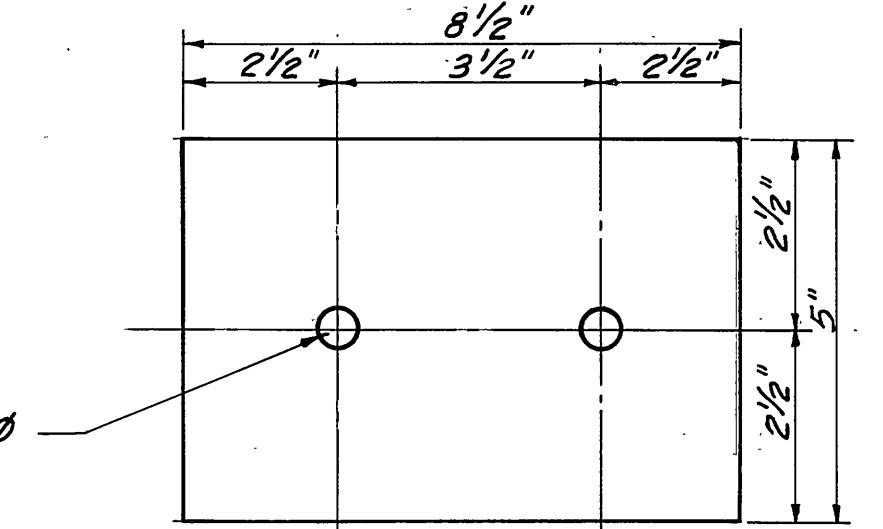

1/4" PLATE

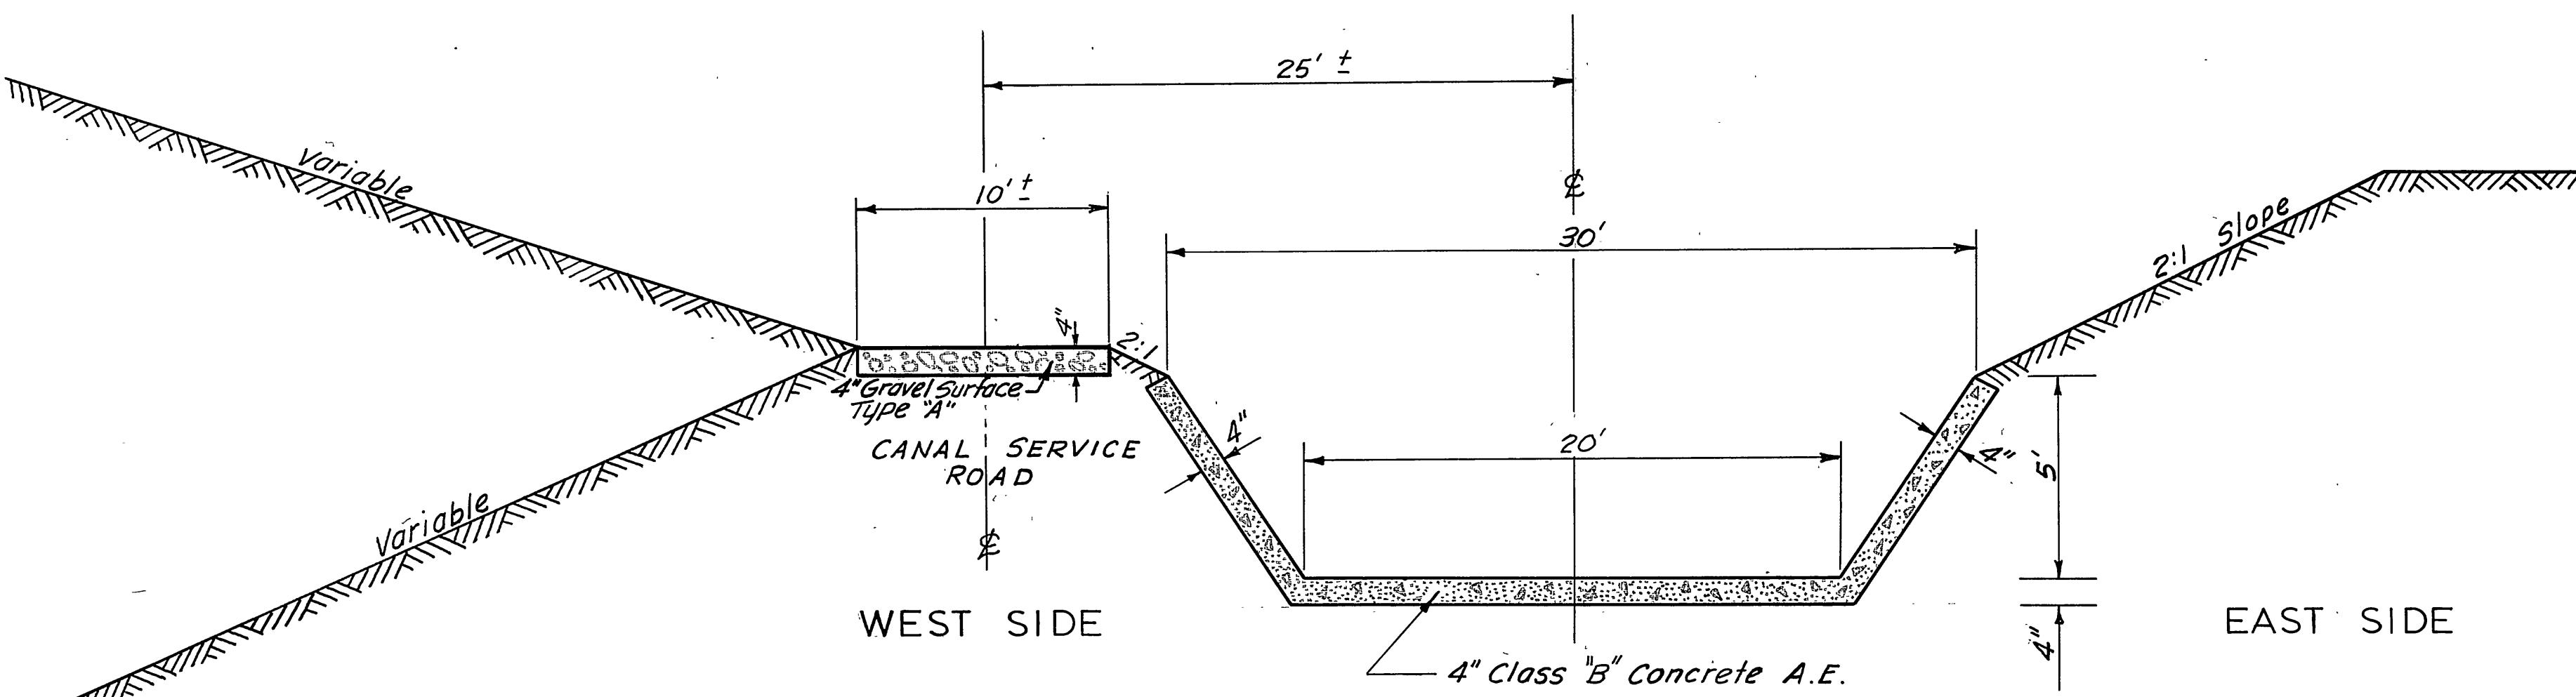

CROSS SECTION — DAVIS WEBER CANAL
STA. 13+50 TO STA. 66+40.77

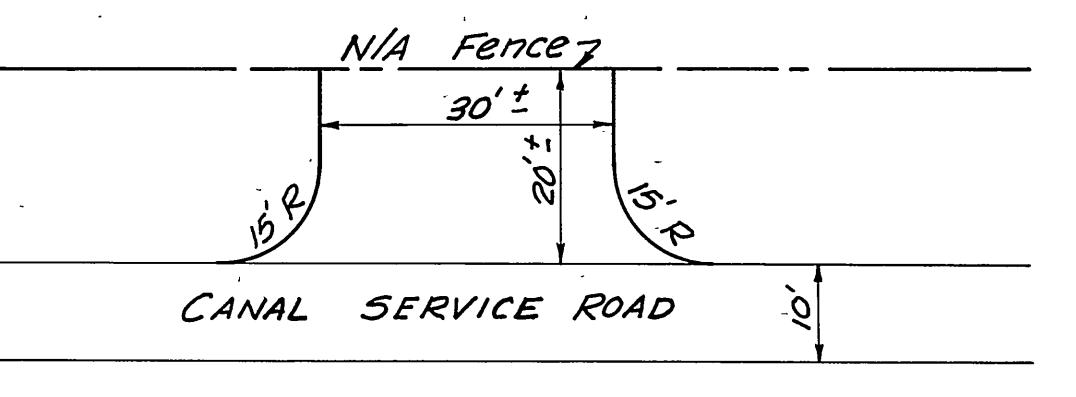

RELOCATED CANAL

R.R. Fence
Provide Maintenance Turn-Arounds
as shown or as directed by the Project
Engineer.
Place at Station 785 1/2 and Station 820 1/2.

REVISIONS	
DATE	BY

SUMMARY SHEET

NOTE! FOR CONSTRUCTION CHANGES, USE MARY SHEET
SEE AS CONSTR PLANS AND D-23-

7

3-A

I-15-7(58) 332
I-15-8(20) 334
IG-15-8(18) 334

REV. 8-30-63
REV. 9-16-63

SURFACING																		
PROJECT	LOCATION	STATION		LENGTH	GRAVEL MATERIAL				BITUMINOUS MATERIAL									
		FROM	TO		BITUMINOUS SURFACE COURSE (TONS)		GRAVEL SURFACE COURSE TYPE "A" (TONS)	GRAVEL BASE COURSE	PC. TREAT BASE COURSE	PORTLAND CEMENT	COVER MATERIAL TYPE "A"	60-70 MC-400 PENETRATION						
					MEDIAN	ROADWAY												
I-15-7(58) 332	"V"	10+00	21+92	1192.00	.82	1427	170	2360	1439		104.9	78	18.3	15.1	5.4	8.9		
SUB TOTAL					.82	1427	170	2360	1439		104.9	78		15.1	5.4	8.9		
TOTAL					1509		2530	1439			104.9	78		15.1	5.4	8.9		
USE					1509.		2660	1600			110	90	20.0	16	10	10.0		
I-15-8 (20) 334	"F-5"	10+00	15+21.53	521.53	81.3	446	168.4	876	465		31.9	25	5.7	5.3	1.6	2.7		
I-15-8 (20) 334	"F-5"	15+21.53	20+54.78	533.25	41.9	375	86.8	747	401		26.7	21	4.8	5.2	1.4	2.3		
I-15-8 (20) 334	"F-5"	20+54.78	57+08.35	3653.57			2013		4092	2238		142.1	111	25.9	20.1	7.5	12.1	
I-15-8 (20) 334	"F-5A"	10+00	12+87	287.00		121	29			268	295	126	6.4	8	0.4	1.5	0.7	0.5
I-15-8 (20) 334	"F-5A"			953.00		482	110			957	1067	454	23.8	33	1.4	5.9	2.6	2.0
I-15-8 (20) 334	Riverdale			500.00		279	64			537	607	258	13.9	19	0.8	3.4	1.5	1.2
I-15-8 (20) 334	"R-7"	10+00	21+41.04	1141.04		629		1279	699		44.3	35	8.1	6.3	2.3	3.8		
I-15-8 (20) 334	"R-8"	10+00	22+94.38	1294.38		713		1450	793		50.3	39	9.2	7.1	2.7	4.3		
I-15-8 (20) 334	"R-9"	10+00	22+42.63	1242.63		685		1391	761		48.3	38	8.8	6.9	2.5	4.1		
I-15-8 (20) 334	"R-10"	10+00	19+54.17	954.17		526		1069	584		37.1	29	6.8	5.3	2.0	3.2		
I-15-8 (20) 334	5600 So.	4+20	13+20	900	57	1595	547	120		1386	1848	786	75.0	95	* 4.8	16.5	8.9	6.4
Canal Road		10+00	14+09	3409			600											
Canal Road	Canal Reloc.	13+50	66+40	52+90			1234											
Canal Road	Canal Reloc.	10+00	35+67	25+67			599											
SUB TOTAL				180.2		7864	777	375	13,331	9089	3817	1624	500	453	71.9	83.5	33.7	42.6
TOTAL						8044	777	13,712	9089	3817	1624	500	453	71.9	83.5	33.7	42.6	
USE						9265		14,400	9600	4000	1700	530	480	90	90	40	50	
GRAND TOTAL				10,855		17,060	11,200	4000	1700	640	570	110	106	50	60			
DEEP BEAM GUARD RAIL																		
WOODEN POSTS				REMARKS														
LINE	STATION TO STATION		LT.	RT.														
Main	704+05	704+30	25		Use as a Barricade													
V	13+25	14+00	75															
V	13+25	14+00		75														
SUB TOTAL		100		75														
2' for 6 End Sections		8		4														
TOTAL		108		79														
		187																
F-5	39+00	39+25	25.0															
Main	918+70	918+95		25.0														
Main	900+65	900+93	25.0		Use as a Barricade													
Main	918+25	919+40		100.0	Use as a Barricade													
Main	924+02	924+20	25.0		Use as a Barricade													
Main	924+02	924+20		25.0	Use as a Barricade													
SUB TOTAL		75		150.														
2 Feet for 6 End Sections		12																
2 Feet for 6 End Sections		12																
SUB TOTAL		87		162														
TOTAL				249														
CONTRACT TOTAL				436														

* MC 400 @ 0.15 Gal/yo²

1-15-7(58)332
1-15-8 20 334
16-15-8(18)334
REV 8-30-63
REV 9-10-63

SUMMARY SHEET

EARTHWORK SUMMARY

LINE	STATION TO STATION	EMBANKMENT	EMBANKMENT X FACTOR	EXCAVATION	BORROW	OVERHAUL		REMARKS						
						CU. YDS.	CU. YDS.							
PROJECT NUMBER														
I-15-7 (58) 332														
Main	700 + 00	704 + 18		24,050		240,500	1366							
	704 + 18	711 + 39		37,180		167,310								
	711 + 39	721 + 39	18,679	22,415	22,415	F.H.								
	721 + 39	724 + 18	30,983	37,180										
	724 + 18	725 + 93	20,042	24,050										
	725 + 93	727 + 20	20,833	25,000	25,000	250,000	65,530							
	727 + 20	728 + 45	21,561	25,873	25,870	258,730	67,231							
	728 + 45	730 + 40	40,939	49,127		491,270	198,555							
	730 + 40	732 + 90	41,667	50,000		500,000	197,822							
	732 + 90	736 + 30	41,667	50,000		500,000	192,898							
	736 + 30	739 + 30	22,492	26,991		269,910	101,779							
	739 + 30	739 + 54	542	650		6500	870							
	739 + 54	748 + 19	8031	9637	9637	F.H.								
	748 + 19	748 + 67	3879	4655	1548	31,070	3495							
	748 + 67	754 + 00	3943	4732	4732	F.H.								
	754 + 00	754 + 57	327	382	167	2150	212							
	754 + 57	761 + 00	2794	3353	3353	F.H.								
	761 + 00	763 + 89	823	988	2169	11,180	973							
	763 + 89	767 + 00	1422	1707	1707	F.H.								
	767 + 00	768 + 53	1340	1608	660	9480	668							
	768 + 53	771 + 45	6198	7438	355	70,830	376							
	771 + 45	775 + 66	11,067	13,281	256	50,798								
	775 + 66	785 + 66	16,472	19,767	19,767	F.H.								
	785 + 66	791 + 45	8587	10,304	23,329									
	791 + 45	795 + 00	6712	8055	15,138									
	795 + 00	796 + 87	6266	7507	4436	30,710	494							
	796 + 87	808 + 00	34,862	41,834	41,834	F.H.								
	808 + 00	812 + 34	12,698	15,238	11,563	12,862								
	812 + 34	814 + 00	3254	3905	3905	F.H.								
	814 + 00	822 + 95	20,217	24,260	24,260	F.H.								
	822 + 95	824 + 34	1803	2164	5839									
	824 + 34	825 + 37	975	1170	4241									
	825 + 37	825 + 70	642	771	1719									
	825 + 70	826 + 20	713	856	2037									
	826 + 20	826 + 35	0	0	215									
	826 + 35	829 + 20	7195	8634	11,741									
	829 + 20	831 + 00	3797	4556	5206									
	831 + 00	836 + 15	21,865	26,238	4459	217,790	41,826							
	PROJECT TOTAL		445,277	533,326	287,918	50,870	3,121,720	874,095						
	PROJECT I-15-8 (20) 334													
	836 + 15	836 + 30	1024	1230		12,300	2309							
	836 + 30	843 + 00	34,347	41,217	442	408,545	72,740							
		SUB-TOTAL	35,371	42,447	442	420,845	75,049							
	PROJECT I-15-8 (18) 334													
	843 + 00	844 + 50	7688	9225		91,455	16,275							
	844 + 50	849 + 30	41,667	50,000		500,000	79,924							
	849 + 30	851 + 75	41,667	50,000		500,000	74,148							
	851 + 75	853 + 49	36,304	43,565		435,650	59,654							
	853 + 49	854 + 90	47,029	56,435		564,350	48,632							
	854 + 90	856 + 40	41,667	50,000		500,000	28,127							
	856 + 40	857 + 60	41,667	50,000		500,000	24,526							
	857 + 60	858 + 60	41,667	50,000		500,000	22,443							
	858 + 60	859 + 55	41,667	50,000		500,000	19,981							

EARTHWORK SUMMARY (CONTINUED)

LINE	STATION TO STATION	EMBANKMENT	EMBANKMENT X FACTOR	EXCAVATION	BORROW	OVERHAUL		REMARKS						
						CU. YDS.	CU. YDS.							
Main														
I-15-8 (20) 334														
	859 + 55	860 + 60	41,667	50,000				500,000						
	861 + 55	862 + 50	41,667	50,000				500,000						
	862 + 50	863 + 00	16,026	19,231				192,310						
	PROJECT TOTAL		482,050	578,456				5,783,765						
	PROJECT I-15-8 (20) 334		863 + 00	863 + 80	25,641	30,769		307,690						
	864 + 95	866 + 55	41,667	50,000				500,000						
	866 + 55	869 + 53	51,579	61,895				618,950						
	869 + 53	874 + 27	73,462	88,155				396,698						
	874 + 27	884 + 27	50,945	61,134				F.H.						
	884 + 27	889 + 53						88,155						
	889 + 53	892 + 00						61,895						
	892 + 00	893 + 60						50,000						
	893 + 60	894 + 90						50,000						
	894 + 90	896 + 05						50,000						
	896 + 05	897 + 10						50,000						
	897 + 10	898 + 10						50,000						
	898 + 10	899 + 20						50,000						
	899 + 20	901 + 00						50,000						
	901 + 00	902 + 40						50,000						
	902 + 40	903 + 65						50,000						
	903 + 65	909 + 25						50,000						
	909 + 25	927 + 00	452	542				56,977						
	927 + 00	930 + 37	12,238	14,685</										

I-15-7 (58) 332
I-15-8 (20) 334
IG-15-8 (18) 334

Revised Aug. 30, 1963
Revised Oct. 7, 1963

SUMMARY SHEET

WATERING, ROLLING & COMPACTION		WATERING, ROLLING & COMPACTION (CONT.)	
DESCRIPTION	USE	DESCRIPTION	USE
WATERING			
All Embankment		Rolling, PNEUMATIC TIRED OR POWER ROLLER	
I-15-7 (58) 332 533, 326 x 40 = 21, 332, 040 Yds.	22, 400 M-Yds.	Riverdale Road Acceleration Lane	
IG-15-8 (18) 334 578, 456 x 40 = 23, 130, 240 Yds.	24, 300 M-Yds.	Portland Cement Treated Base Course	
I-15-8 (20) 334 412, 433 x 40 = 16, 497, 320 Yds.	17, 300 M-Yds.	(44.17+45.5') x 600' ÷ 9ft. ² /Yd. ² ÷ 1800 Yd. ³ /Hr. = 3 Hrs.	
All Gravel Material		Gravel Base Course	
24, 337 Tons x 0.53 x 40 = 51, 594 Yds.	600 M-Yds.	(46.83' + 47.83') x 600' ÷ 9ft. ² /Yd. ² ÷ 1800 Yd. ³ /Hr. = 3 Hrs.	
GRAND TOTAL	64,600 M-Yds.	TOTAL	6 Hrs. 10 Hrs.
COMPACTION			
I-15-7 (58) 332		"F-5" Acceleration Lane	
Total Embankment 533, 326 CU. Yds.	587,000 CU. Yds.	(25.67' + 27') x 875' ÷ 9ft. ² /Yd. ² ÷ 1800 Yd. ³ /Hr. = 3 Hrs.	
I-15-8 (20) 334 412, 433 CU. Yds.	454, 000 CU. Yds.	(28.33' + 29.33') x 875' ÷ 9ft. ² /Yd. ² ÷ 1800 Yd. ³ /Hr. = 3 Hrs.	
IG-15-8 (18) 334 578, 456 CU. Yds.	636, 000 CU. Yds.	TOTAL	6 Hrs. 10 Hrs.
GRAND TOTAL	1,677,000 CU. Yds.	I-15-8 (20) 334 Project Total	740 Hrs.
ROLLING PNEUMATIC TIRED OR POWER ROLLER			
"V" Line		GRAND TOTAL	1070 Hrs.
Gravel Surface Type "A"		MECHANICAL TAMPING	
76' x 2 x 2192' ÷ 9ft. ² /Yd. ² ÷ 1800 Yd. ³ /Hr. = 206 Hrs.		I-15-7 (58) 332 700 CU. Yd. ÷ 8 CU. Yd./Hr. = 87.5 Hrs.	88 Hrs.
Gravel Base Course		I-15-8 (20) 334 350 CU. Yd. ÷ 8 CU. Yd./Hr. = 43.8 Hrs.	44 Hrs.
79' x 2192' ÷ 9ft. ² /Yd. ² ÷ 1800 Yd. ³ /Hr. = 107 Hrs.		IG-15-8 (18) 334 230 CU. Yd. ÷ 8 CU. Yd./Hr. = 28.6 Hrs.	29 Hrs.
I-15-7 (58) 332 Project Total = 313 Hrs.	330 Hrs.	GRAND TOTAL	161 Hrs.
5600 South Street			
Gravel Surface Type "A" & Gravel Base Course			
4' x 44' x 900' ÷ 9ft. ² /Yd. ² ÷ 1800 Yd. ³ /Hr. = 98 Hrs.			
TOTAL	98 Hrs.		
"R-7", "R-8", "R-9" & "R-10" Lines	110 Hrs.		
Gravel Surface Type "A"			
32' x 2 x 8632.22' ÷ 9ft. ² /Yd. ² ÷ 1800 Yd. ³ /Hr. = 341 Hrs.			
Gravel Base Course			
35' x 8632.22' ÷ 9ft. ² /Yd. ² ÷ 1800 Yd. ³ /Hr. = 186 Hrs.			
TOTAL	527 Hrs.		
"F-5" Line Sta. 10+00 to 17+88.16' 16' Median	560 Hrs.		
Sta. 17+88.16 to 57+08.35' 0' Median			
Gravel Surface Type "A"			
(46' + 48') x 788.16' ÷ 9ft. ² /Yd. ² ÷ 1800 Yd. ³ /Hr. = 5 Hrs.			
(30' + 32') x 3920.19' ÷ 9ft. ² /Yd. ² ÷ 1800 Yd. ³ /Hr. = 15 Hrs.			
Gravel Base Course			
50' x 788.16' ÷ 9ft. ² /Yd. ² ÷ 1800 Yd. ³ /Hr. = 2 Hrs.			
34' x 3920.19' ÷ 9ft. ² /Yd. ² ÷ 1800 Yd. ³ /Hr. = 8 Hrs.			
TOTAL	30 Hrs.		
"F-5A" Line	40 Hrs.		
Gravel Surface & Gravel Base			
(18 + 20 + 22) x 287 ÷ 9ft. ² /Yd. ² ÷ 1800 Yd. ³ /Hr. 1 Hr.			
TOTAL	1 Hrs.		
	10 Hrs.		

I-15-7 (58)332
I-15-8 (20)334
IG-15-8 (18)334

Revised Aug. 30, 1963
Revised Sept. 16, 1963
Revised Oct. 7, 1963

SUMMARY SHEET

MEDIAN CURB TYPE "E"			
LINE	STATION FROM	TO	LINEAR FEET
"V"	10+60	14+43	667
"V"	15+27	19+18	815
"V"	19+75	21+69	430
TOTAL			1912
USE			1910
5600 SO.	4+20	6+15	397
5600 SO.	6+74	11+33	940
5600 SO.	12+52	13+20	140
"F-5"	10+60	17+02	1380
TOTAL			2857
USE			2860
PROJECT TOTAL			4770

MISCELLANEOUS				
DESCRIPTION OF ITEM	I-15-7 (58)332	I-15-8 (20)334	IG-15-8 (18)334	TOTAL
Furnishing Construction Signs	Lump	Lump	Lump	Lump
Flagging	600 Mn/Hr	1000 Mn/Hr	0	1600 Mn/Hr
Furnishing Water Equipment	Lump	Lump	Lump	Lump
12' Gates Chain Link	2 EA	0		2 EA
Metal Bin Type Retaining Wall Type "A"	0	0	1000 SF	1000 SF
Metal Bin Type Retaining Wall Type "B"	0	0	762 SF	762 SF
Right of Way Markers	30 EA	30 EA	4 EA	64 EA
Obliteration of Old Road	0.5 Mi	0	0	0.5 Mi
Excavation and Stockpiling Topsoil	0	20,000 CY	0	20,000 CY
Demolition of Buildings, Basements, Foundations and Slabs.	Lump	Lump	0	Lump
Removal of Trees	0	1530 EA	30 EA	1560 EA


DESCRIPTION	PROJECT	UNIT	QUANTITY	QUANTITY	QUANTITY	TOTAL
			I-15-7(58) 332	I-15-8(20)334	IG-15-8(18)334	
Furnishing Construction Signs		LUMP	LUMP	LUMP	LUMP	LUMP
Removal of Trees		Each	0	14127	1530	30
Flagging		Man Hr.	600	1000		1600
Unclassified Roadway Excavation		CU. YD.	303,000	1,248,000	0	1,551,000
Excavation for Structures Unclassified		CU. YD.	1100	450	100	1650
Demolition of Buildings, Basements, Foundations and Slabs		LUMP	LUMP	LUMP	LUMP	LUMP
Mechanical Ramping		HOUR	88	44	29	161
Imported Borrow		CU. YD.	53,400			53,400
Compaction Method "B"		CU. YD.	560,000	433,000	607,000	1,600,000
Rolling Pneumatic Tired or Power Roller		HOUR	330	740	0	1070
Class "A" Overhaul		STA. YD.	3,278,000	2,920,000	6,073,000	12,271,000
Class "B" Overhaul		YD. MILE	918,000	107,000	446,000	1,471,000
Furnishing Water Equipment		LUMP	LUMP	LUMP	LUMP	LUMP
Watering		M-GAL.	22,400	17,900	24,300	64,600
Right of Way Fence 6' Chain Link		LIN. FT.	24,865	21,069	4438	50,378
12' Gates Chain Link		EACh	2			2
12" Reinforced Concrete Pipe		LIN. FT.		300		300
24" Reinforced Concrete Pipe		LIN. FT.	1434	5560	508	7502
30" Reinforced Concrete Pipe		LIN. FT.		198		198
24" Reinforced Concrete End Sections		EACh	22	21	4	47
30" Reinforced Concrete End Sections		EACh	4			4
Gravel Base Course		TON	1600	9600		11,200
Portland Cement Treated Base Course		TON		4000		4000
Portland Cement Type I		BAG		1700		1700
Bituminous Material MC-400		TON	20	90		110
Bituminous Material MC-800		TON	10	50		60
Bituminous Material MC-70		TON	10	40		50
Gravel Surface Type "A"		TON	2660	14,400		17,060
Bituminous Material 60-70 Penetration		TON	90	480		570
Bituminous Surface Course 1" MAX.		TON	1590	9265		10,855
Cover Material Type "A"		TON	110	530		640
Surface Ditches		LIN. FT.		1700	1900	3600
Small Ditch Excavation		CU. YD.		130	100	230
Concrete Curb "E"		LIN. FT.	1910	2860		4770
Deep Beam Highway Guard Rail		LIN. FT.	187	249		436
Metal Bin Type "A" Wall		SQ. FT.			1000	1000
Metal Bin Type "B" Wall		SQ. FT.			762	762
Right of Way Markers		EACh	30	30	4	64
Obliteration of Old Road		MILE	0.5			0.5
Drop Inlet Type "C"		EACh	2	9	3	14
Excavation and Stockpiling Topsoil		CU. YD.	0	20,000	0	20,000
Concrete Class "A" Air Entaining		CU. YD.		30		30
Reinforcing Steel		LBS.		3300		3300
Structural Steel		LBS.		4800		4800
Hydrated Lime		TON	16	90		106



SUMMARY SHEET

FED. RD&D
IND. 10
UTAH

DRAINAGE

LINE	STATION	DESCRIPTION	MEDIAN DROP INLET REQ'D EACH	RCP. REQ'D.			RCP. END SEC REQ'D.			SURFACE DITCH REQ'D.-LIN. FT.			STRUCT. EXC. CU. YDS.	MECH. TAMPING CU. YD.	SMALL DITCH EXC. CU. YD.	CLASS "A" CONCRETE CU. YD.	REIN. STEEL LBS.	STRUCT. STEEL LBS.	STANDARD DRAWING AND LINE NUMBER	REMARKS		
				24"	30"	48"	24"	30"	12"	STA.	STA.	LT.	RT.	LENGTH								
Main	721 + 80	Drop Inlet - Cross Drainage	1	250		2									93	55				346	C	
"U"	17 + 35	Surface Drainage		78		2										4						
"T"	15 + 85	Surface Drainage		68		2										4						
Main	763 + 65	Drop Inlet	1	300											82	96				346	C	
	784 + 00	Cross Drainage		192		4									185	80						
	795 + 00	Cross Drainage			198		4								180	185						
	806 + 00	Cross Drainage			174		4								142	72						
	817 + 00	Cross Drainage			178		4								145	72						
	827 + 00	Cross Drainage			194		4								187	80						
	TOTAL	I-15-7 (58) 332	2	1434	198	22	4								1014	648						
	USE		2	1434	198	22	4								1100	700						
Main	849 + 00	Drop Inlet - Cross Drainage	1	234		2									75	96				346	C	
	860 + 00	Cross Drainage		274		2									900	100				346	C	
	TOTAL	I-15-8 (18) 334	3	508		4									1900	75	208	100		346	C	
	USE		3	508		4									1900	100	230	100		346	C	
	839 + 50	Drop Inlet-Cross Drainage	1	192		2									836+15	839+50	Lt.	335		346	C	
															871+00	879+00	Lt.	800				
	880 + 00	Median Drain S.B. Lane	1	124		1												52		346	C	
	890 + 00	Drop Inlet - Cross Drainage	1	156		2										72	64			346	C	
"F-3"	13 + 85	Cross Drainage		124												51						
															10+60	15+50	Lt.	490				
"F-5																						

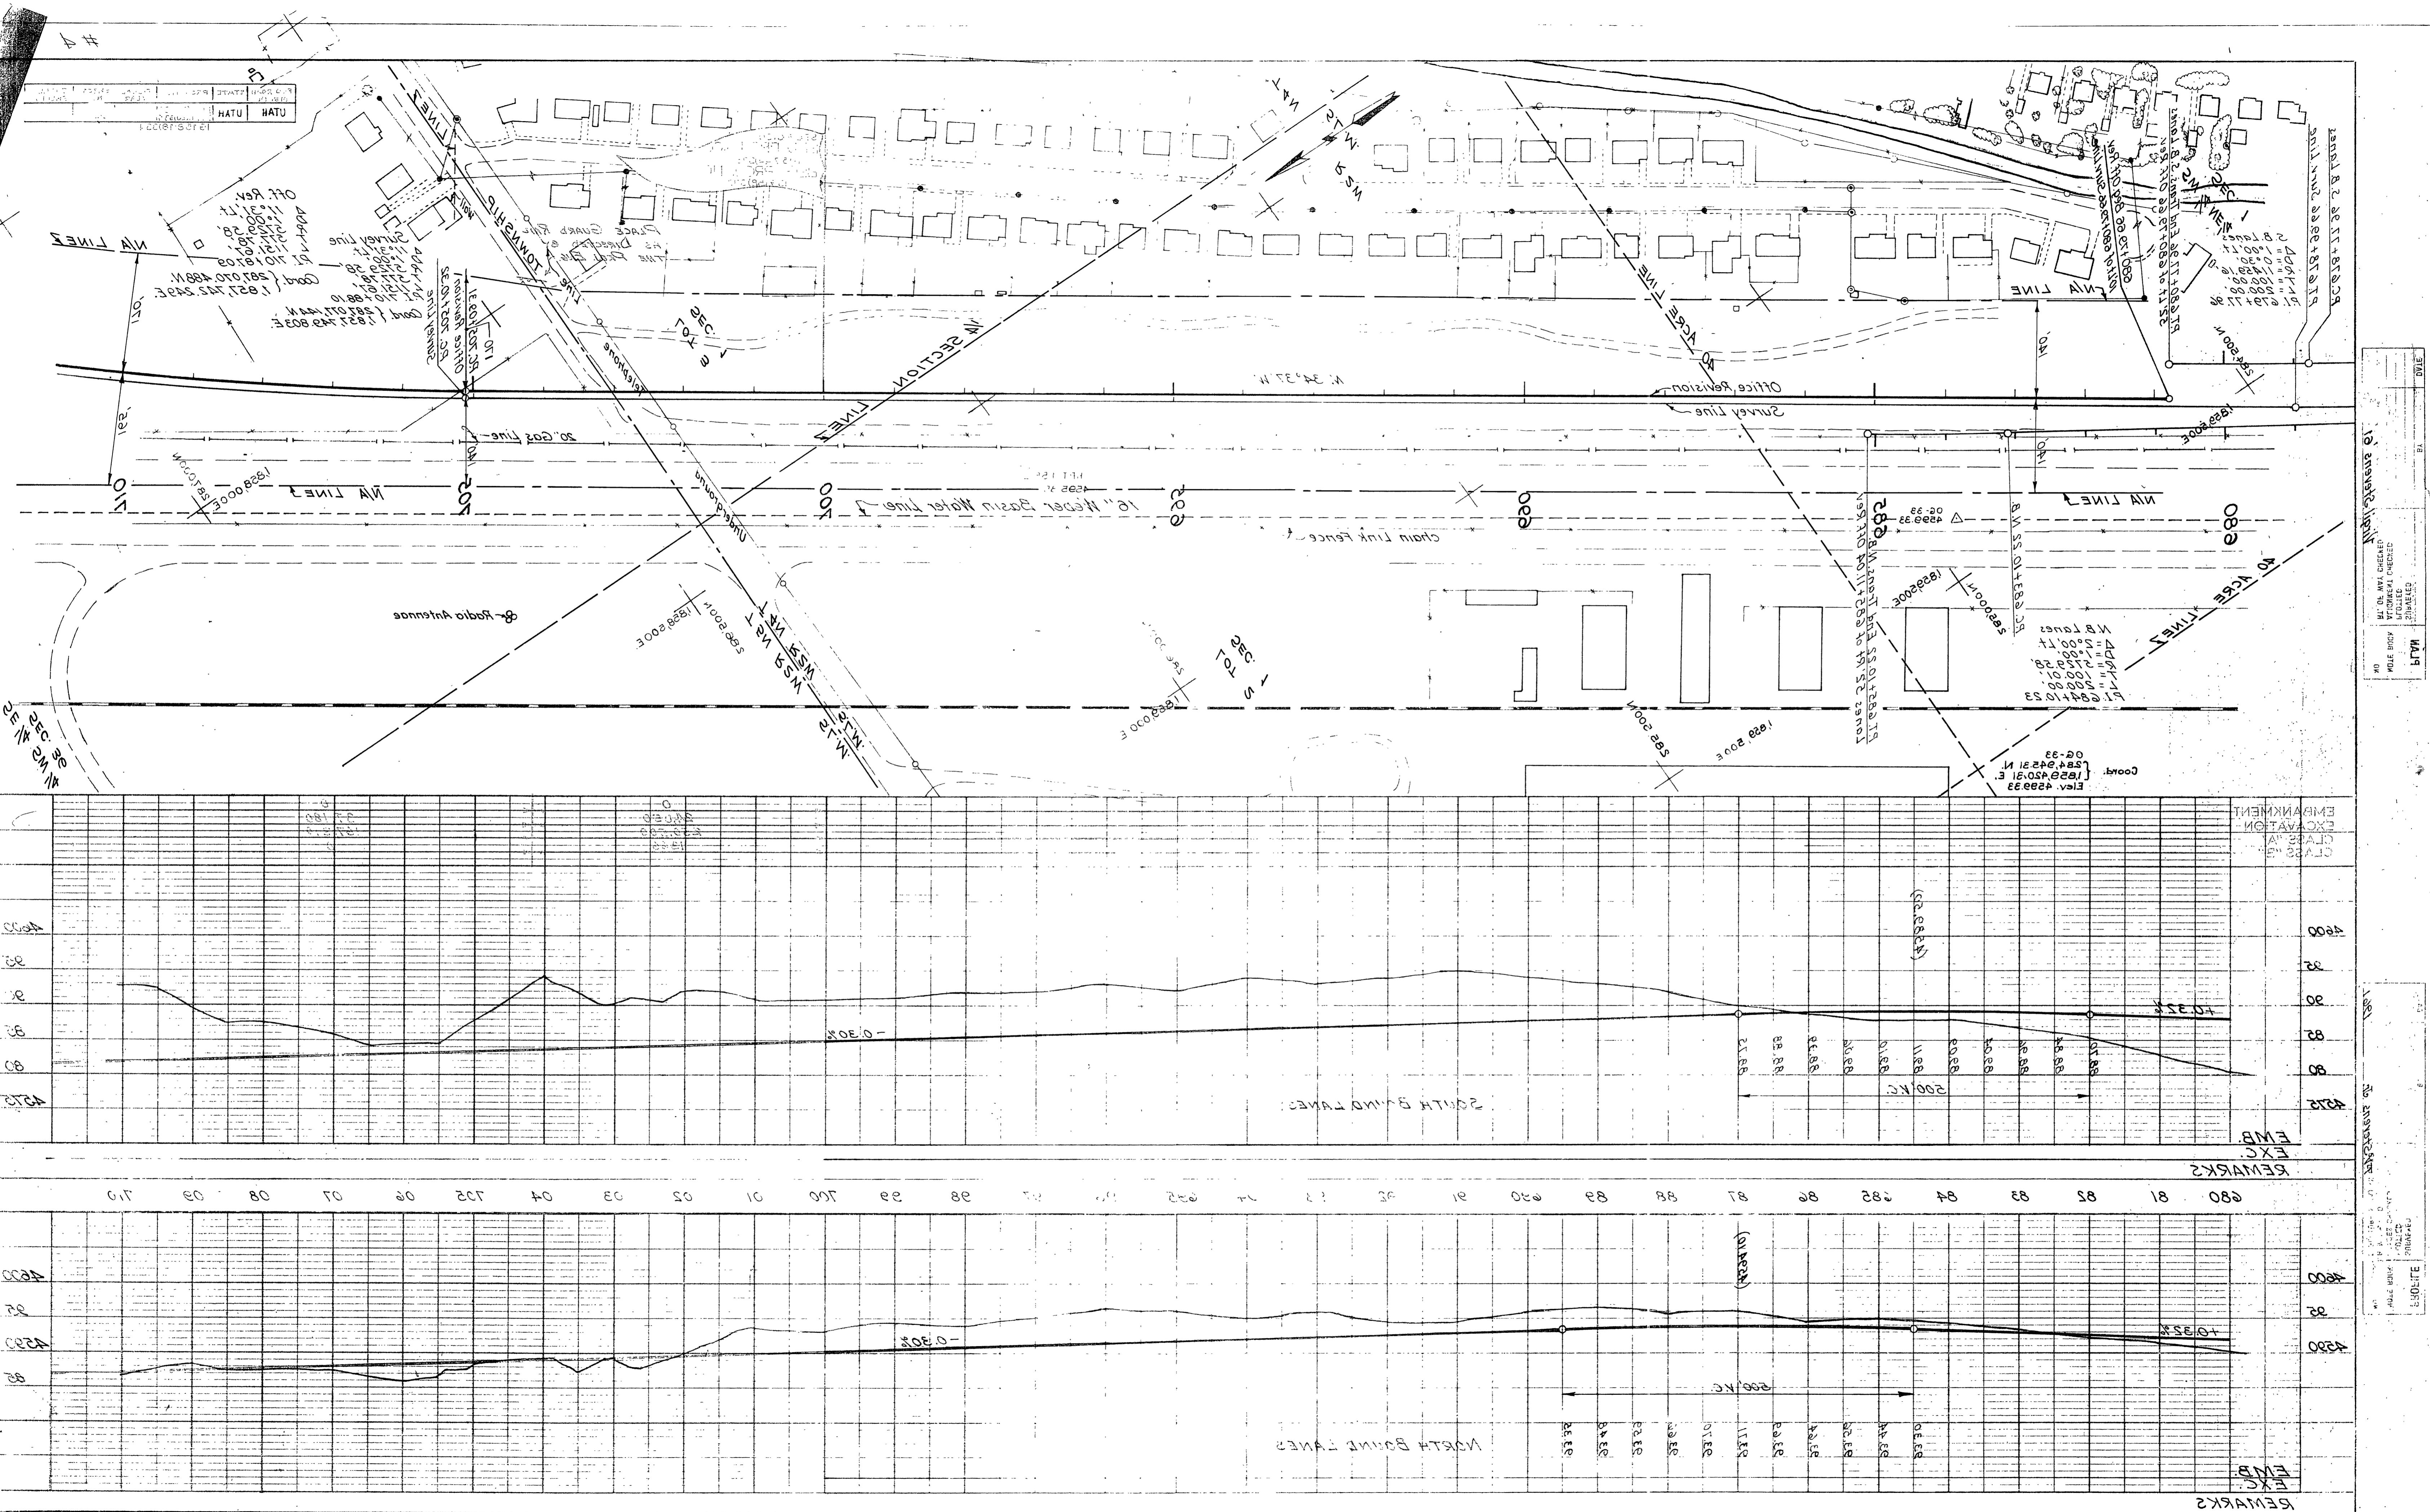


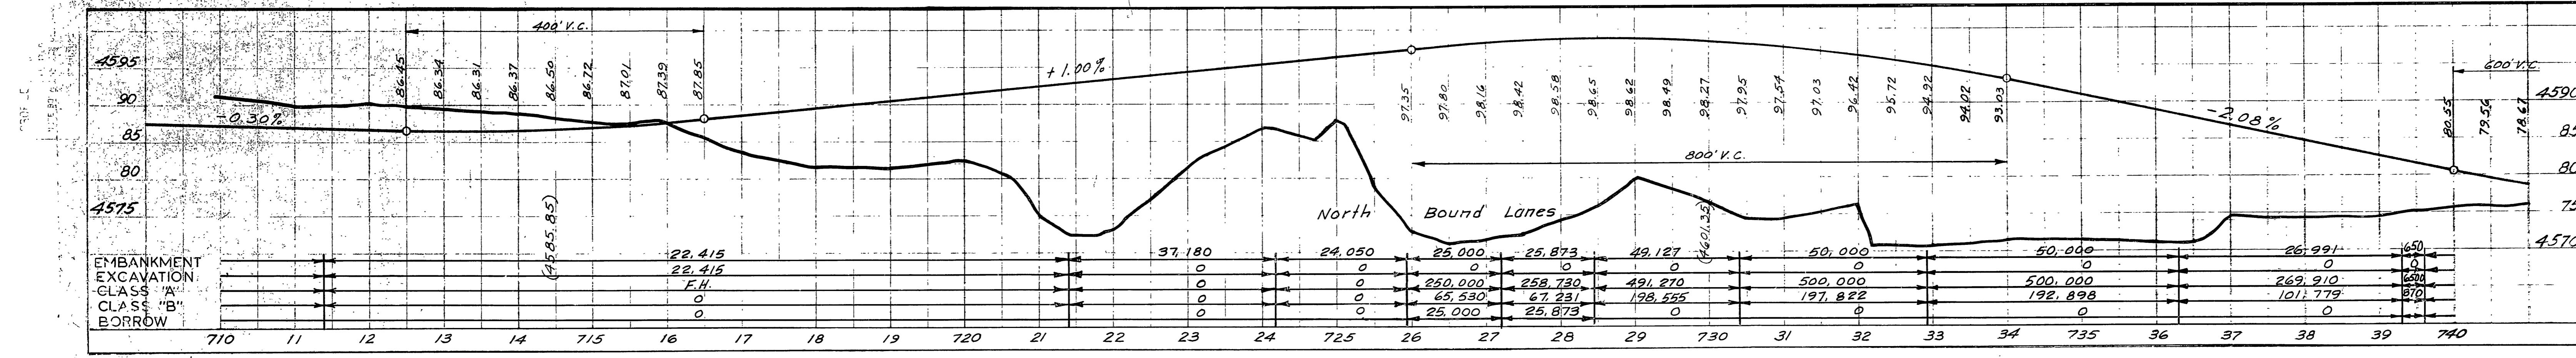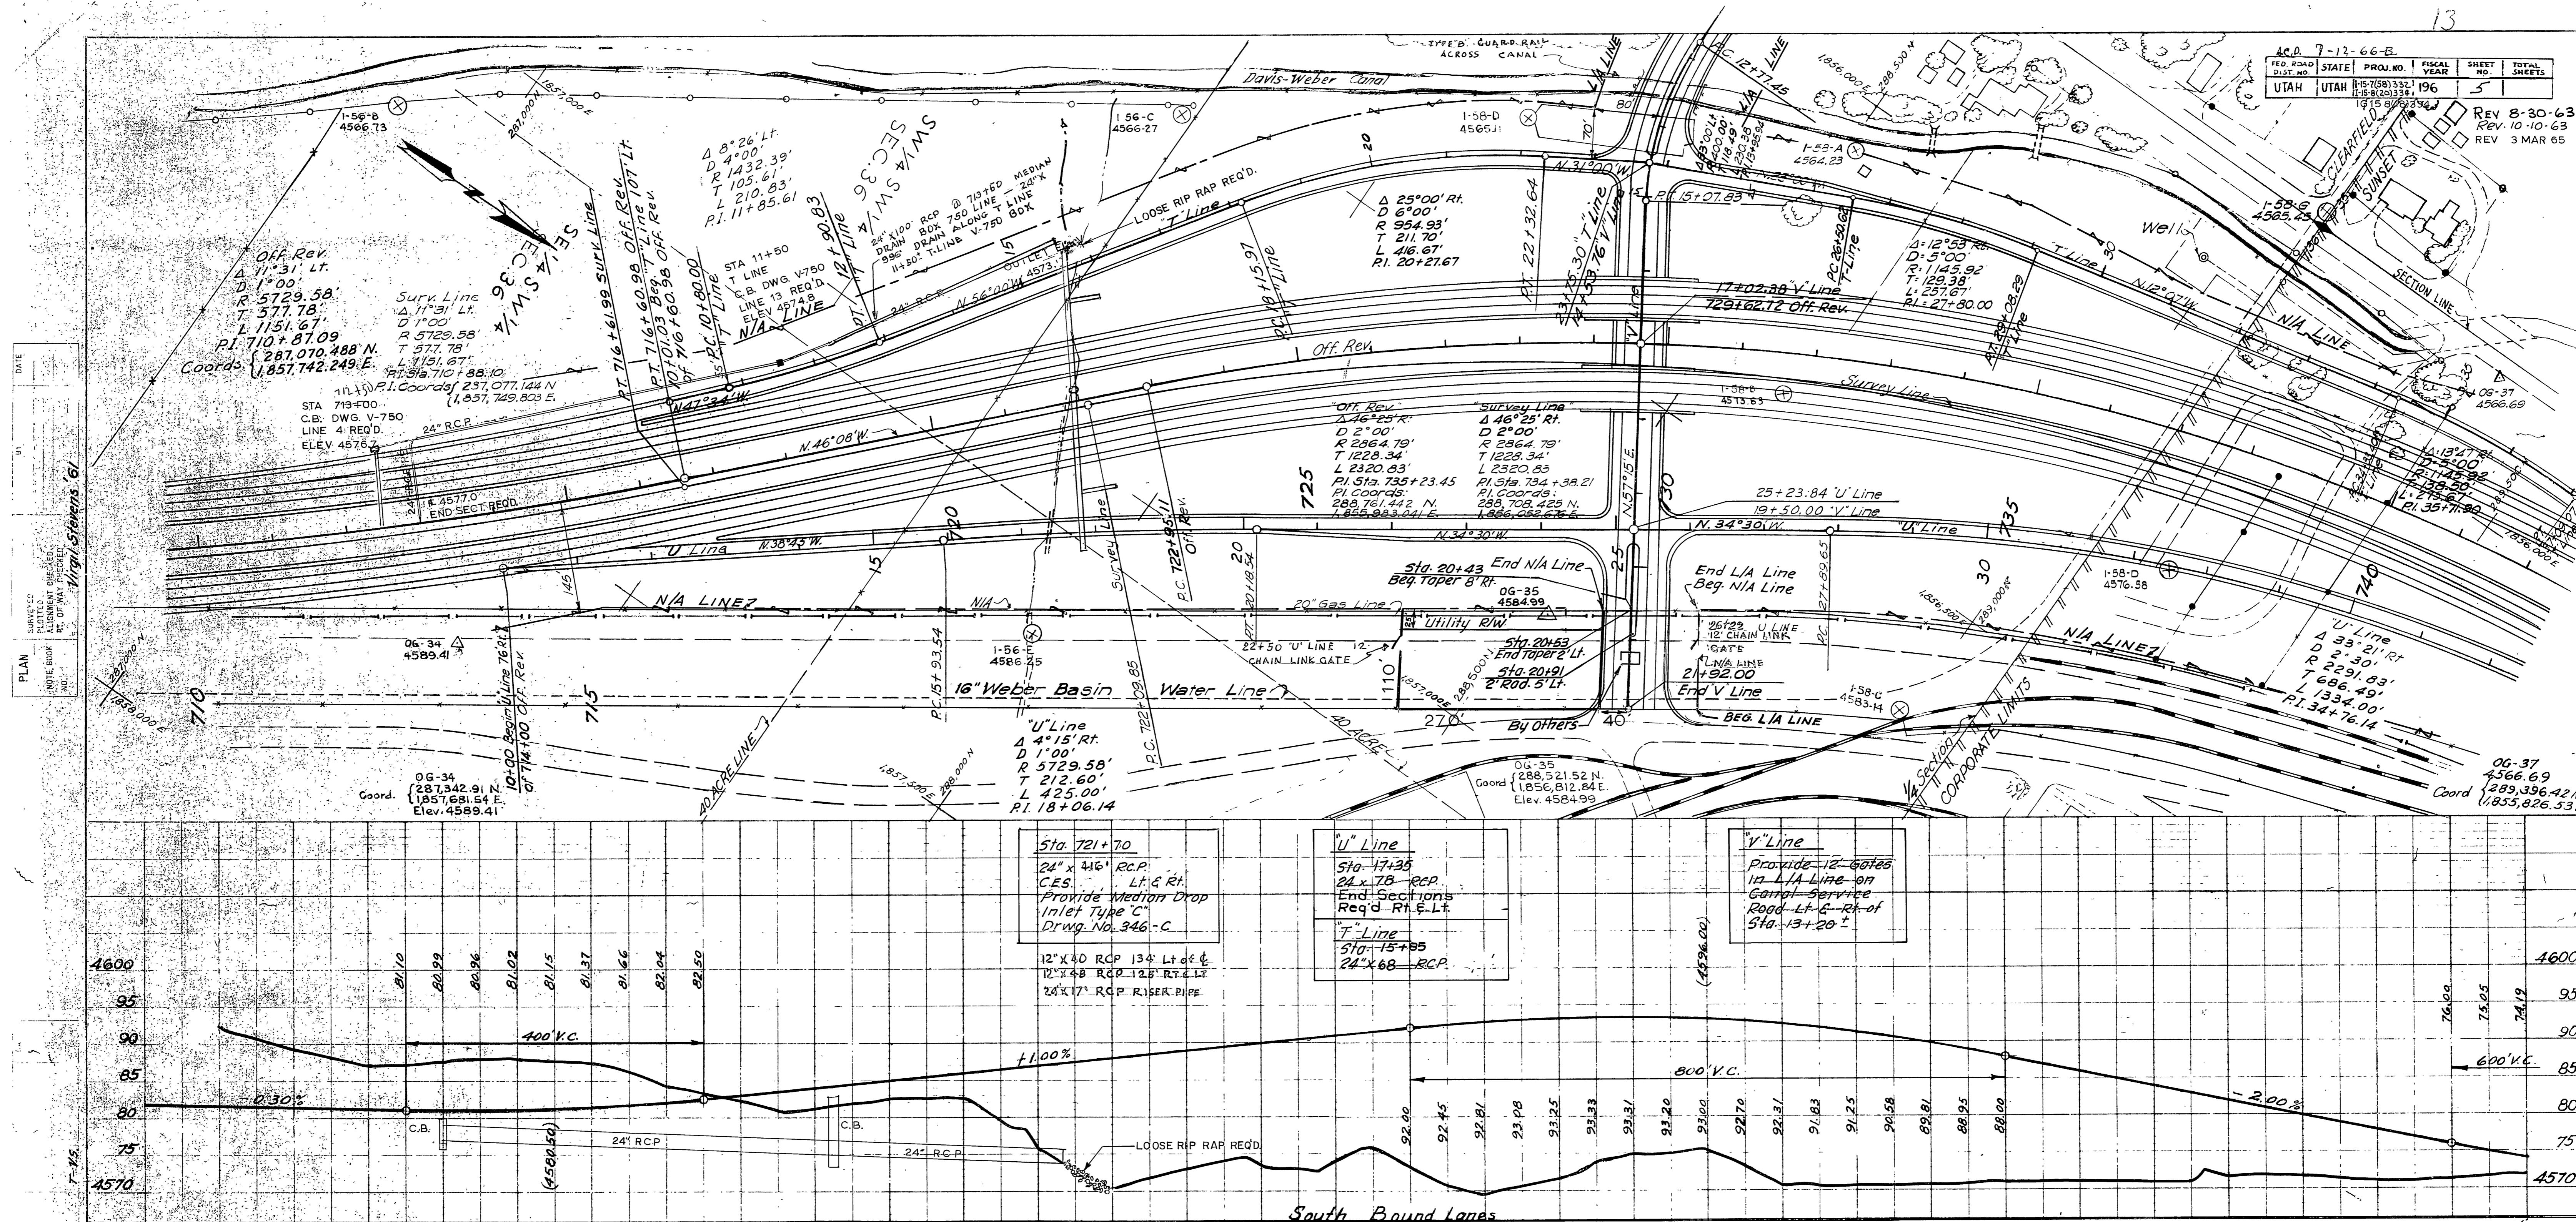

D. ROAD ST. NO.	STATE	PROJ. NO.	FISCAL YEAR	HEET NO.	TOTAL SHEETS
UTAH	UTAH	1-15-7(58)334 1-15-8(20)334	196	6	

Rev. 7-12-68 B IG15 B(18)334 Rev. 1-27-64
Rev. 8-30-63 REV 3-24-64
Rev. 9-16-63


HILL FIELD INTERCHANGE

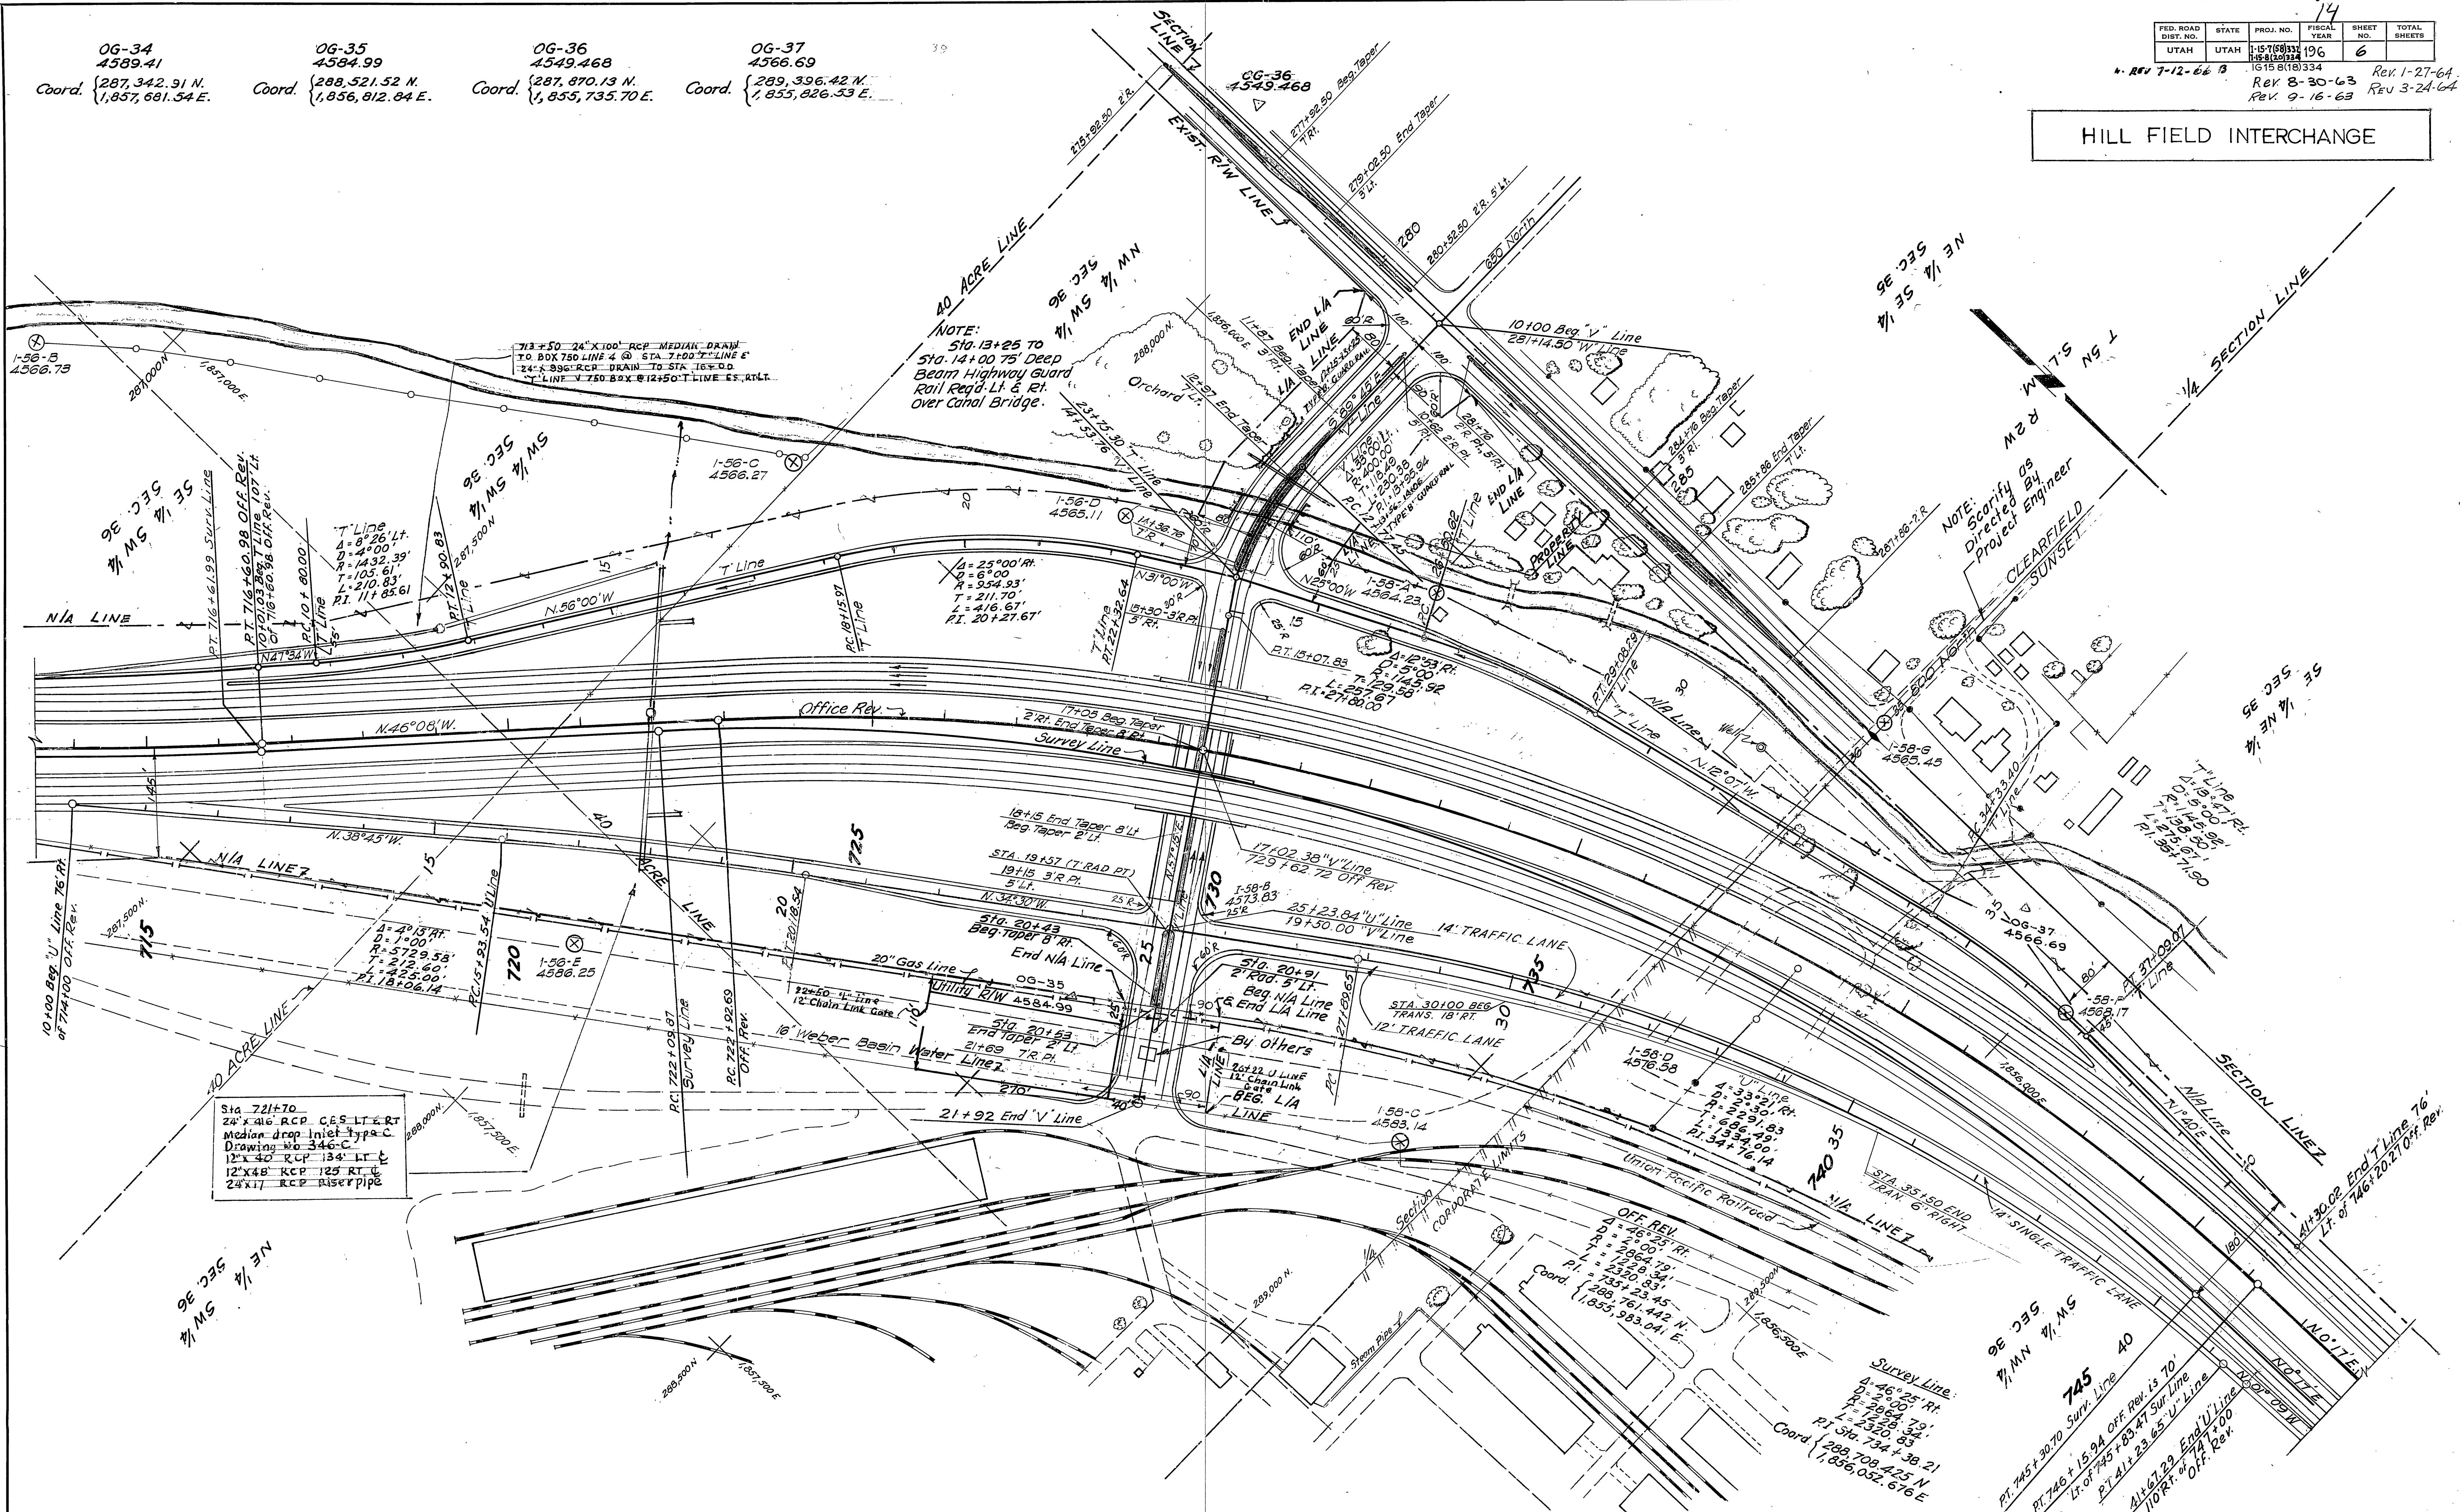


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-12 (v6 R)

AD D.	PROJ. NO.	STATE	FISCAL YEAR	SHEET NO.	TOTAL SHEETS
H	1-15-7(58)332	UTAH	1962	7	
	1-15-8(20)334				
	1G158(18)334				

ALL FIELD INTERCHANGE


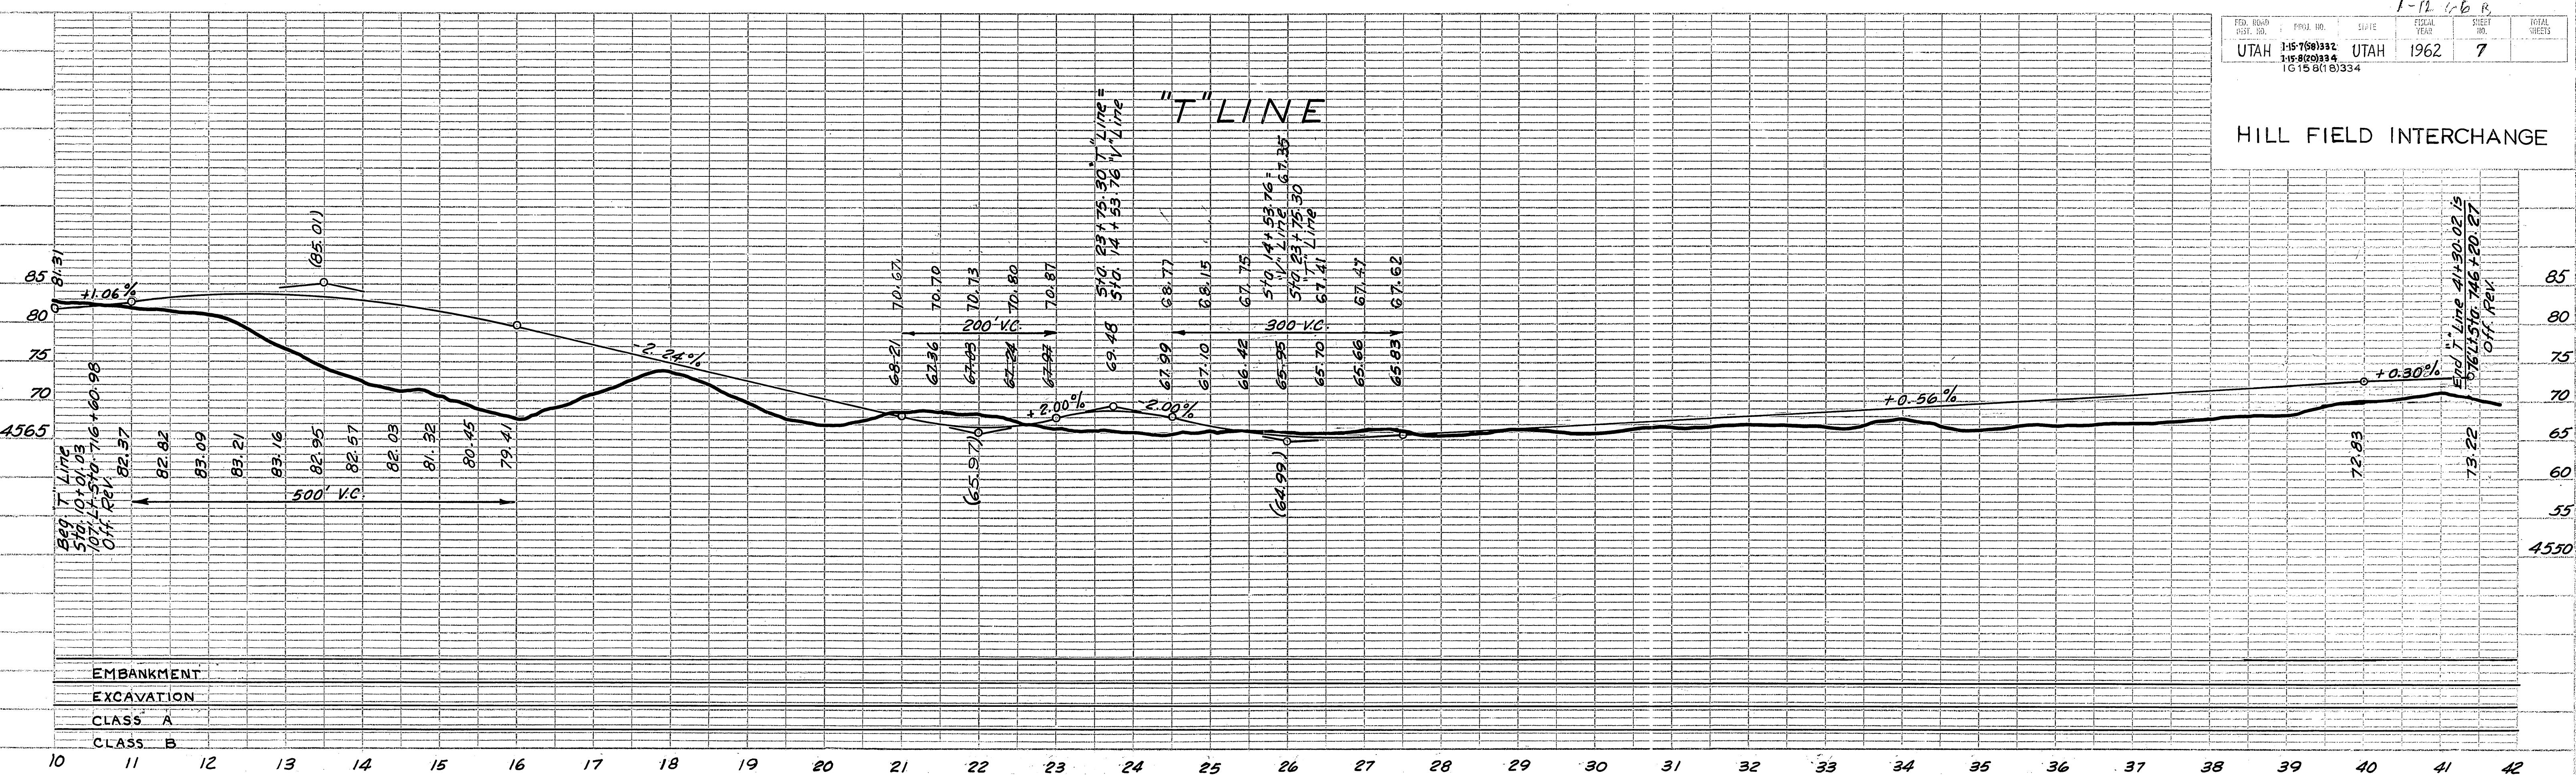



**EMBANKMENT
EXCAVATION
CLASS A
CLASS B**

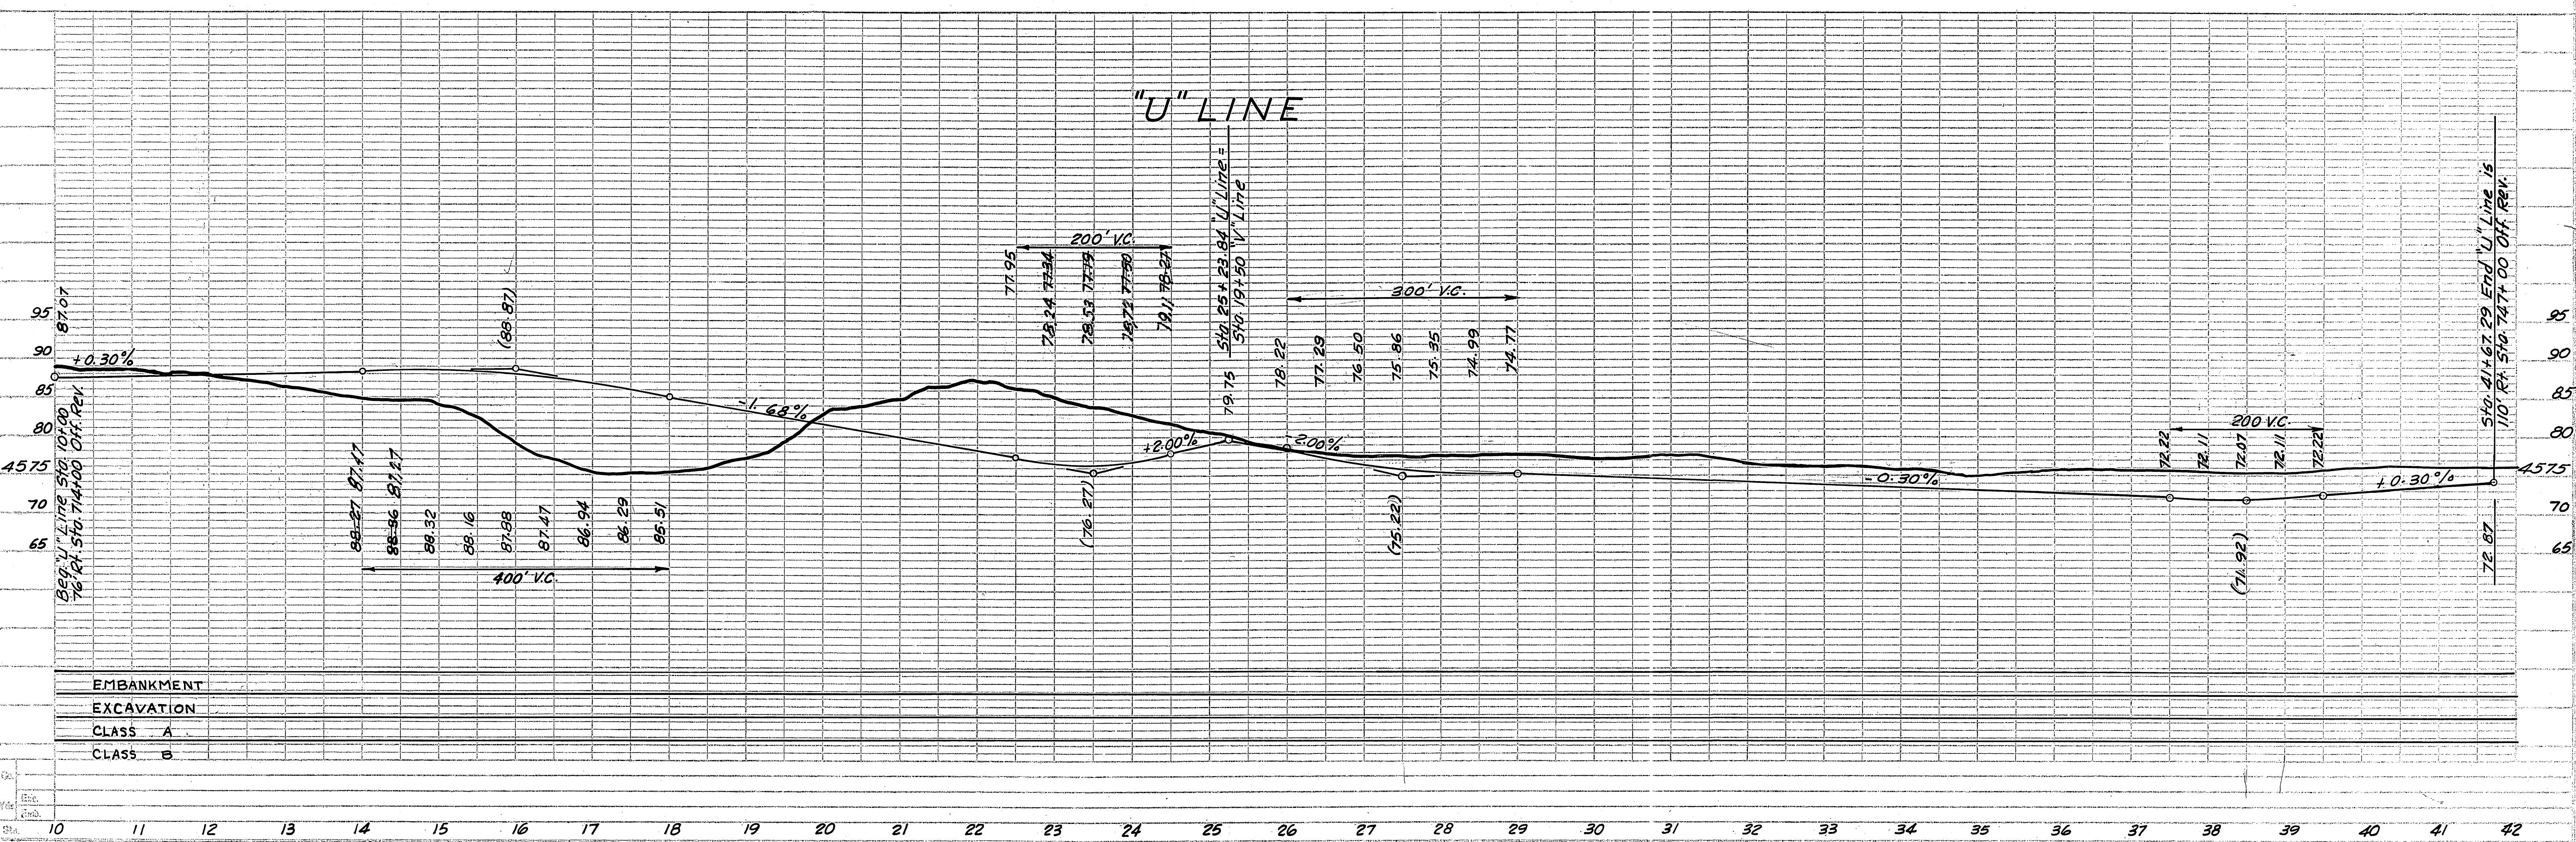

FED. ROAD REC. NO.	PROJ. NO.	STATE	FISCAL YEAR	SHEET NO.	TOTAL SHEETS
I-157 (6133)					
I-158 (2933)					
IG 15 6 (18) 334					


A.E. REV. 7-18-66 B.

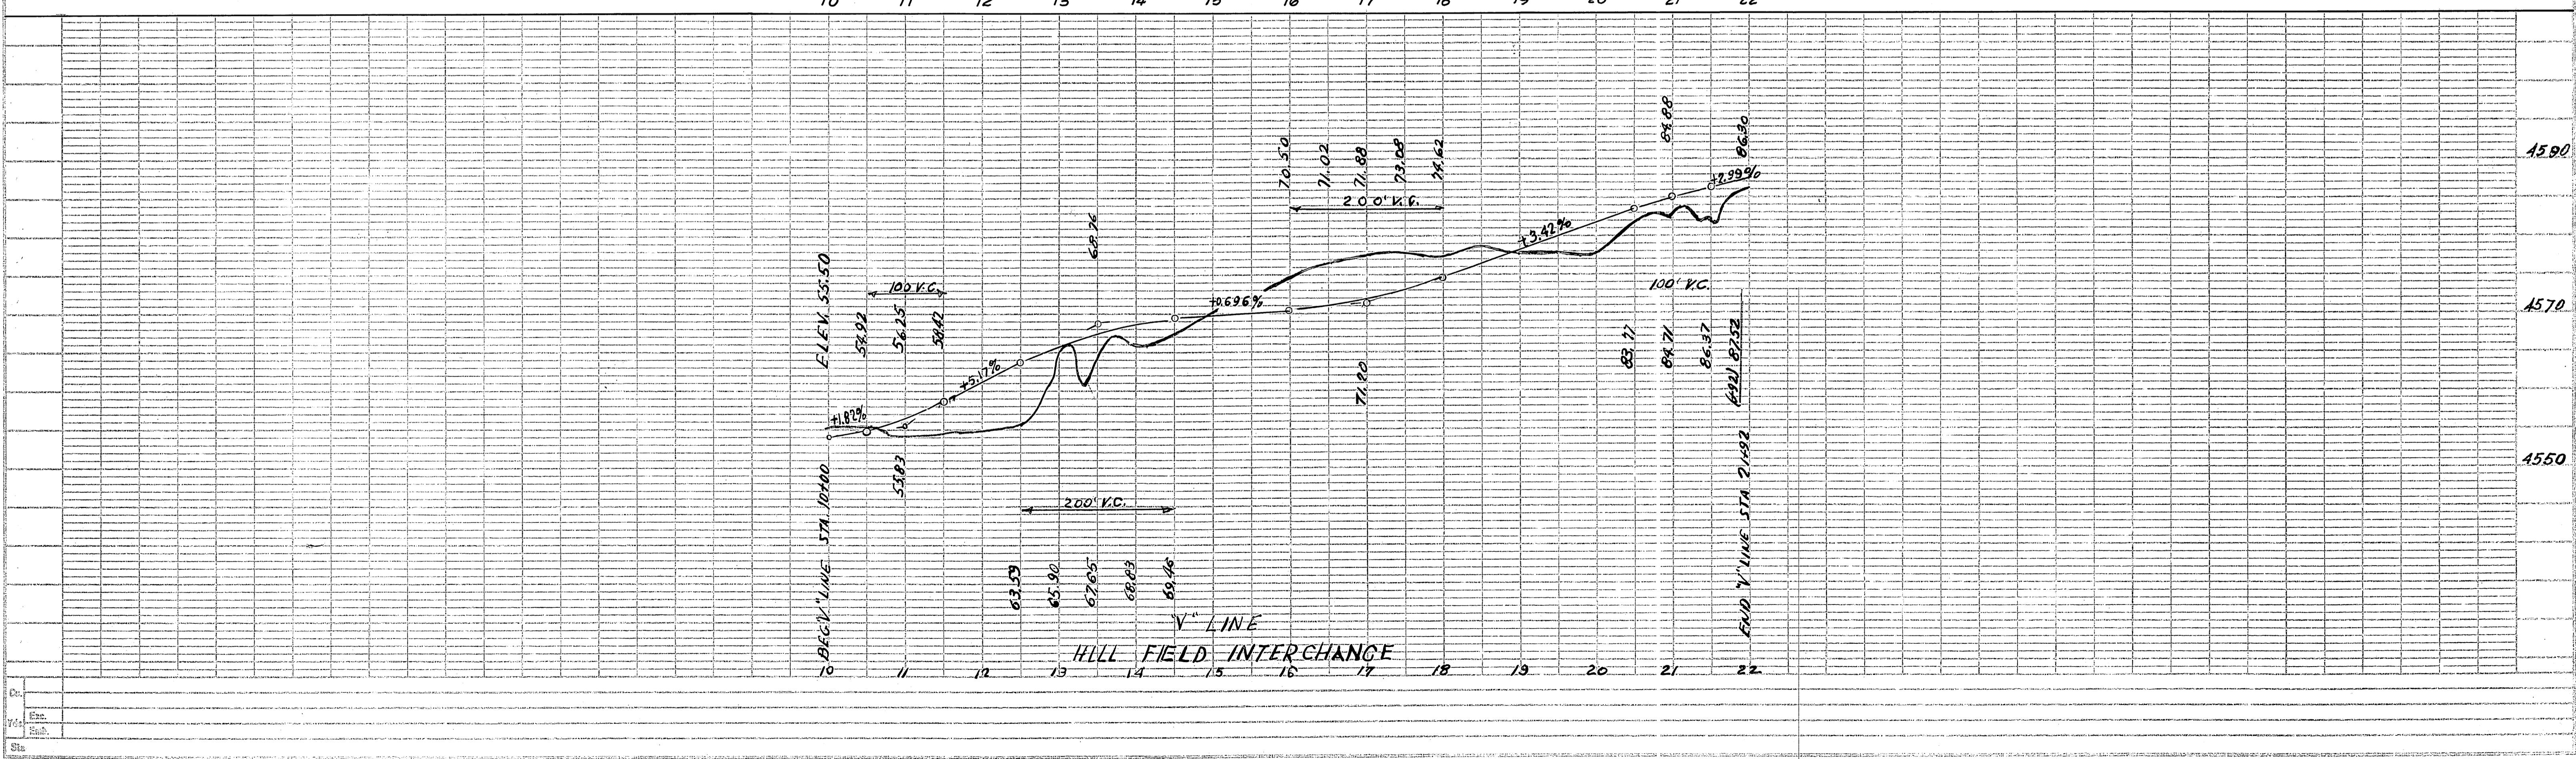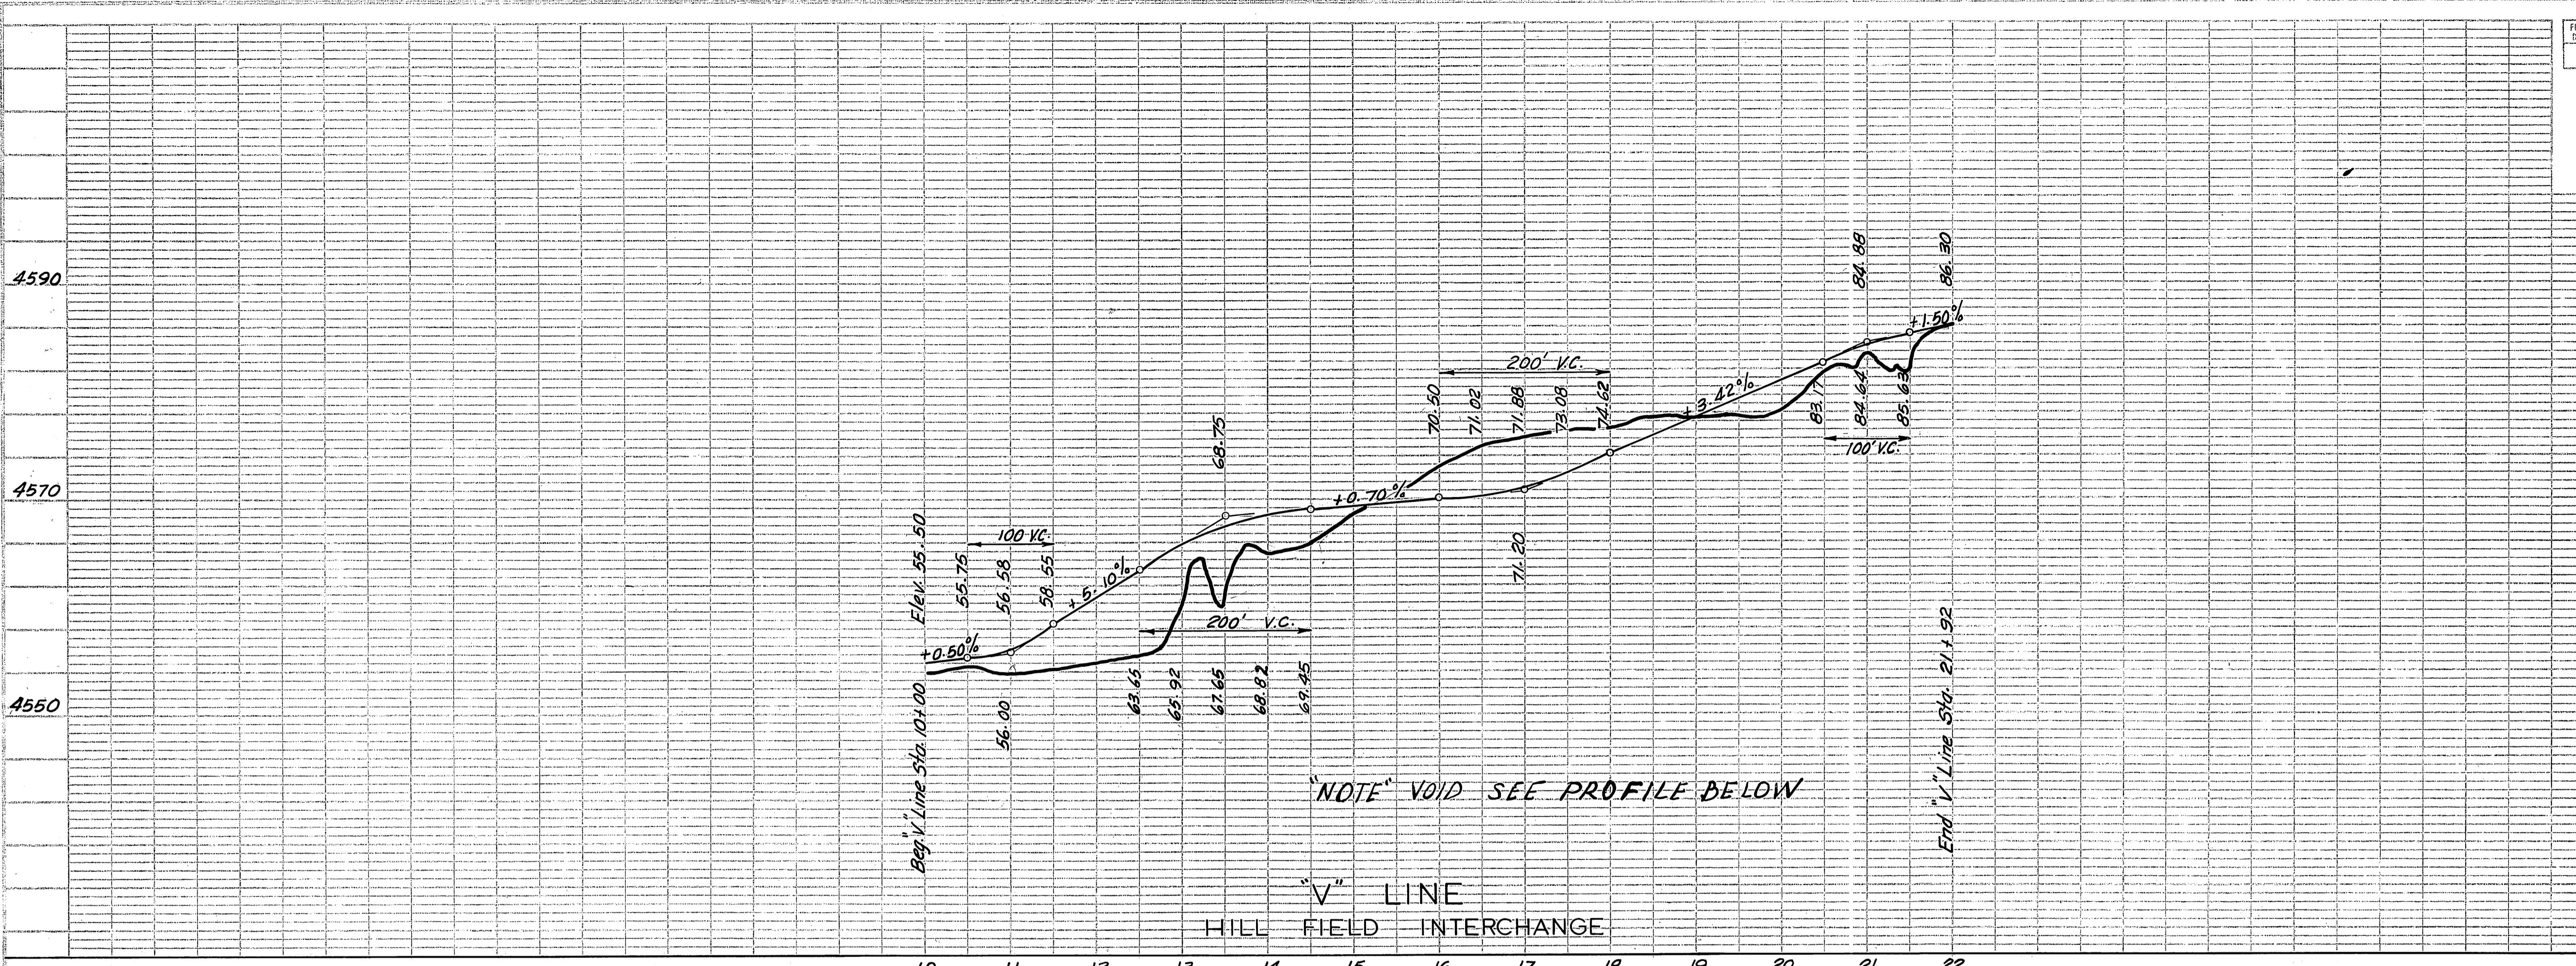


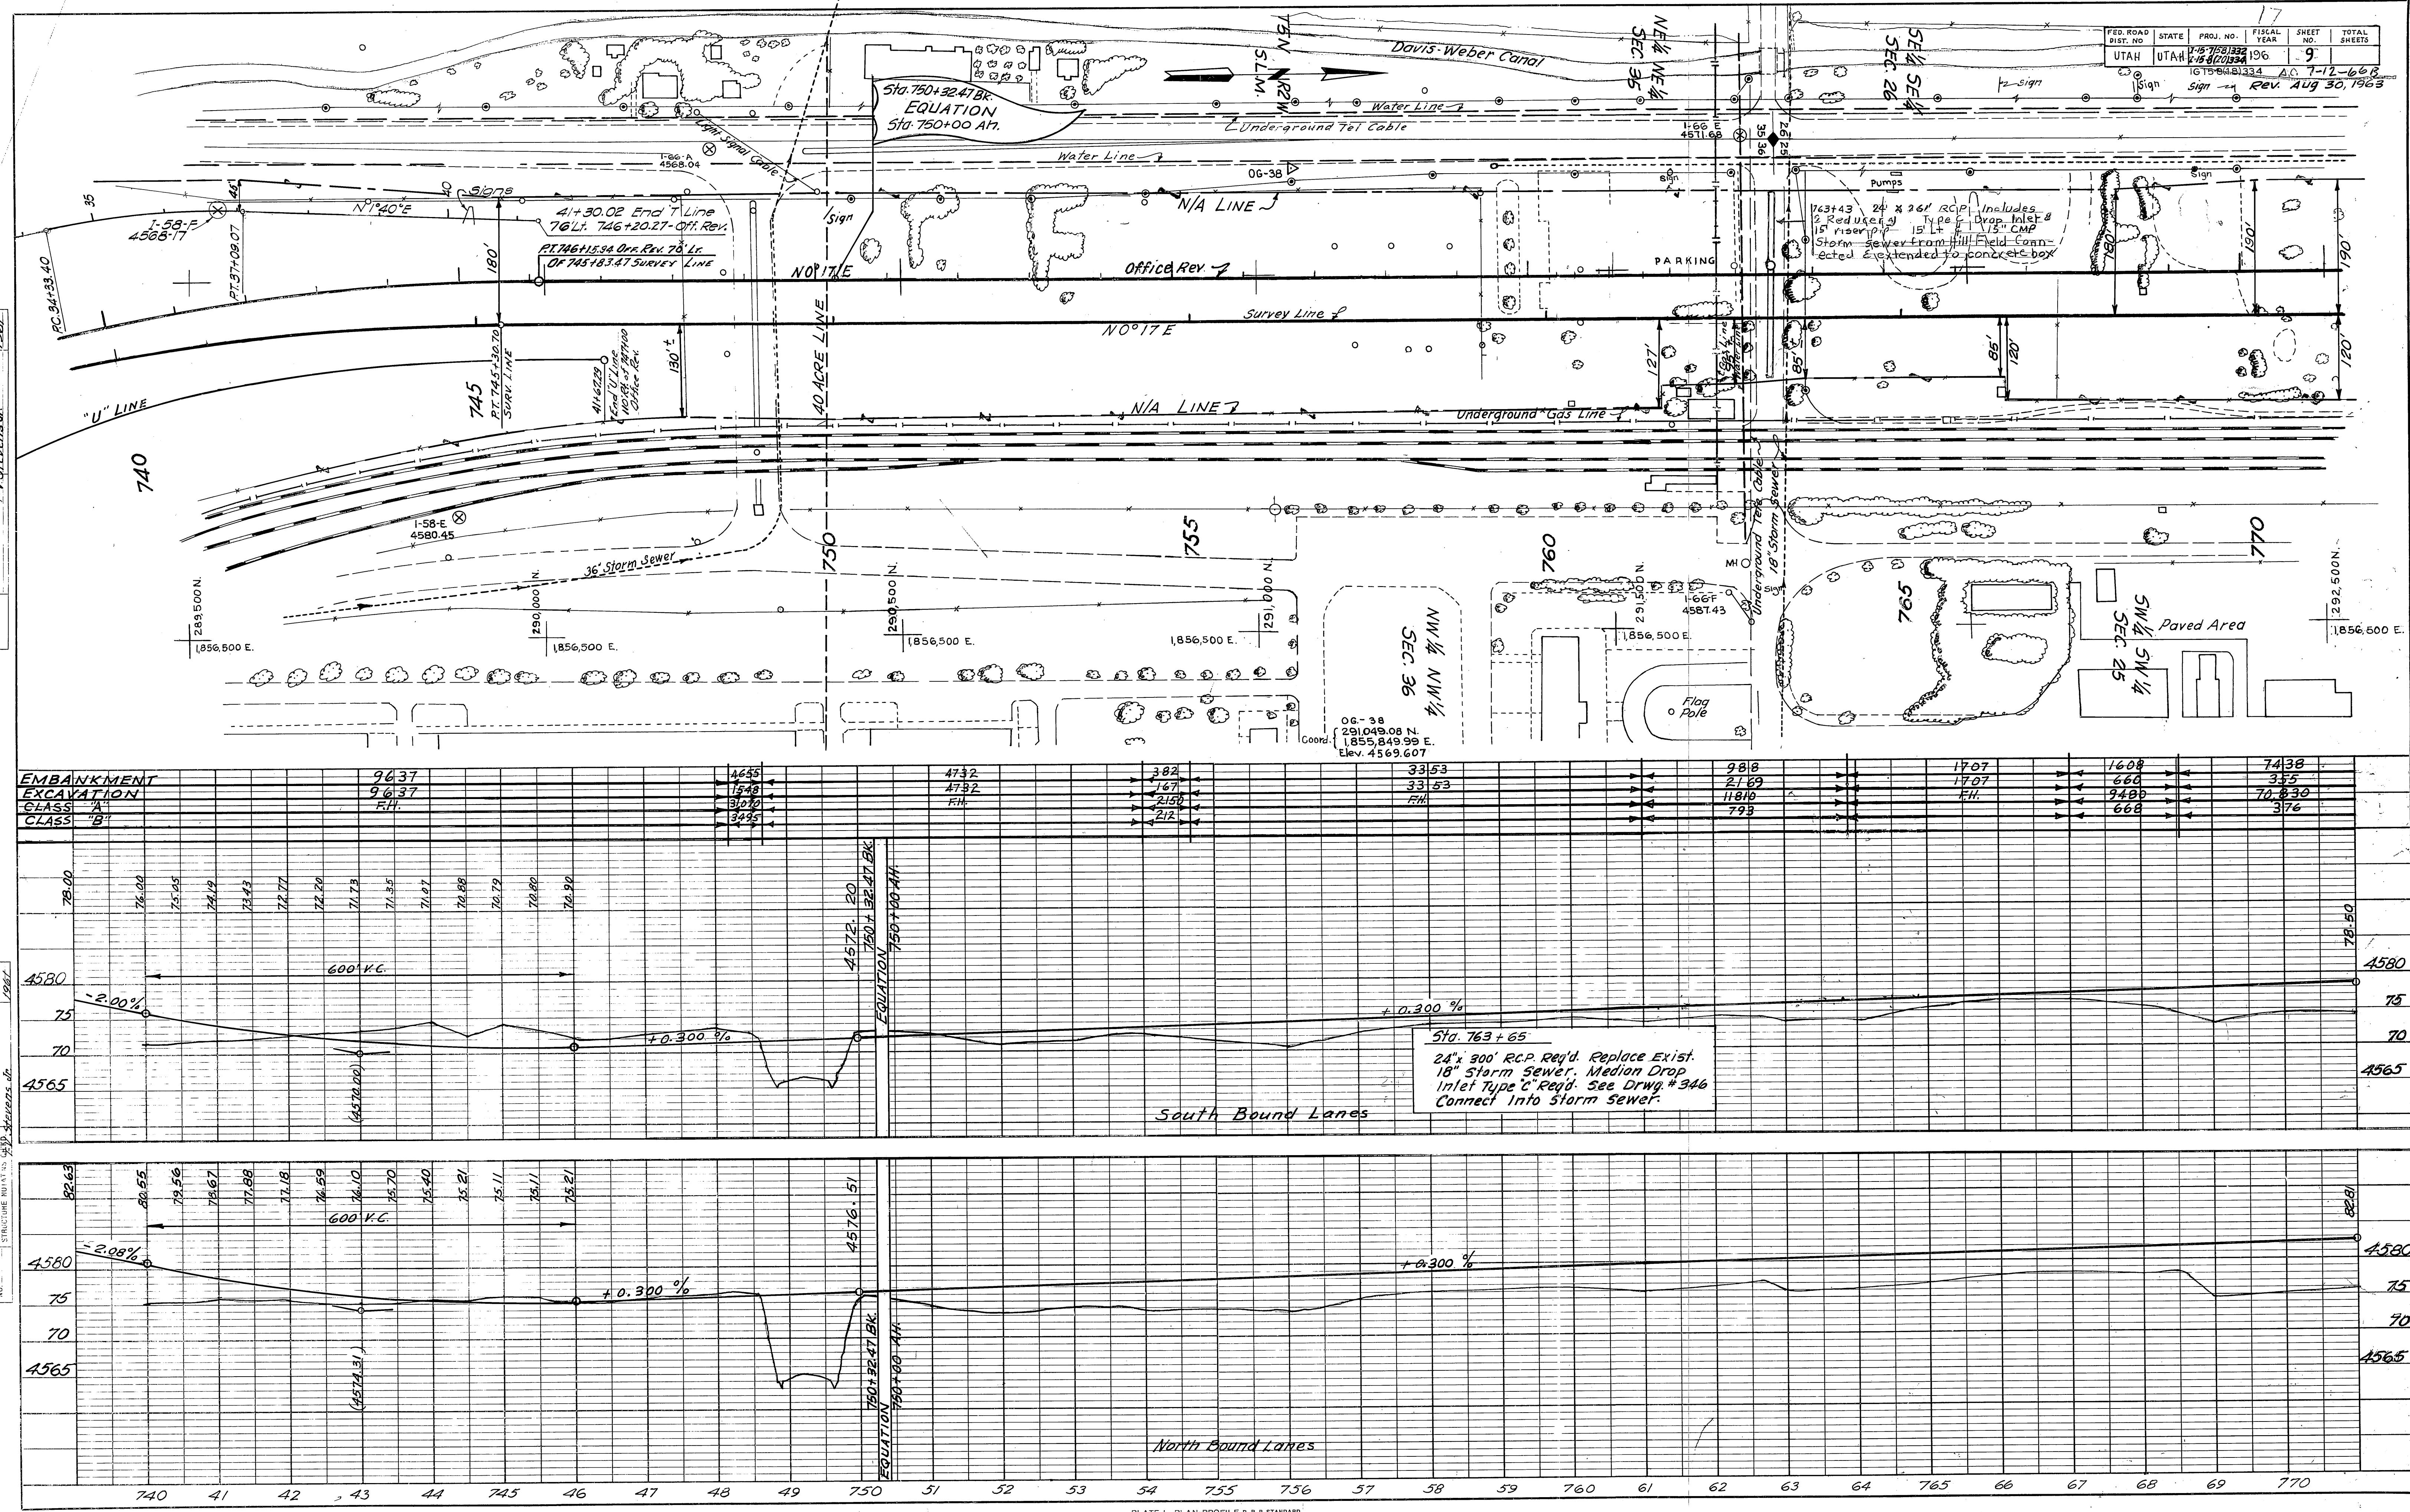


T. V. Stevens Jr. 1961


T. V. Stevens Jr.
1961

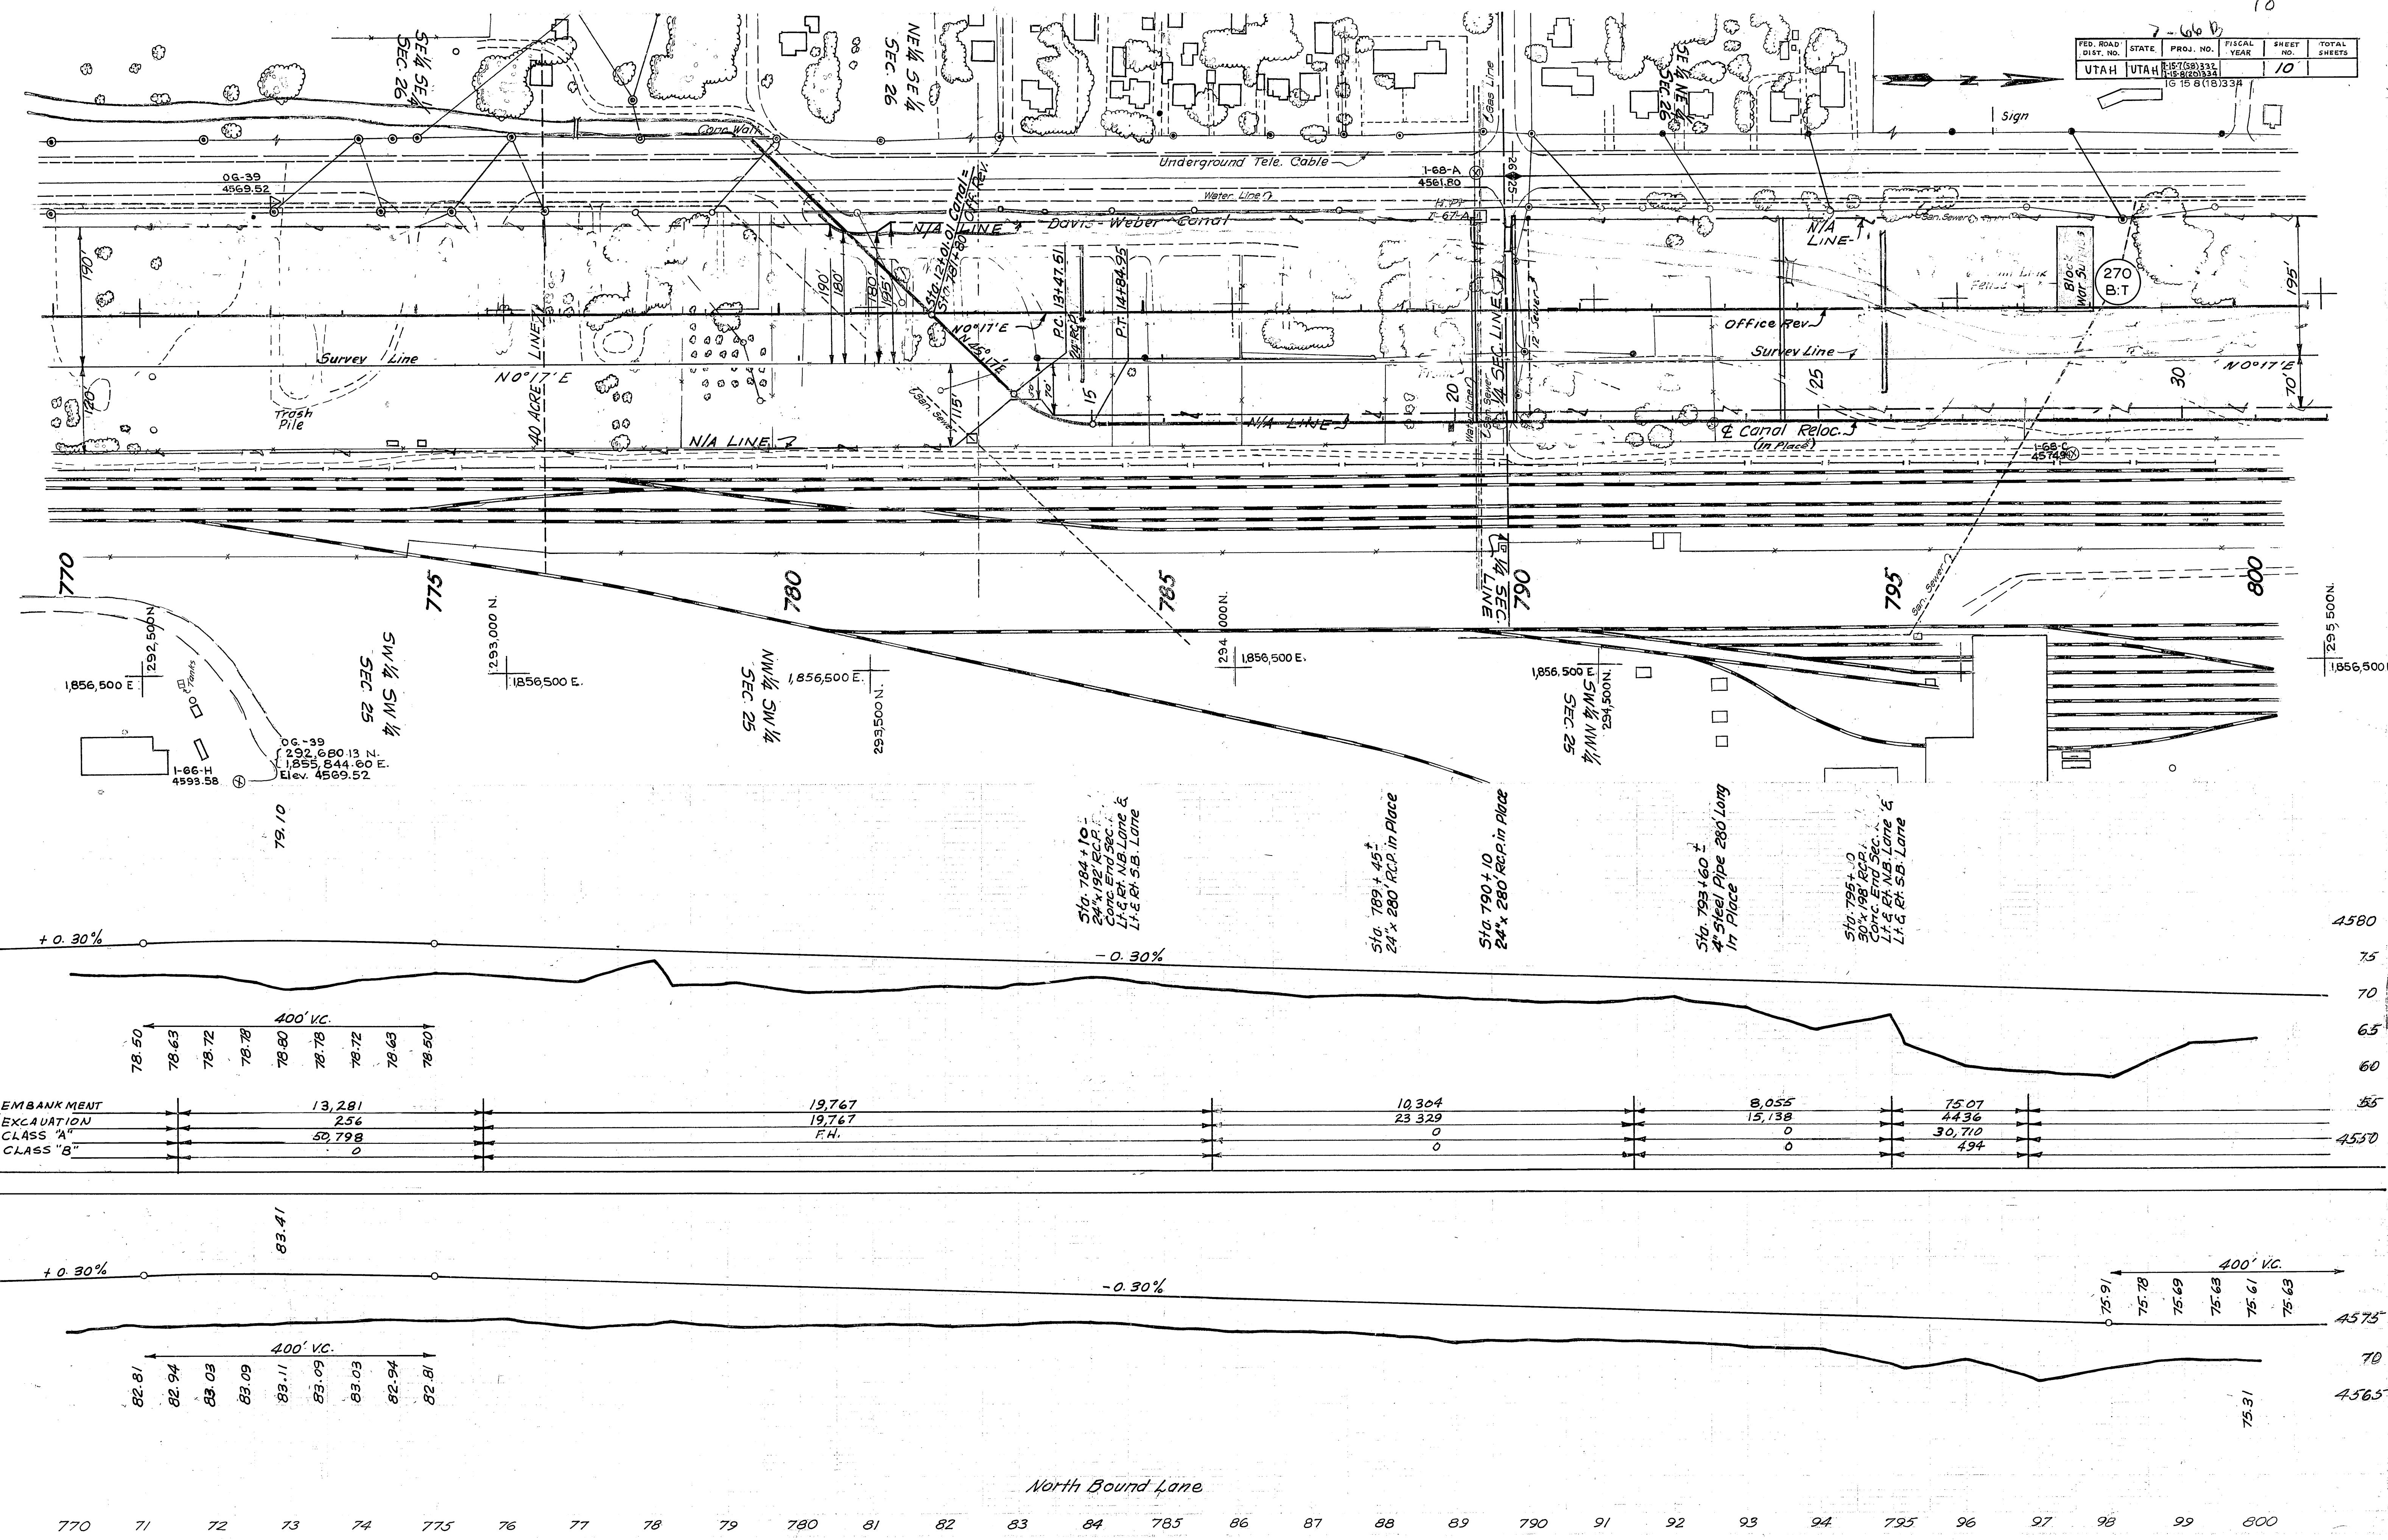

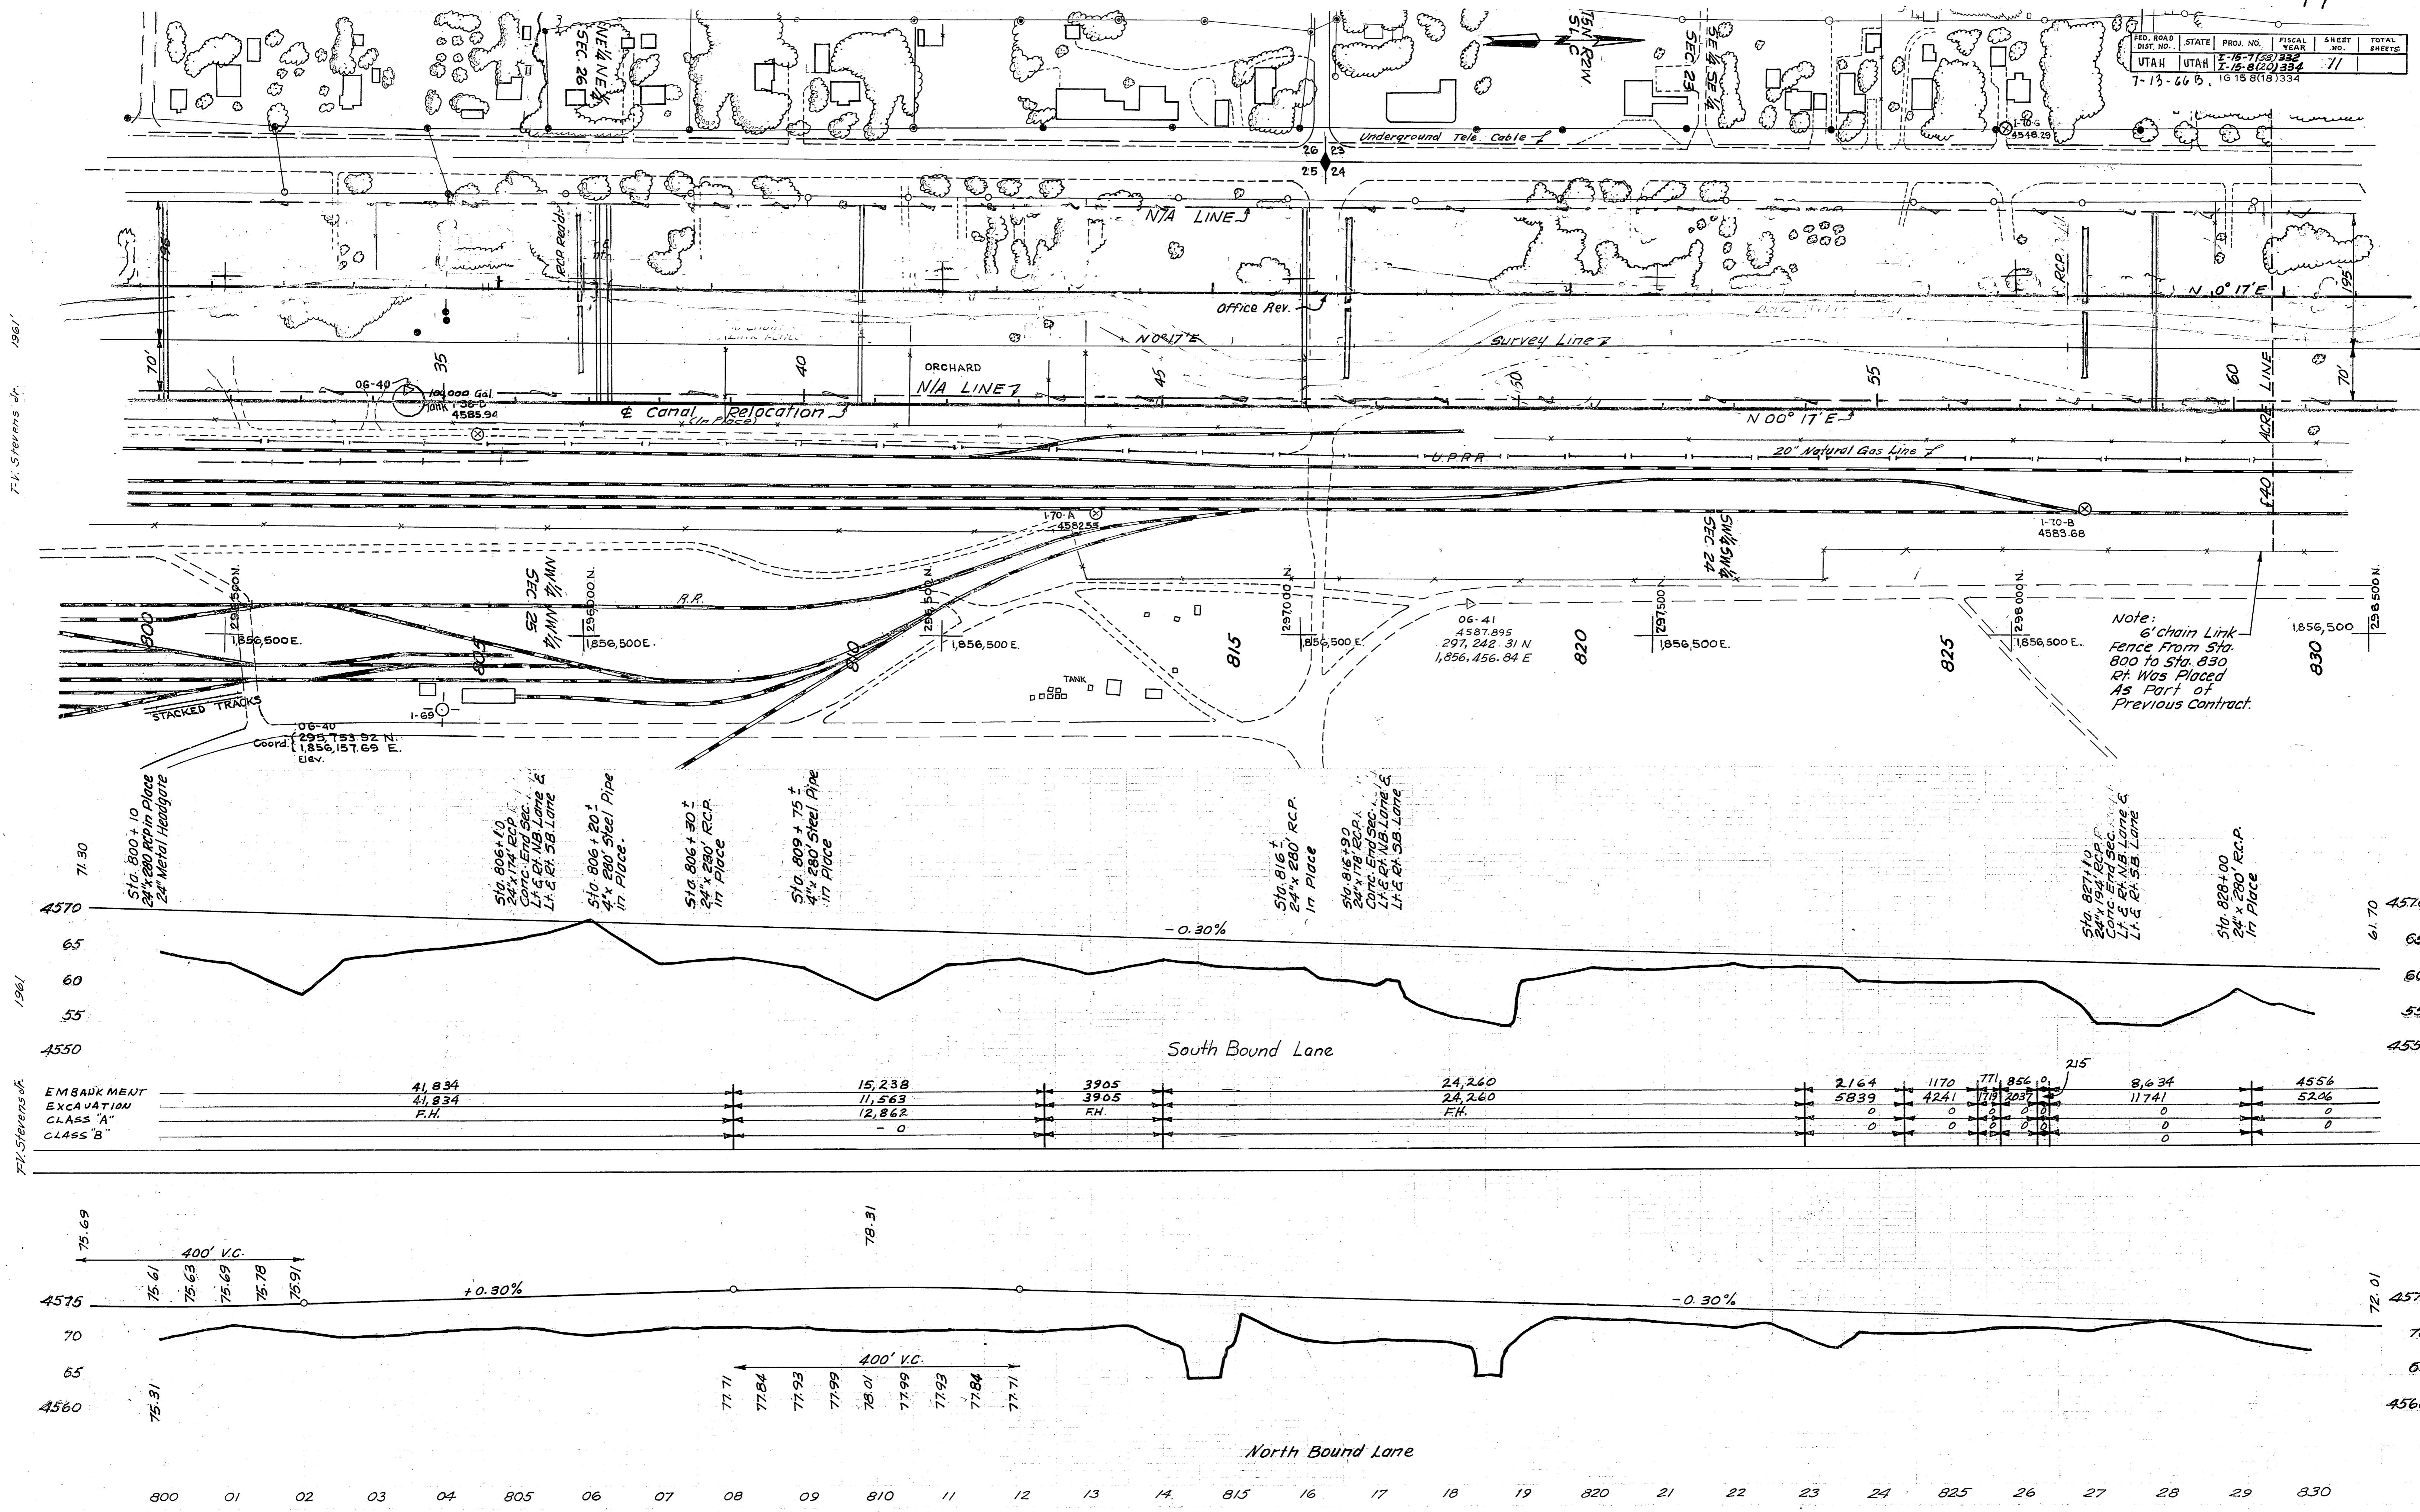


STATE	PROJECT NO.	SHEET NO.	TOTAL
I-15-7(58)	332		
I-15-8(20)	334		
UTAH	I-15-8(18)	334	13

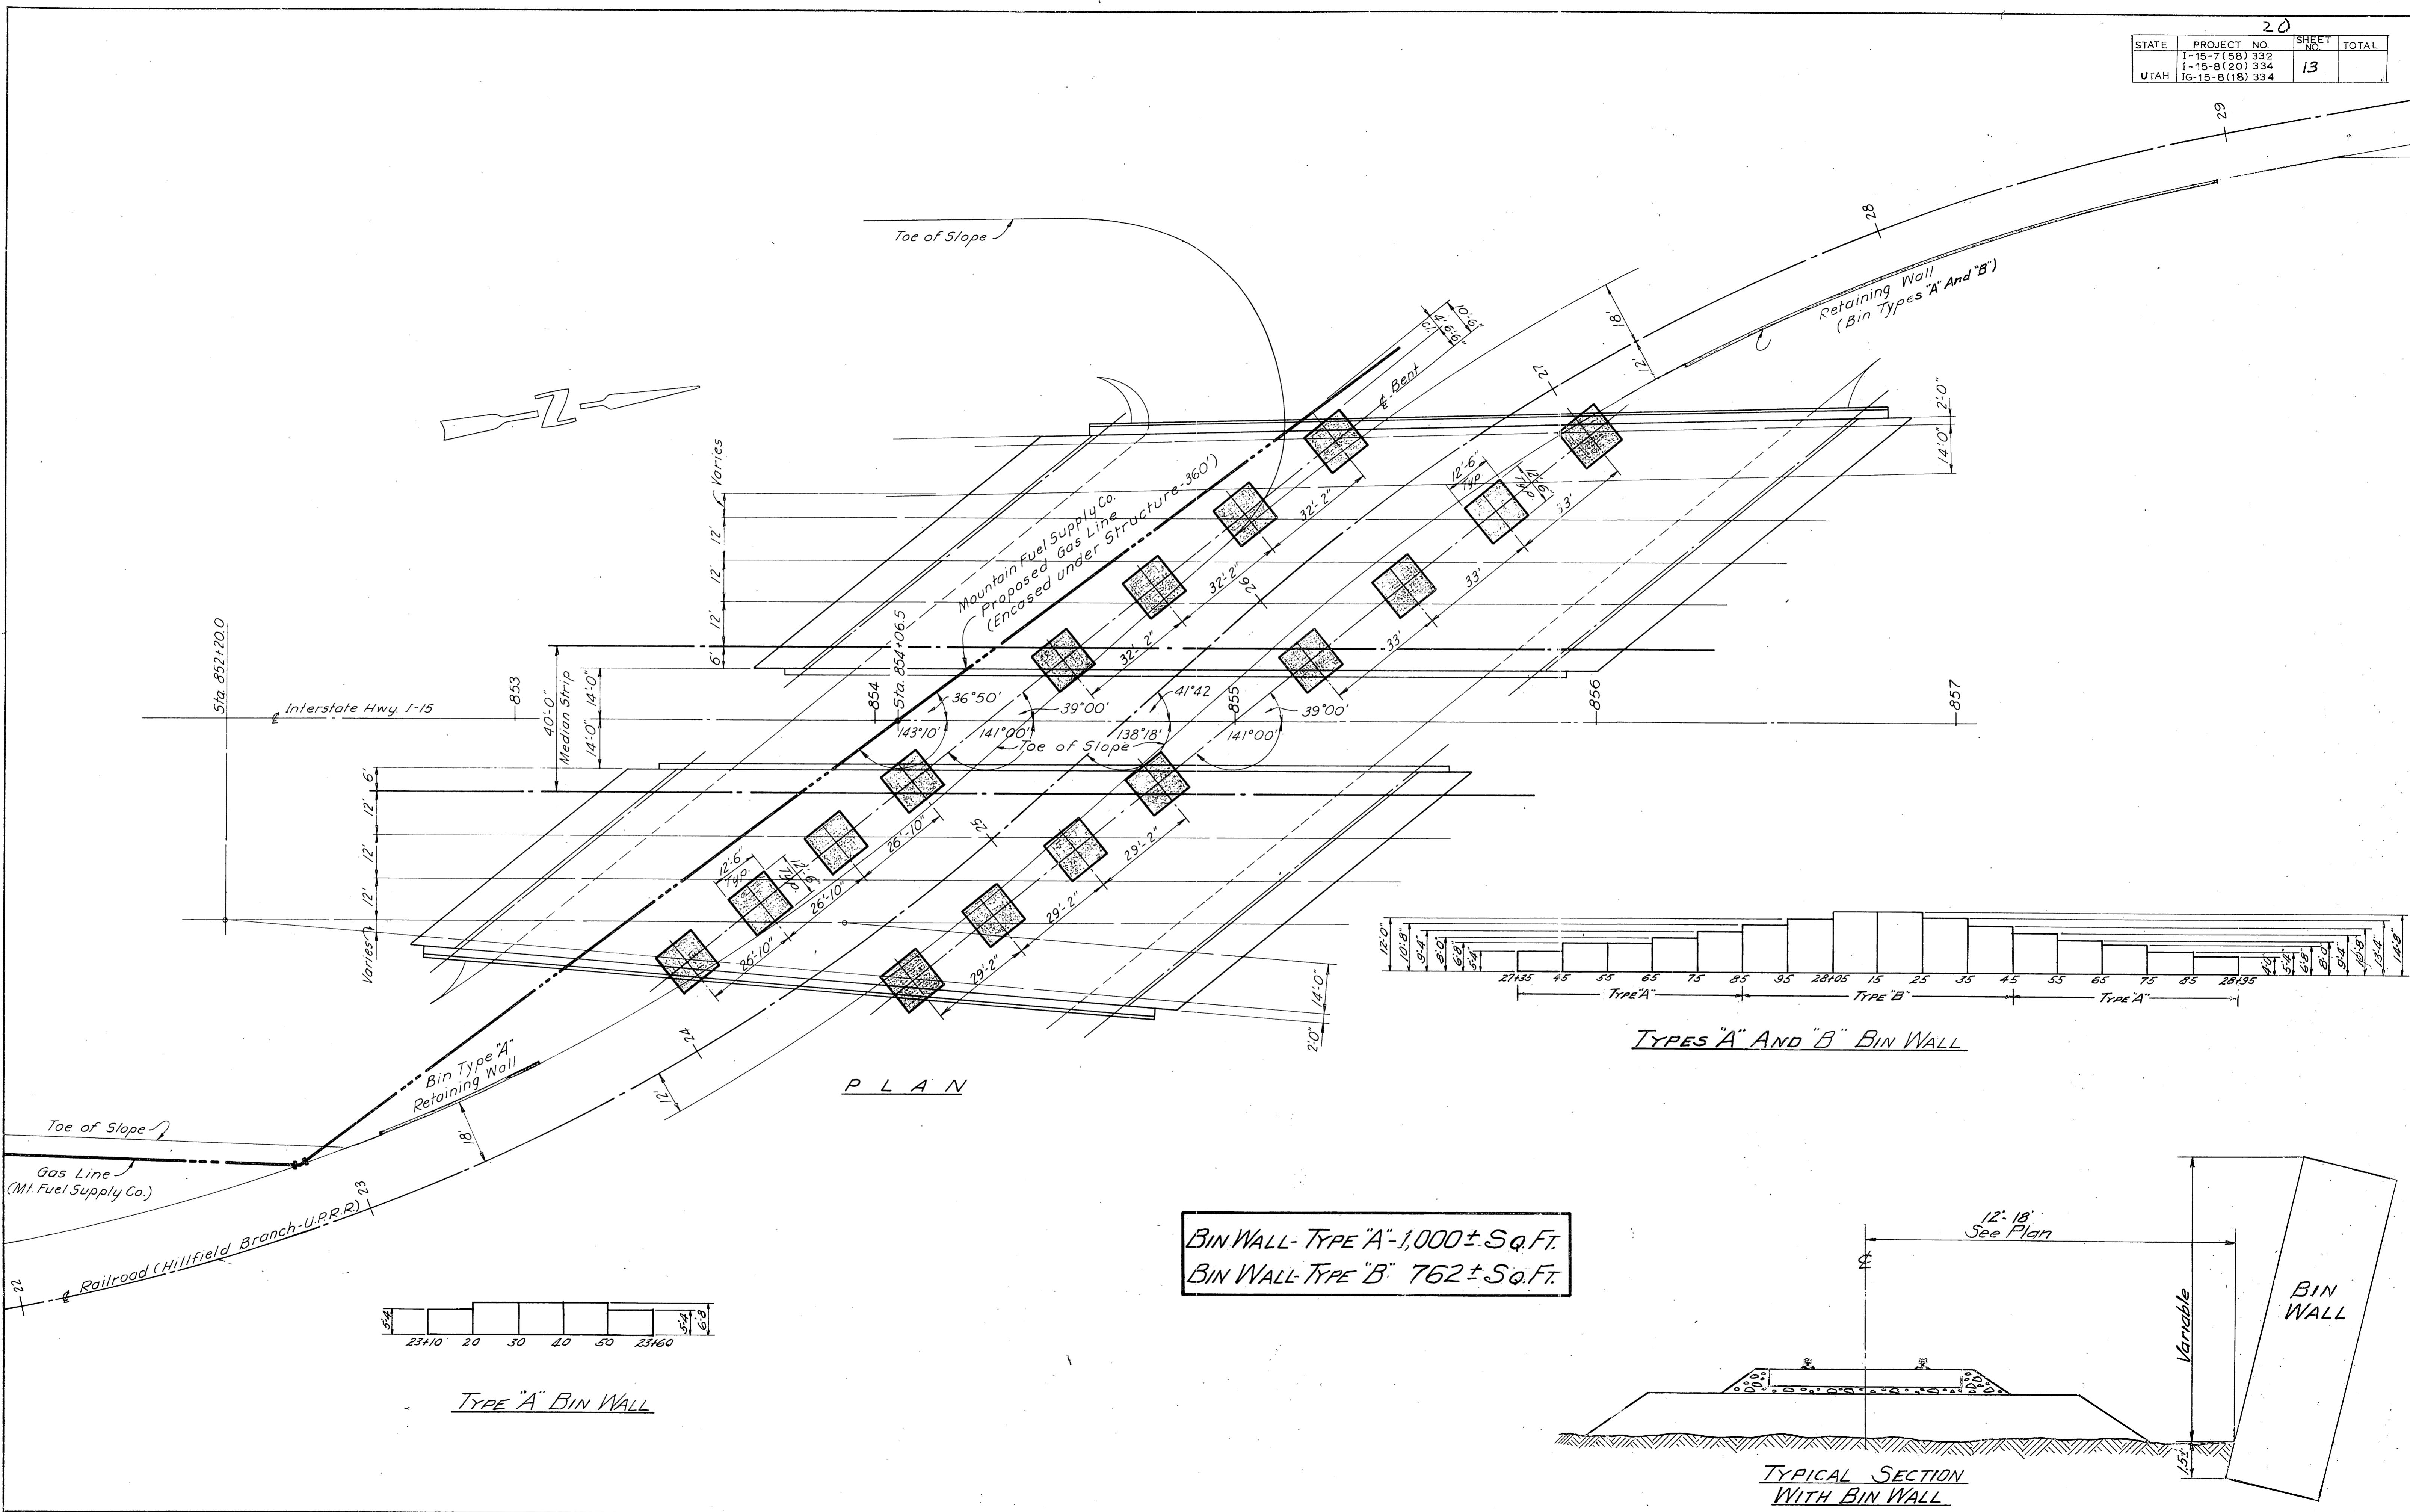

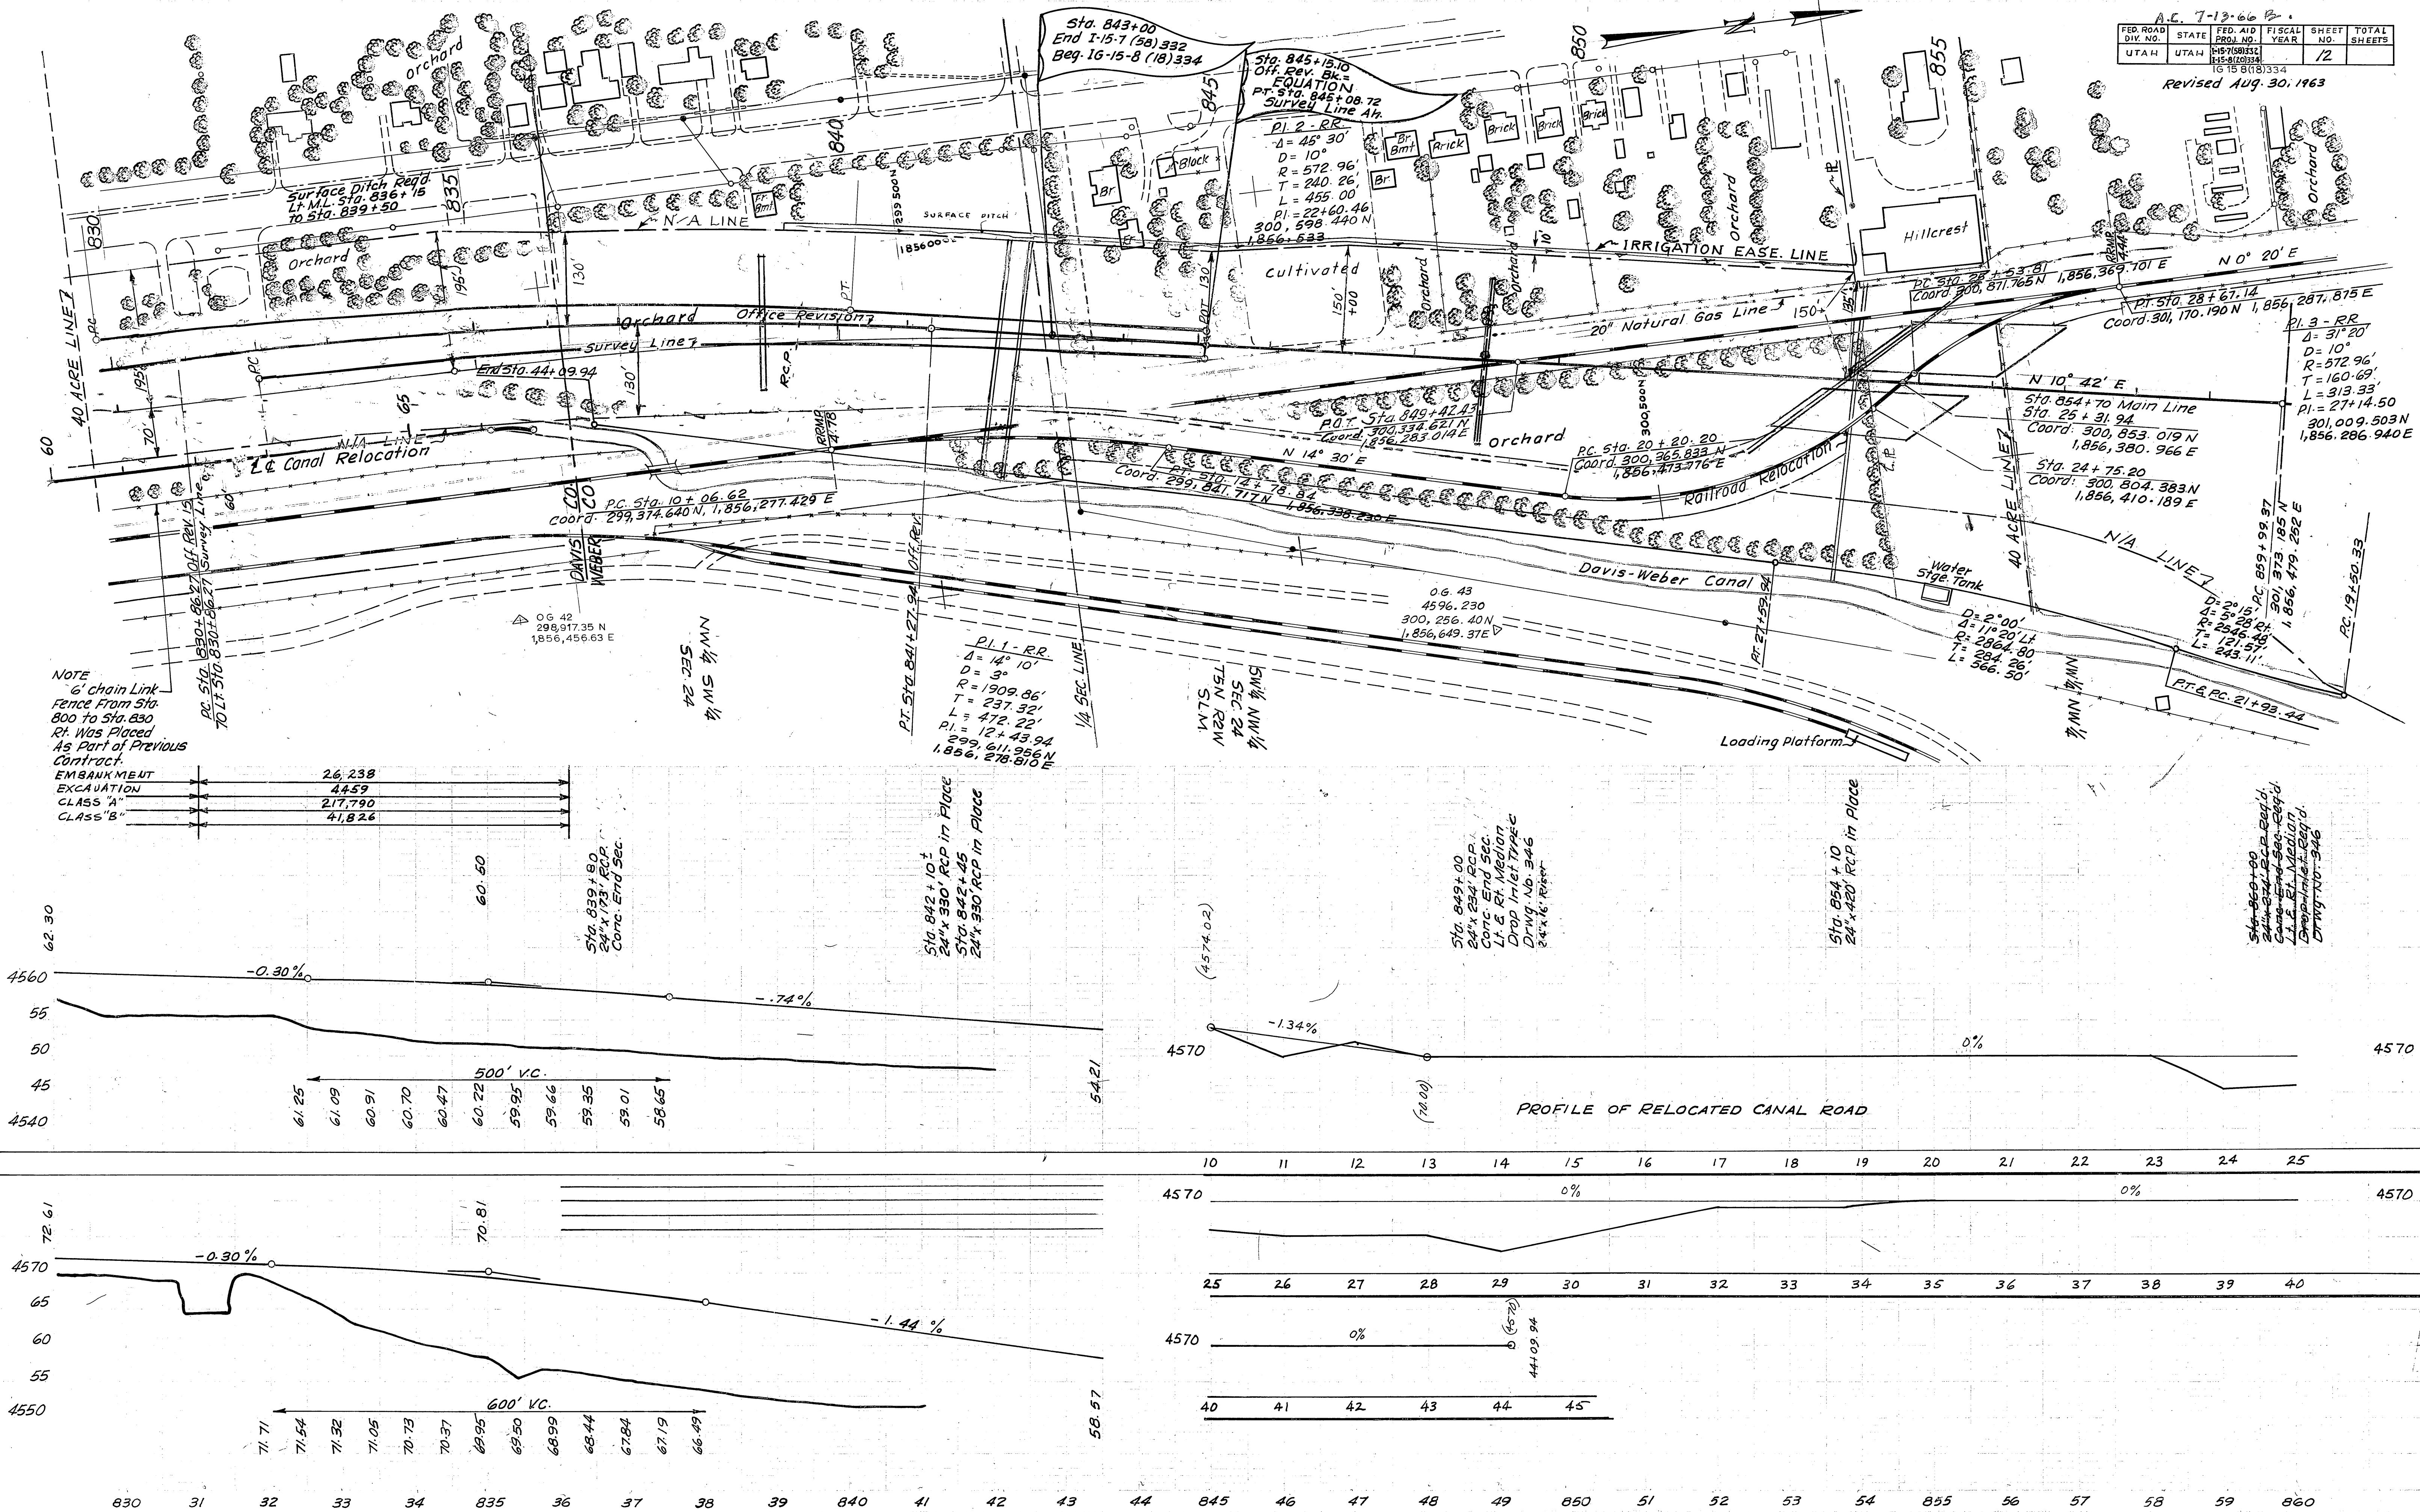





FED. ROAD DIST. NO.	STATE	PROJ. NO.	FISCAL YEAR	SHEET NO.	TOTAL SHEETS
UTAH	UTAH	I-15-7(58)332 I-15-8(20)334		14	14

IG 15 8(18)334

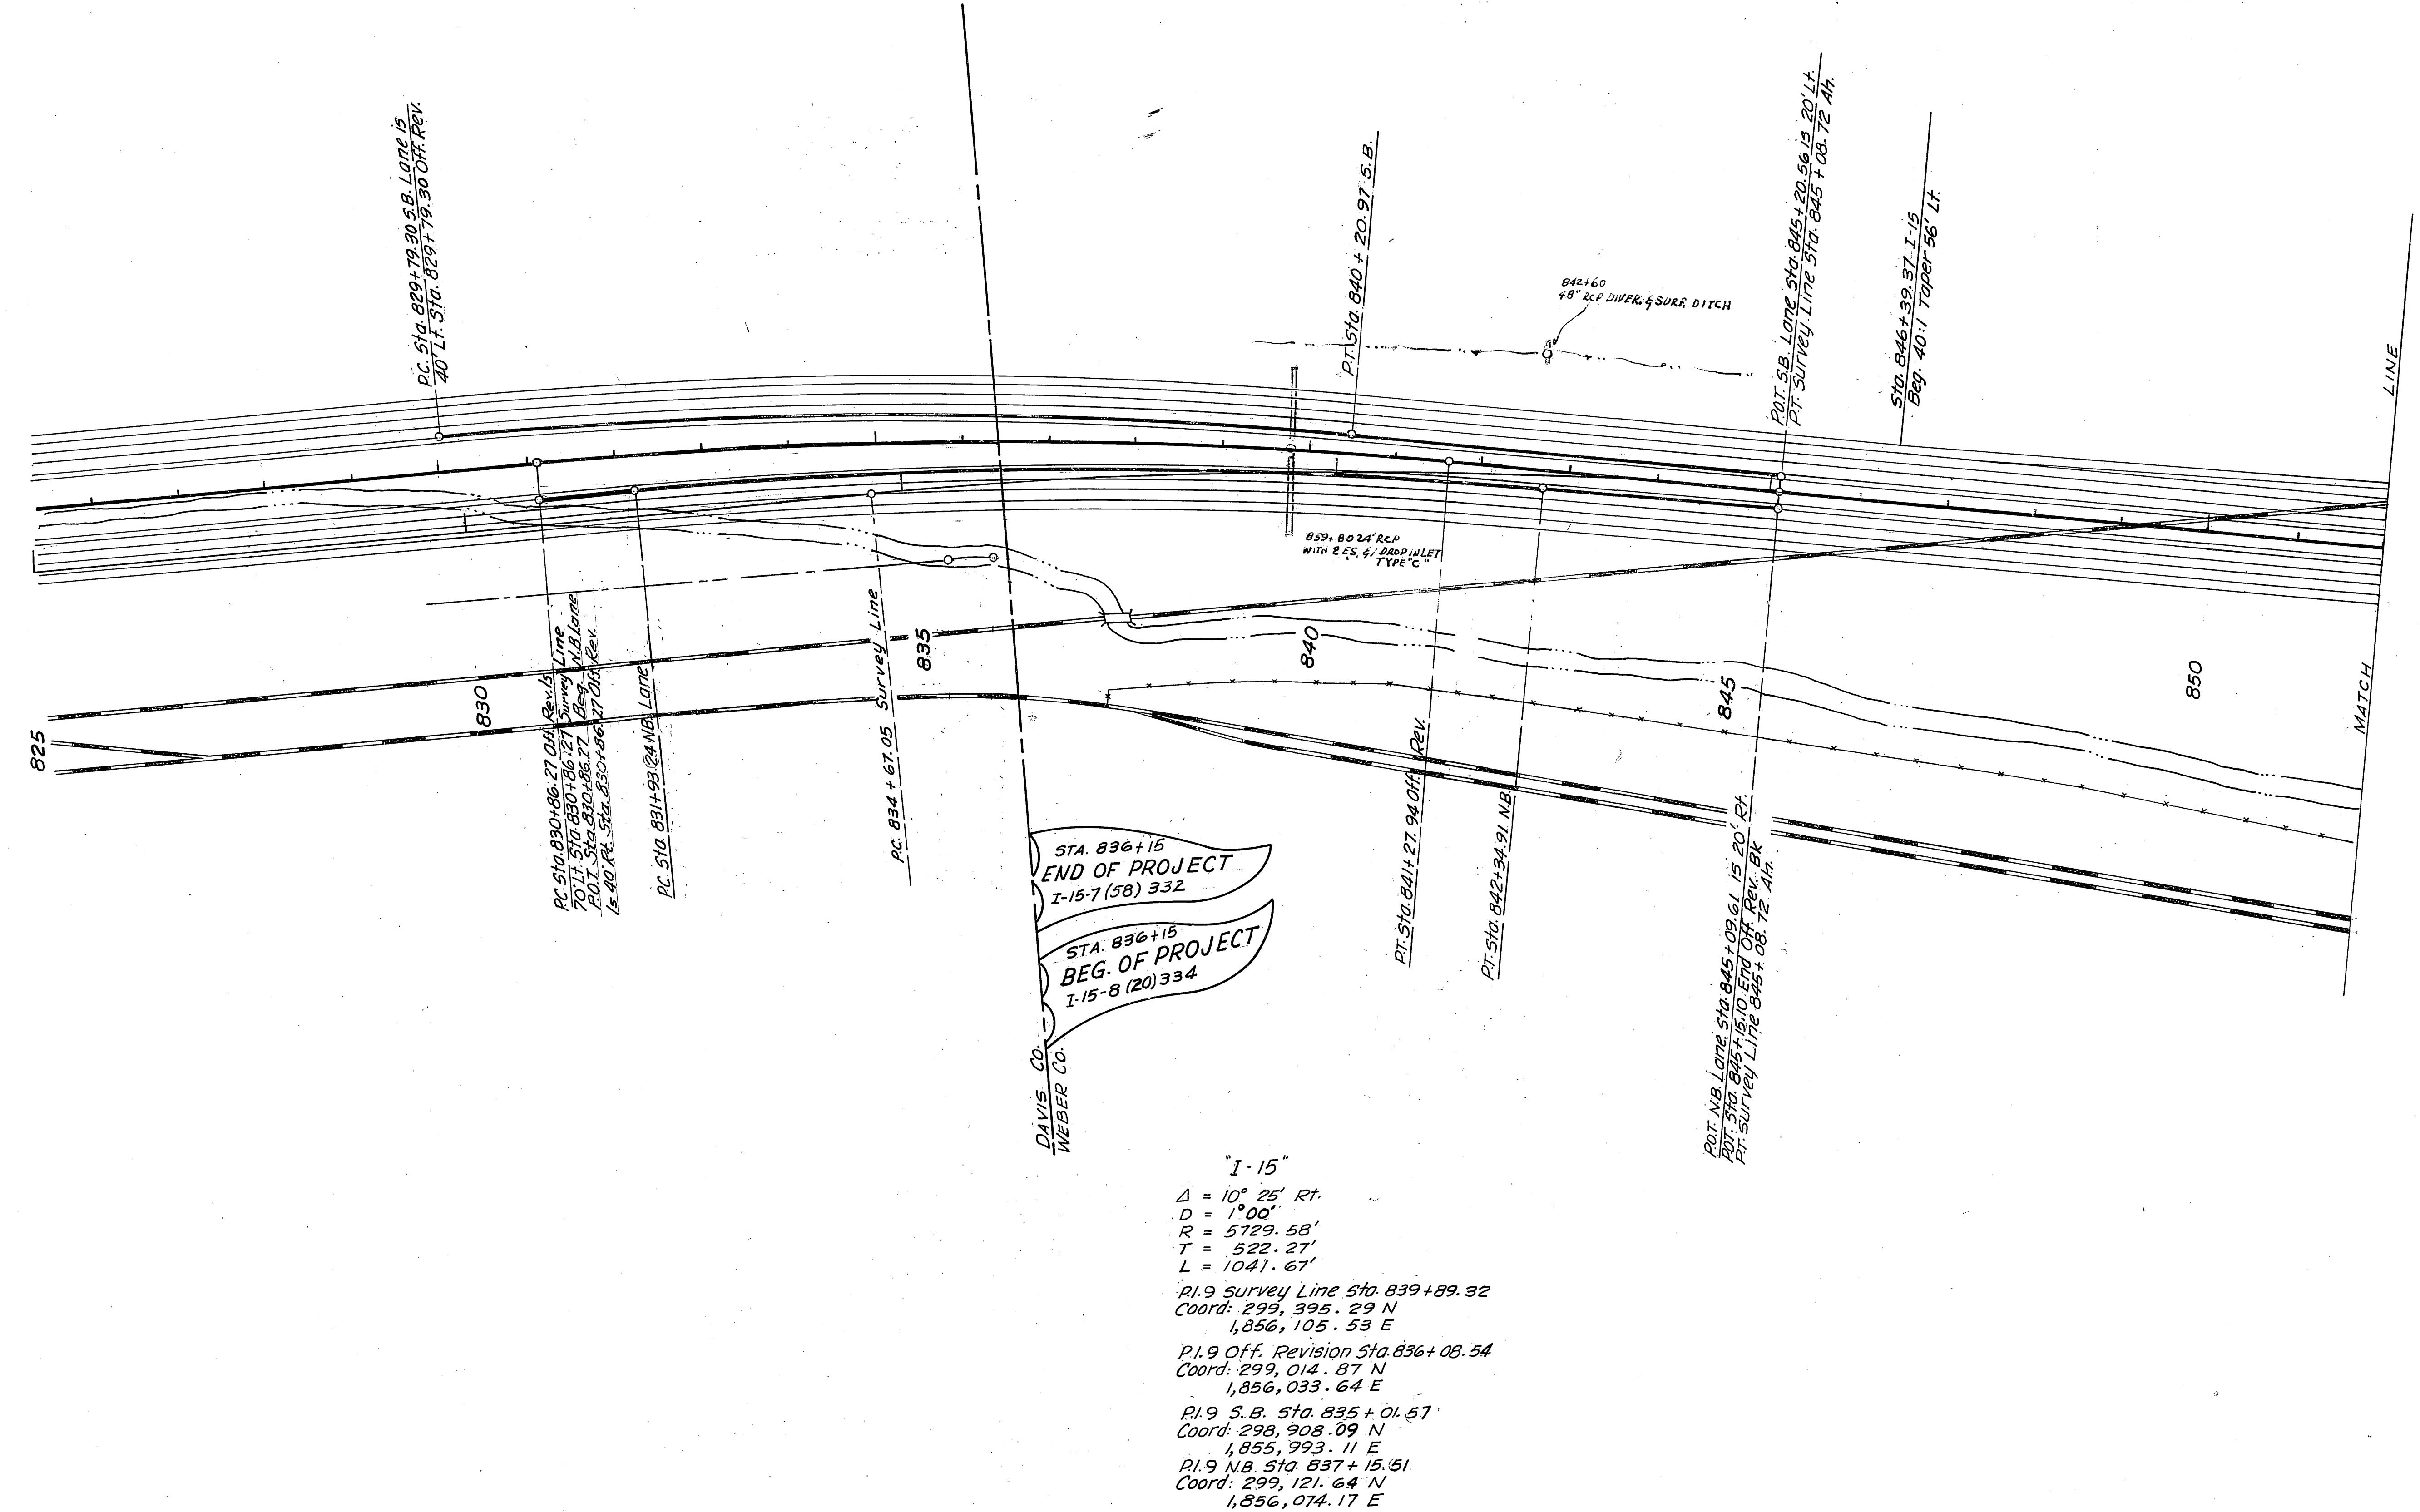



REVISIONS			
DATE	BY	DATE	BY

Fig T-66-2
 I-15-7 (69) 332
 I-15-8 (20) 334
 IG 15 (18) 334
 REV 8-30-63

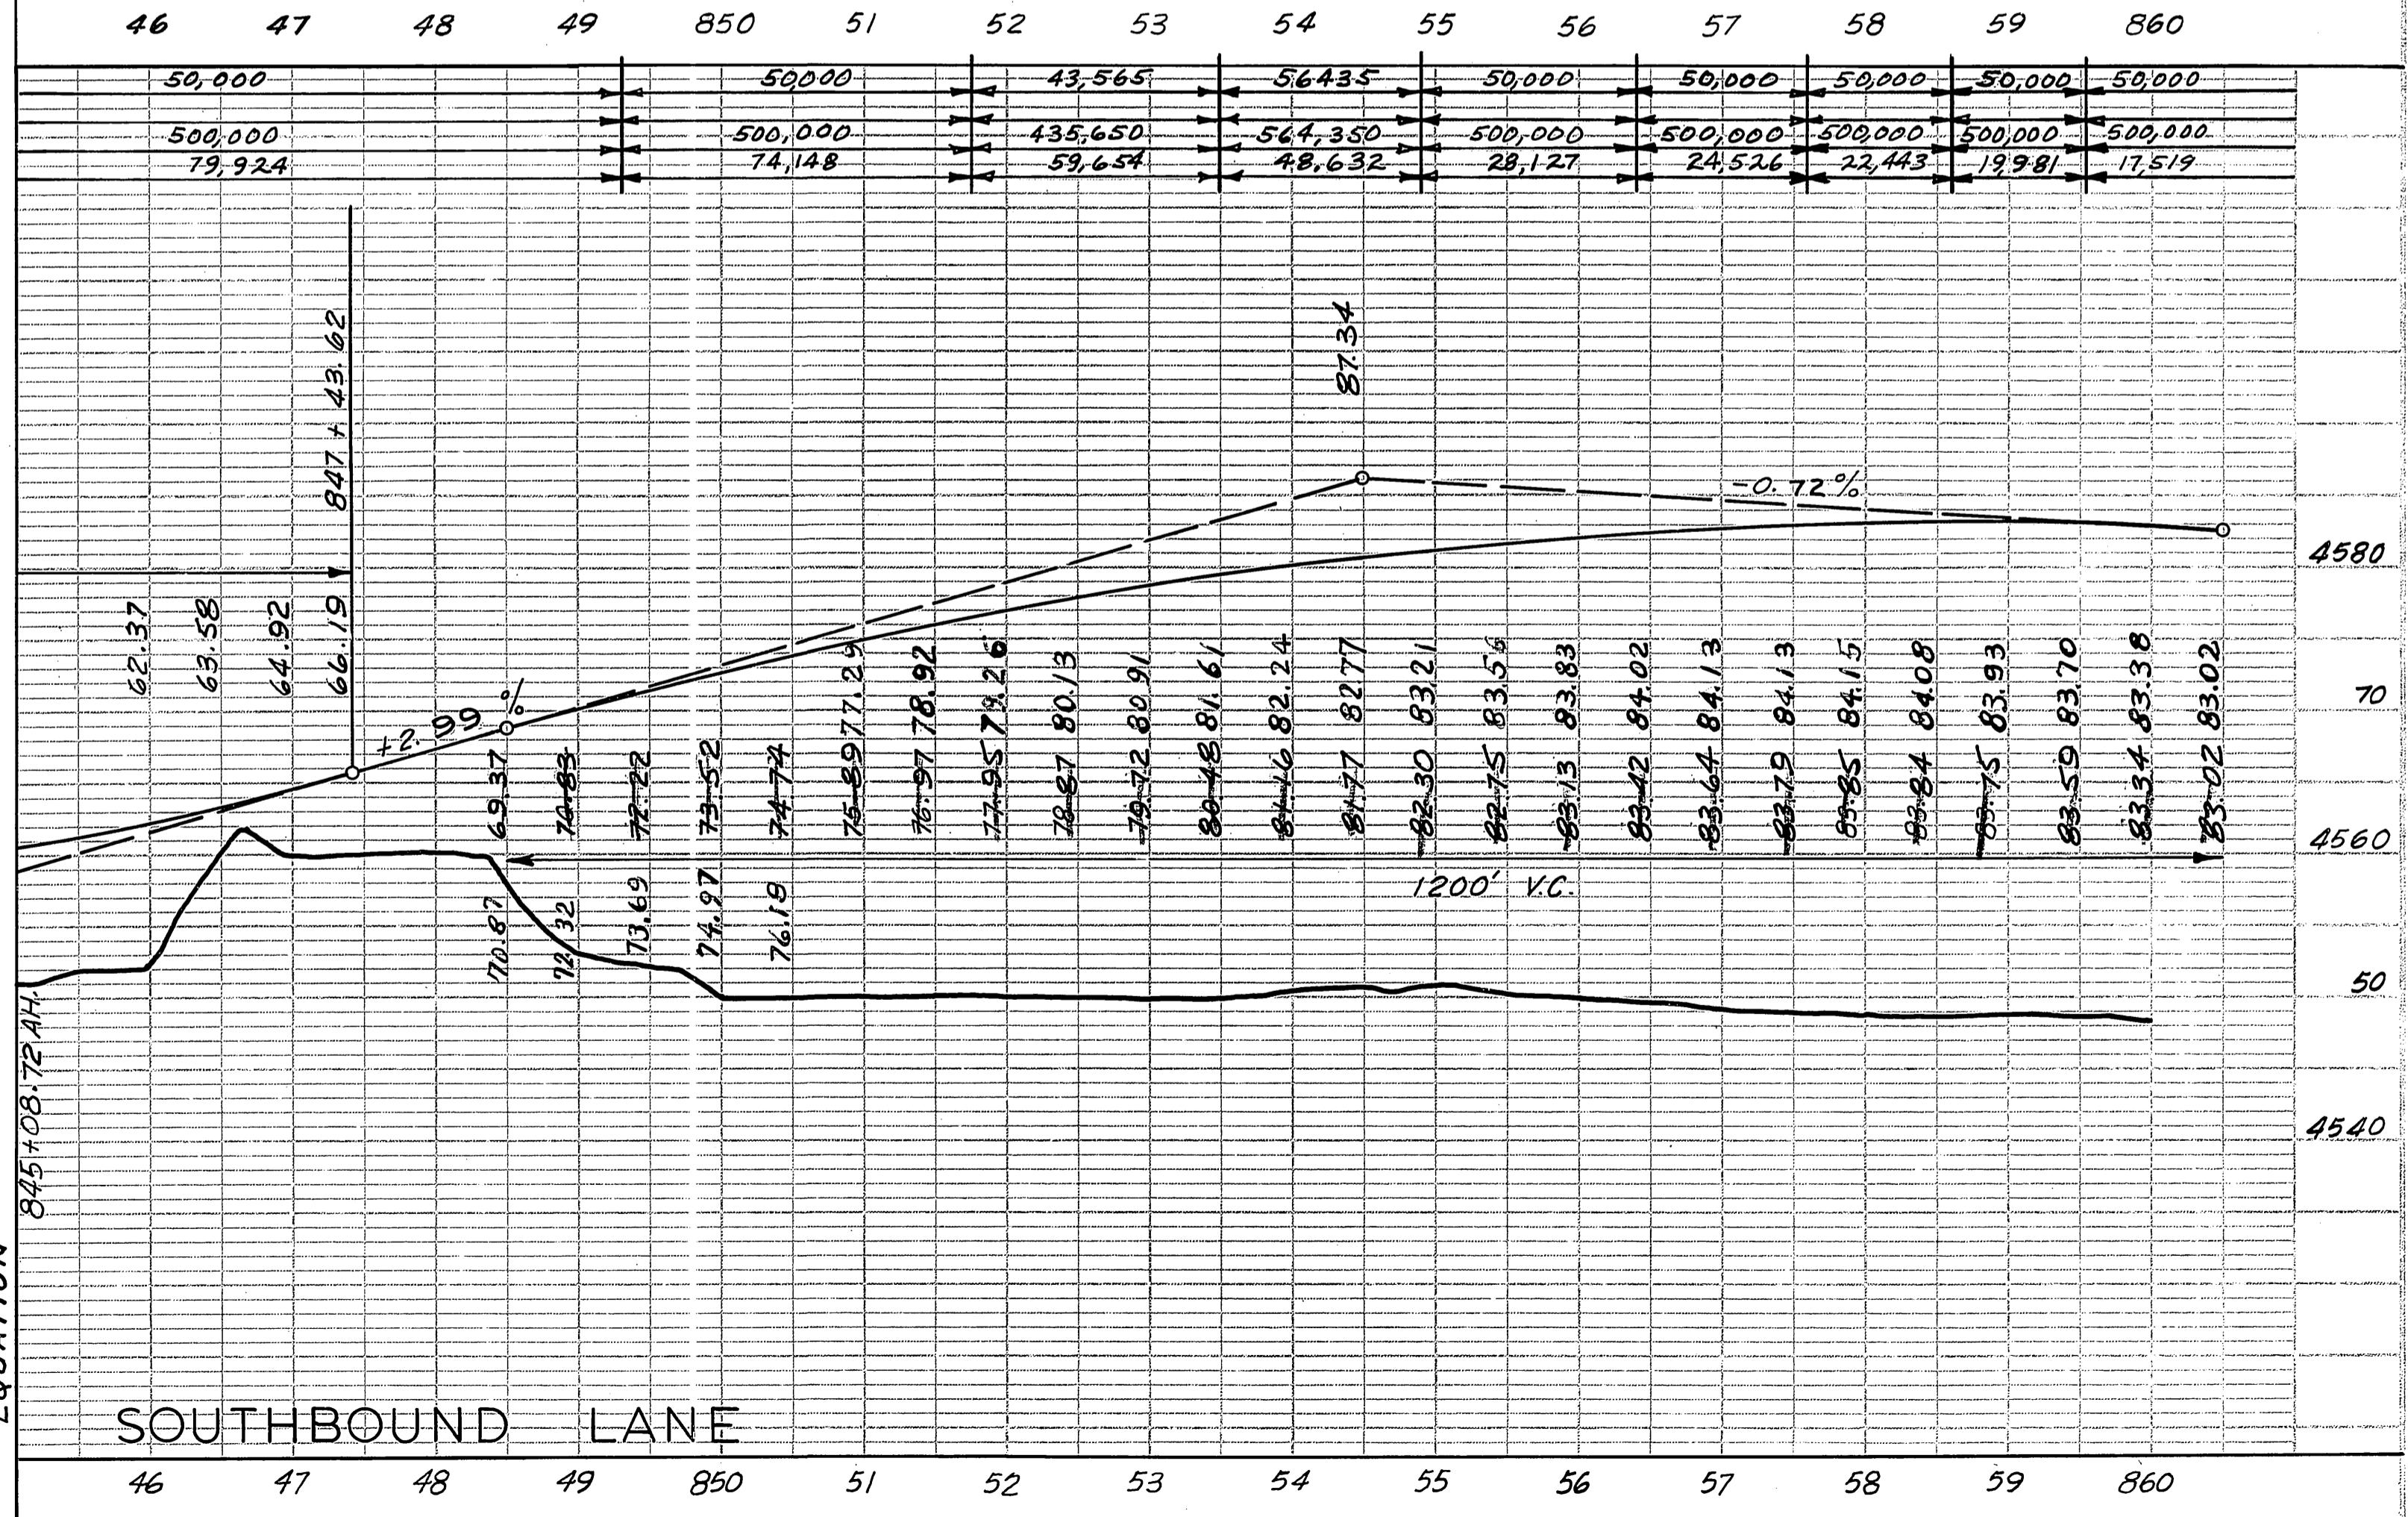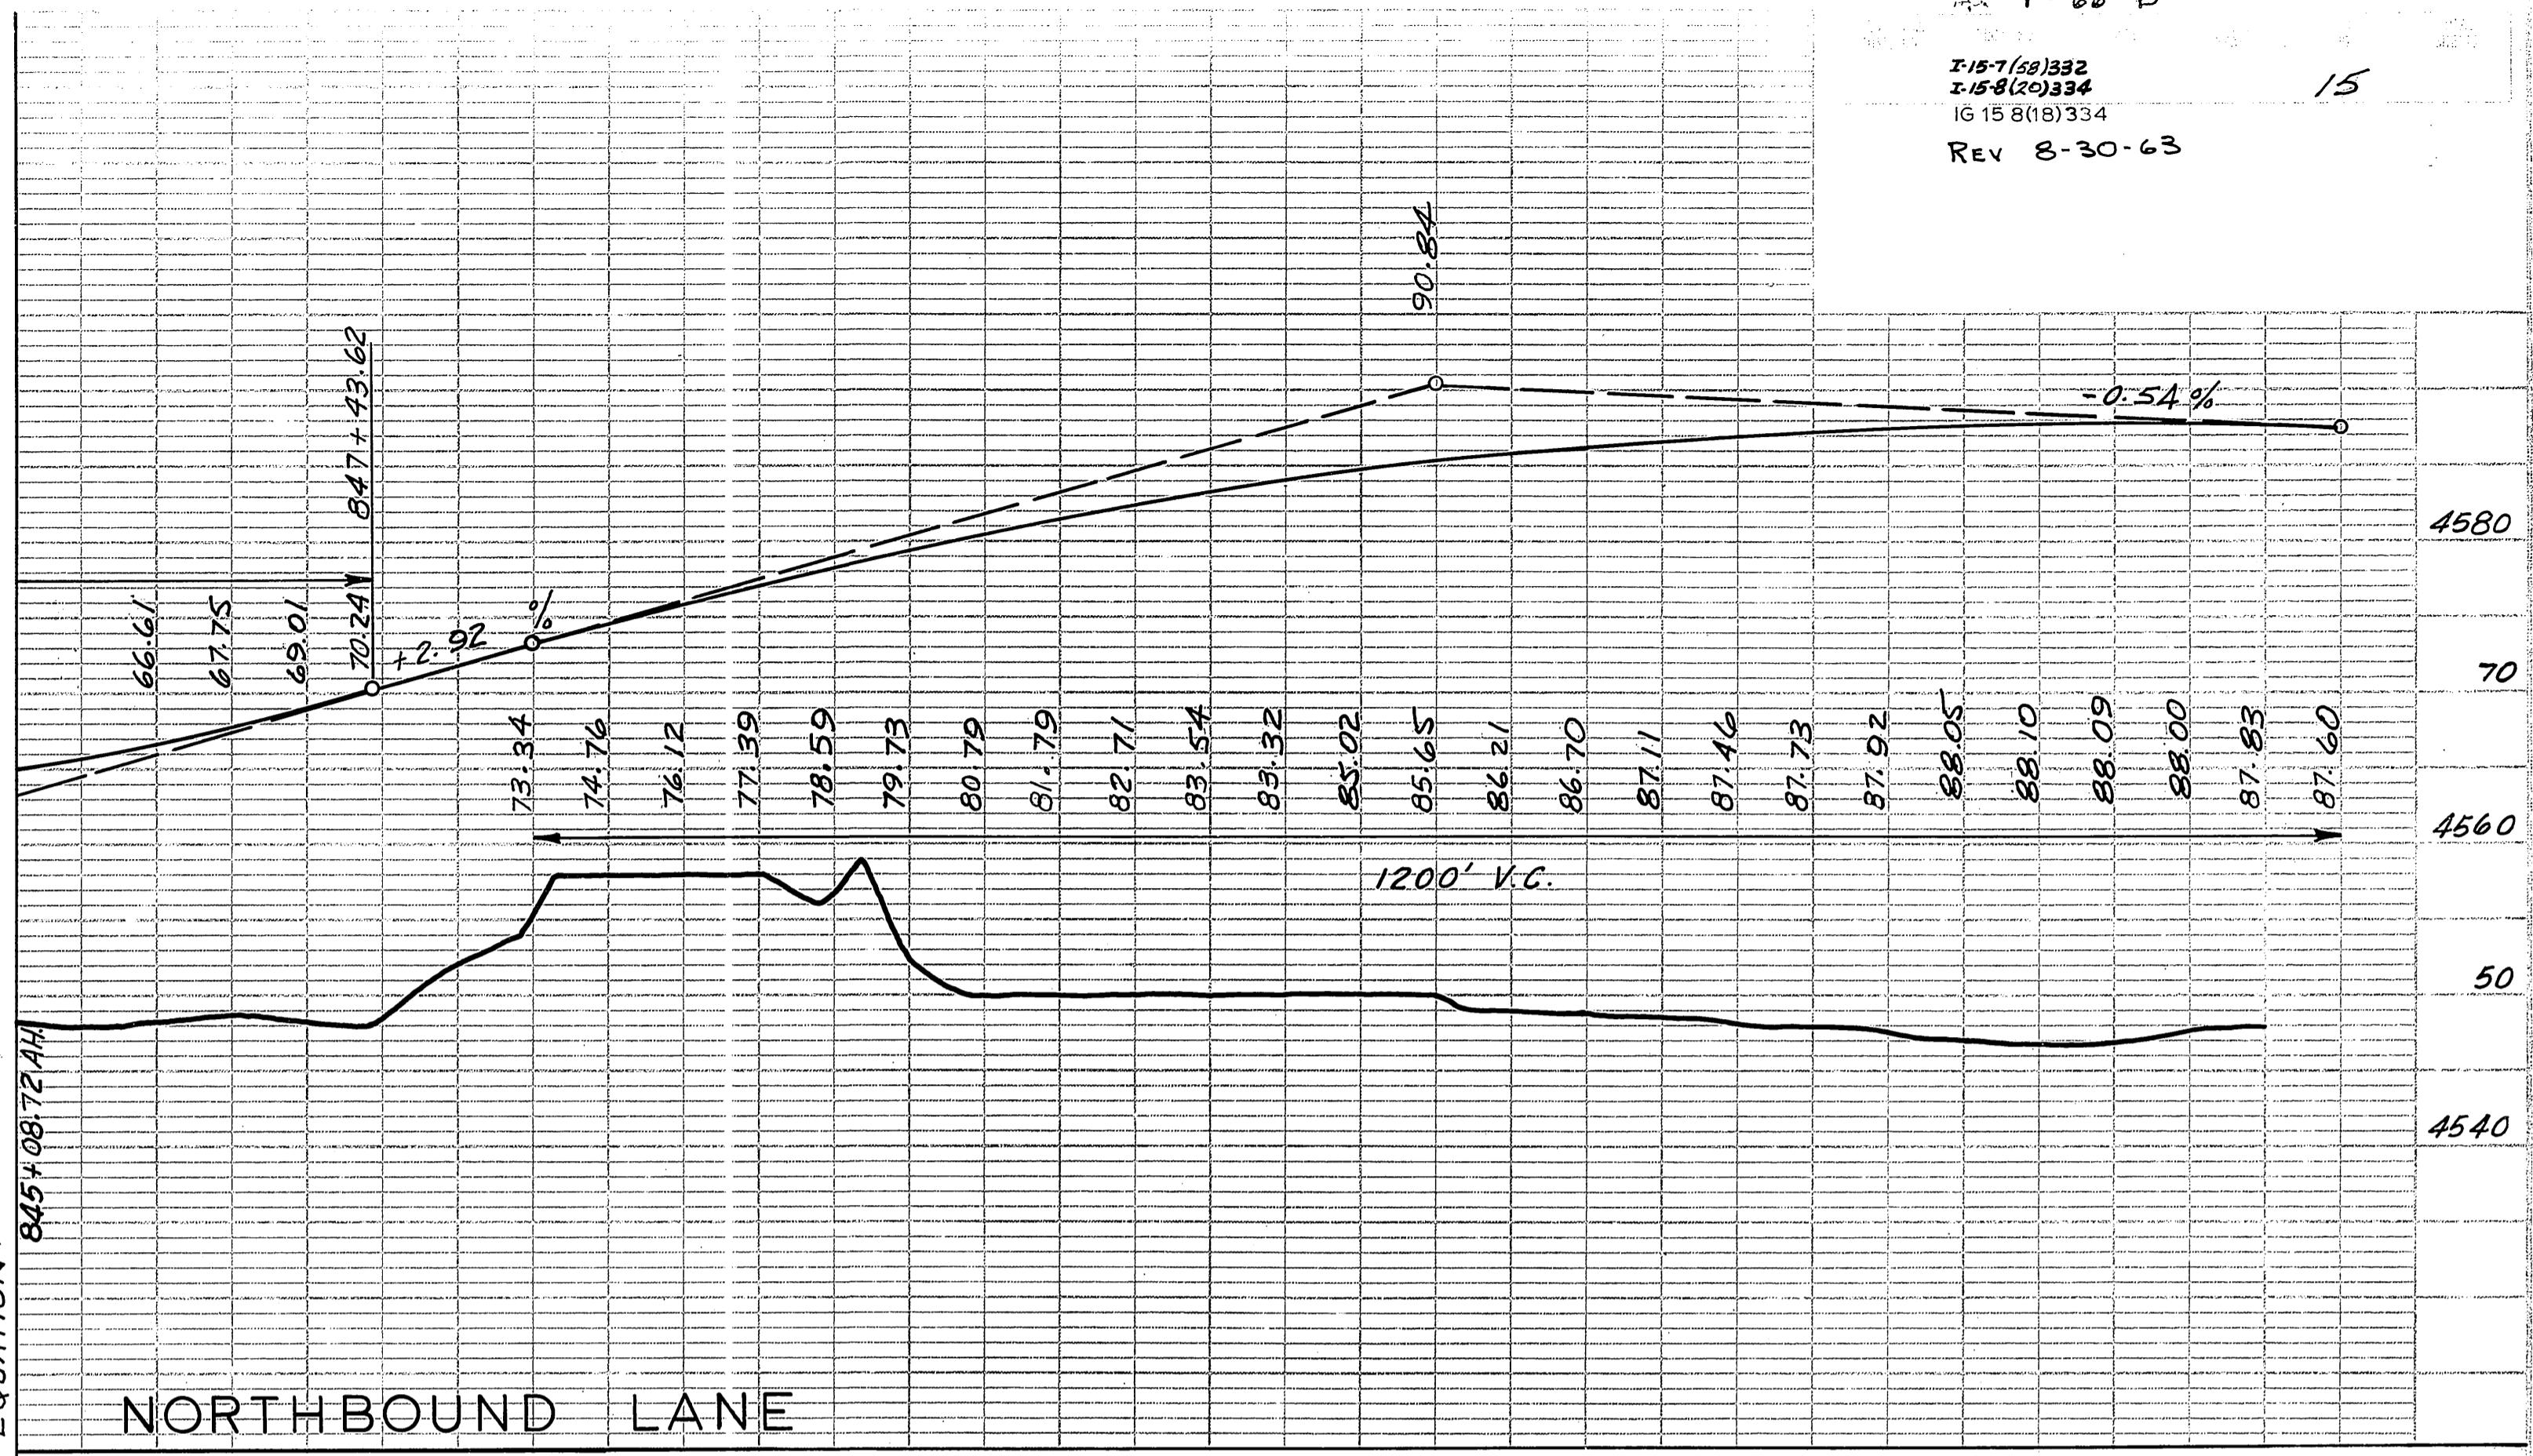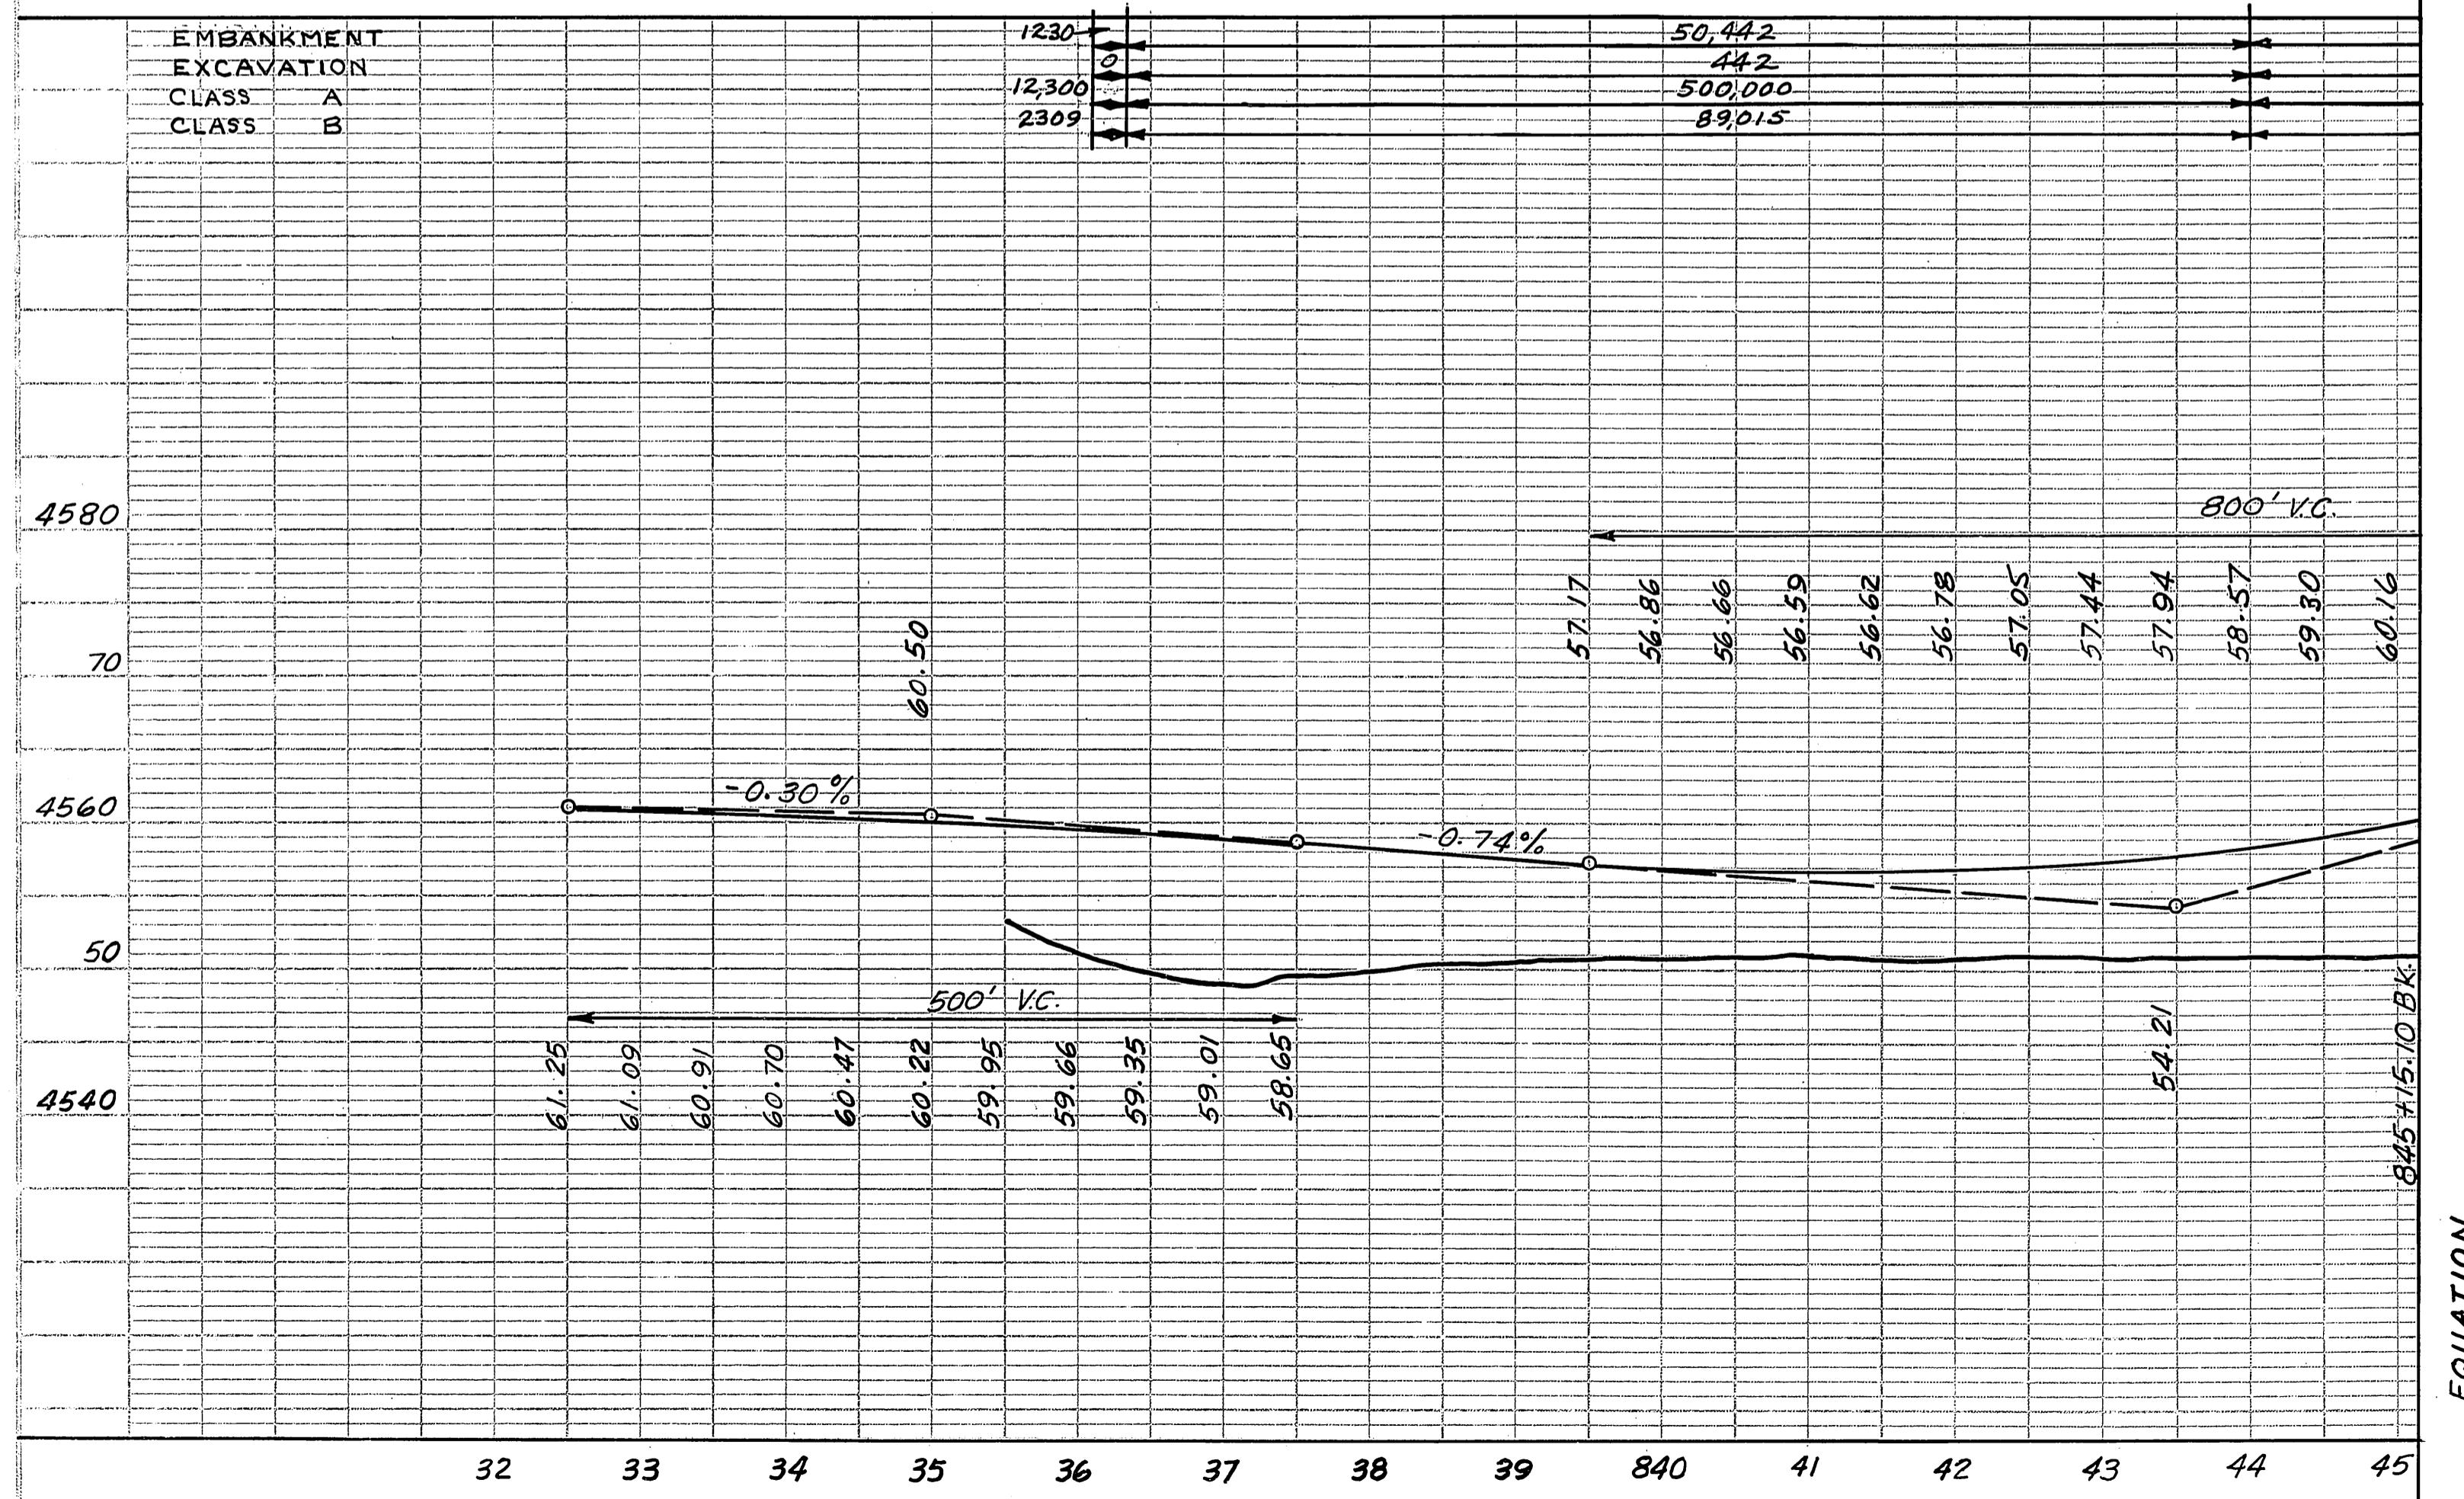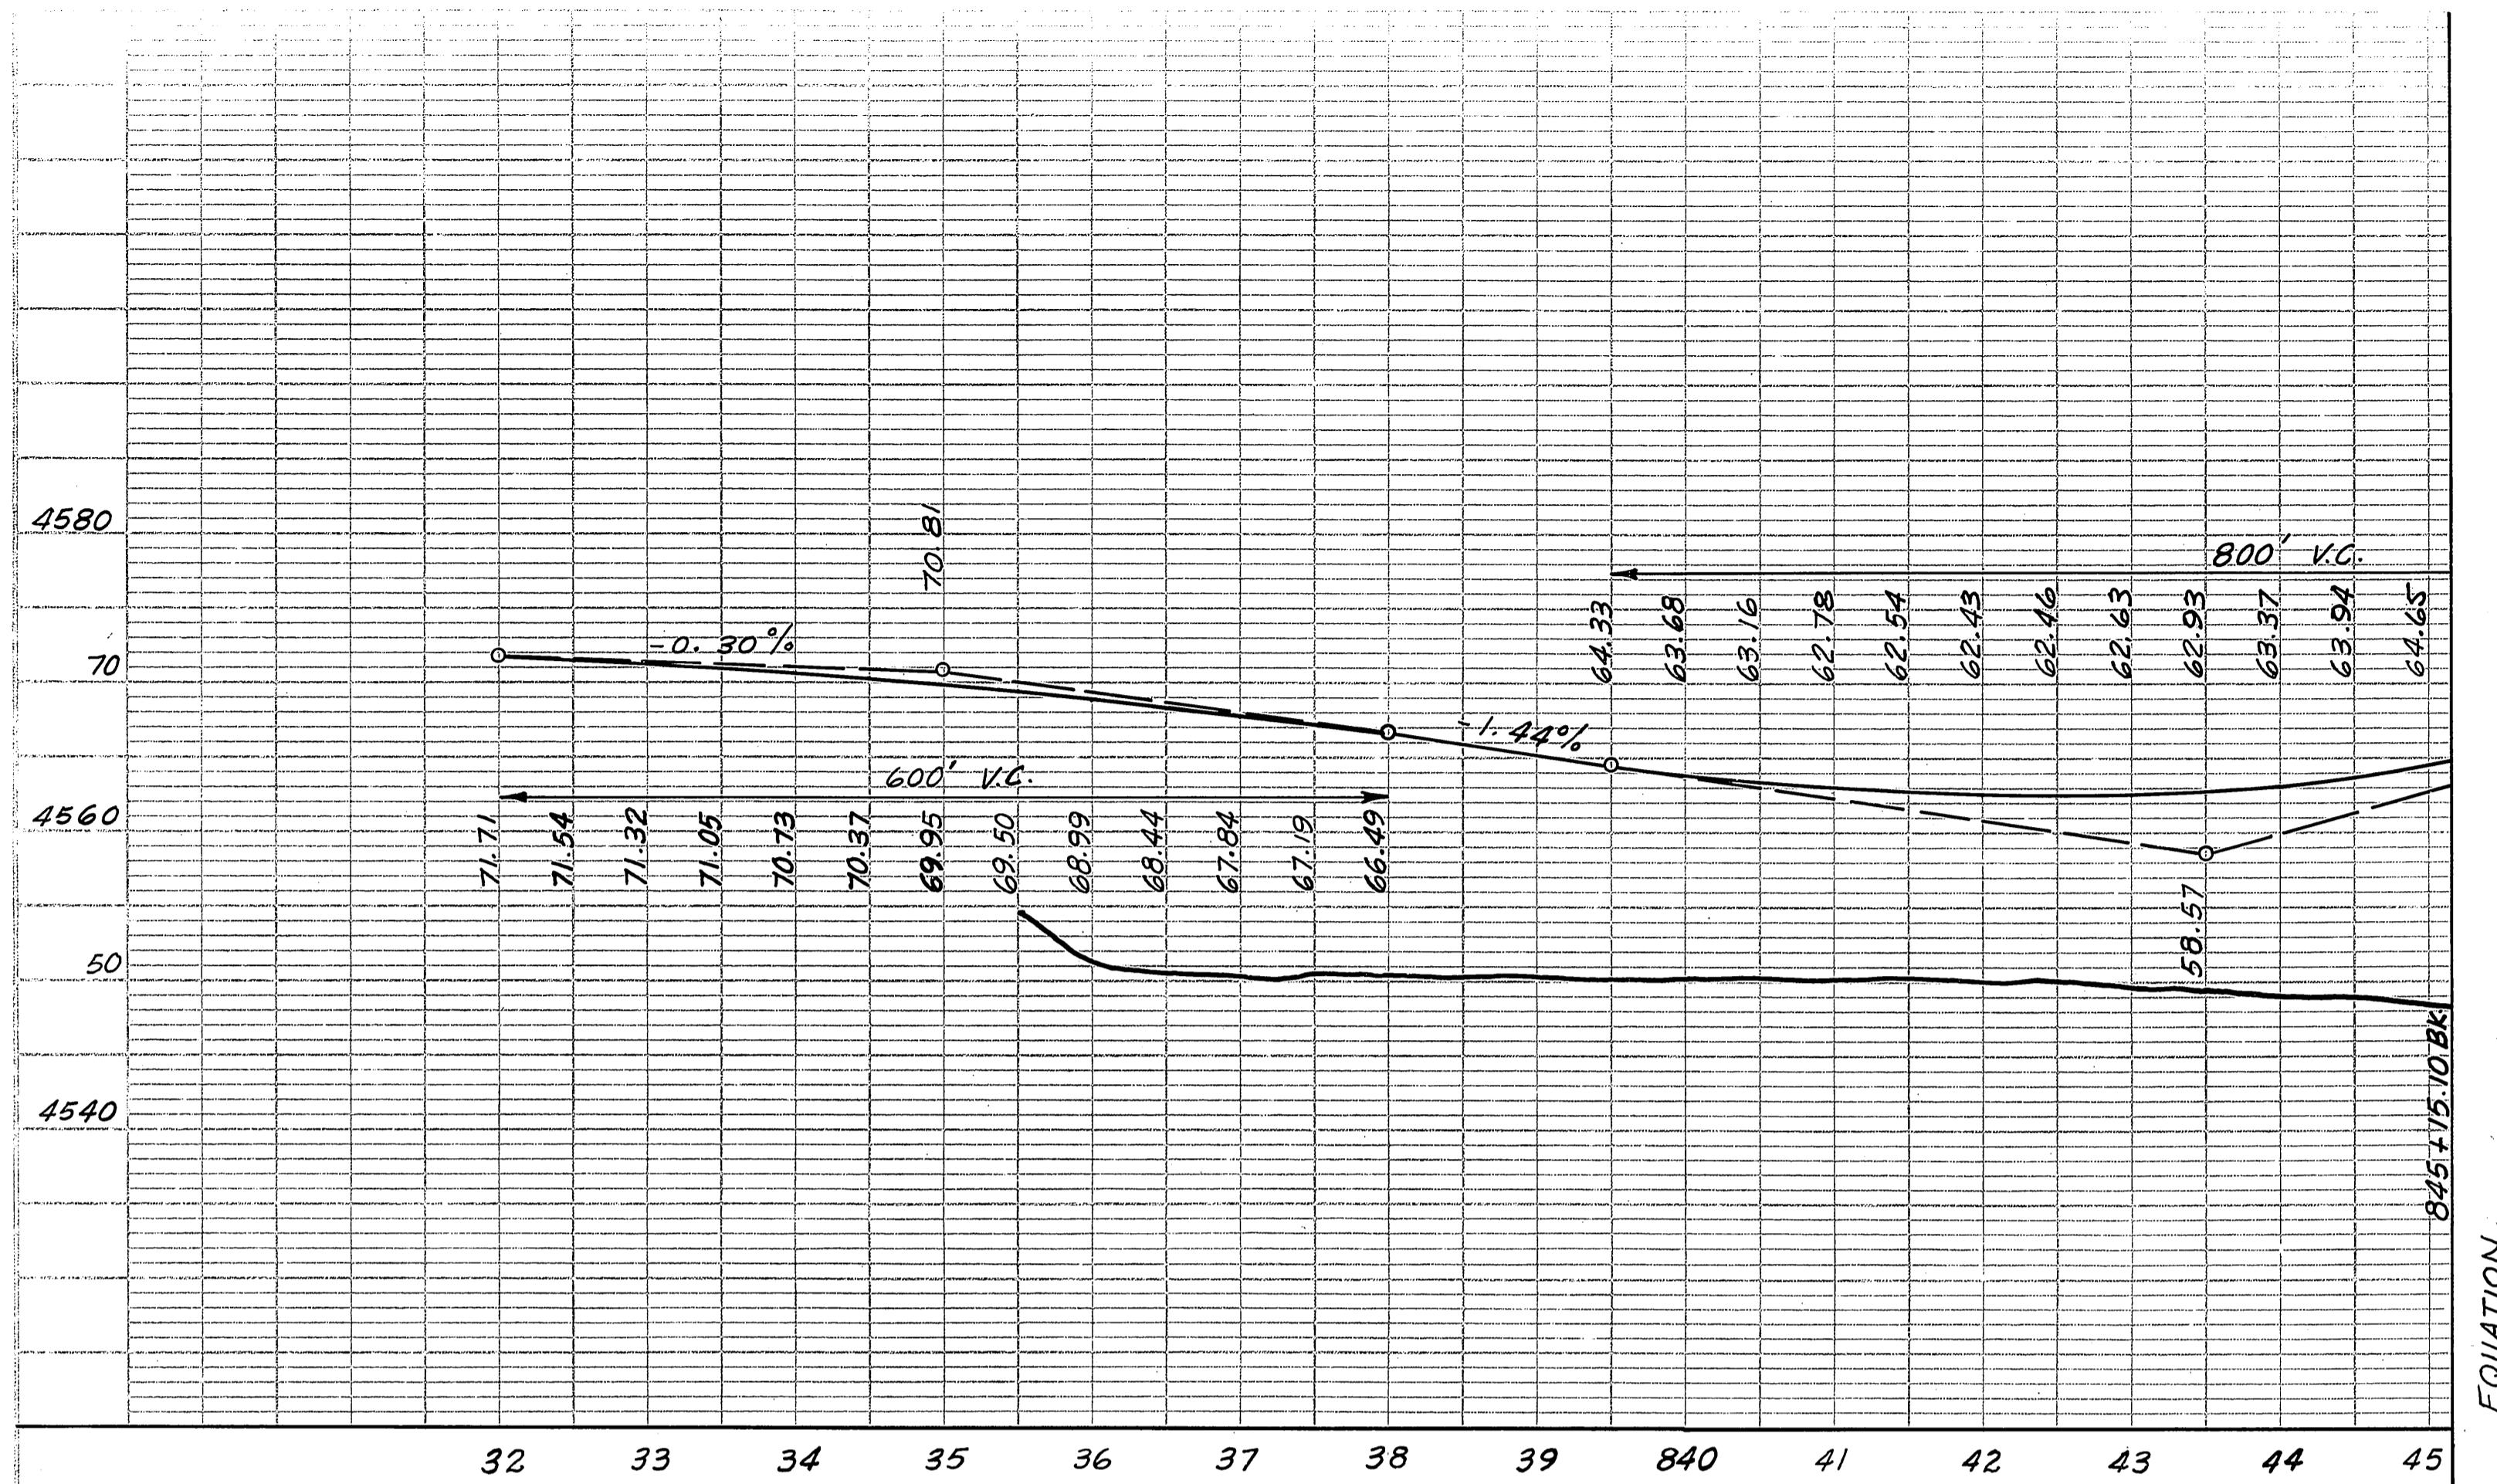


I-15-7(58)332
I-15-8(20)334
I-G-15-8(18)334

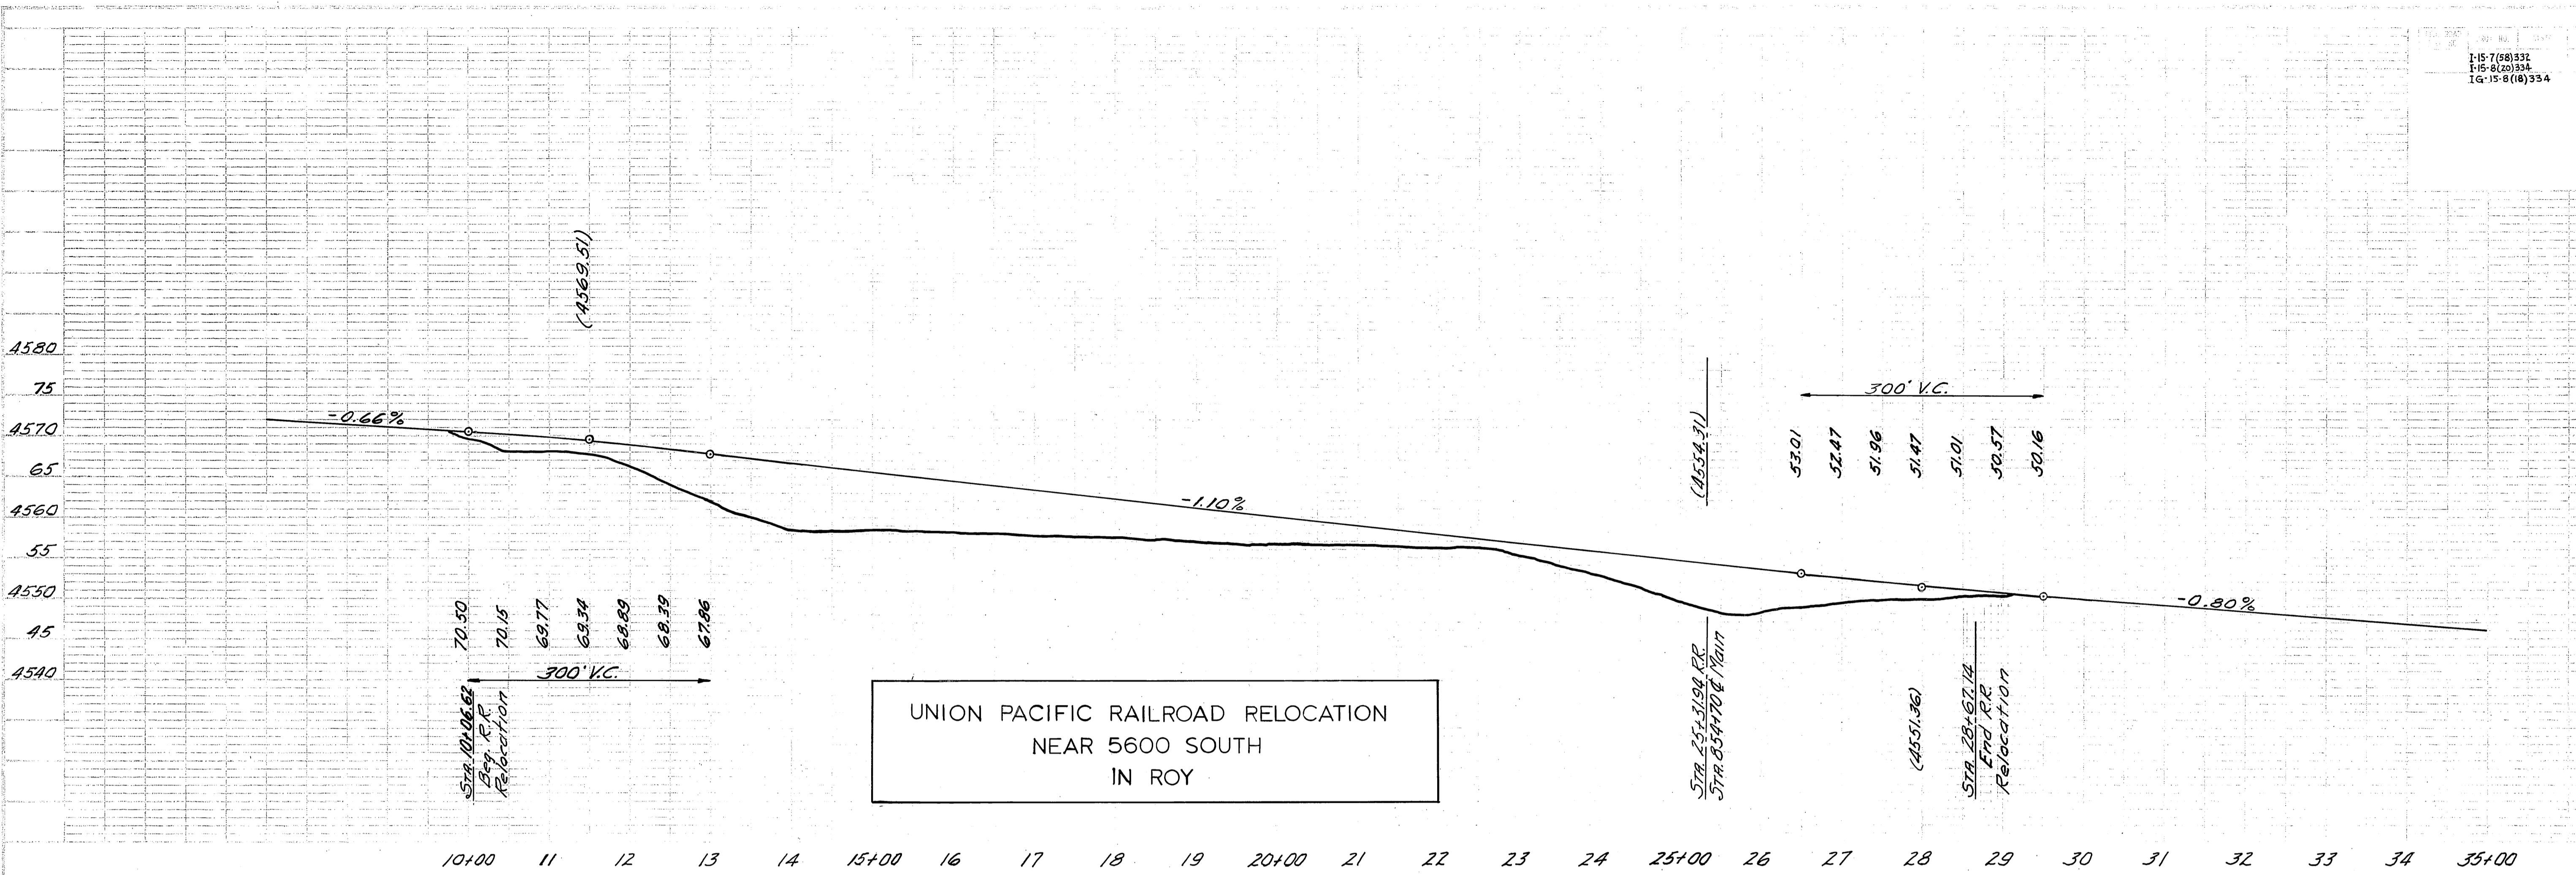

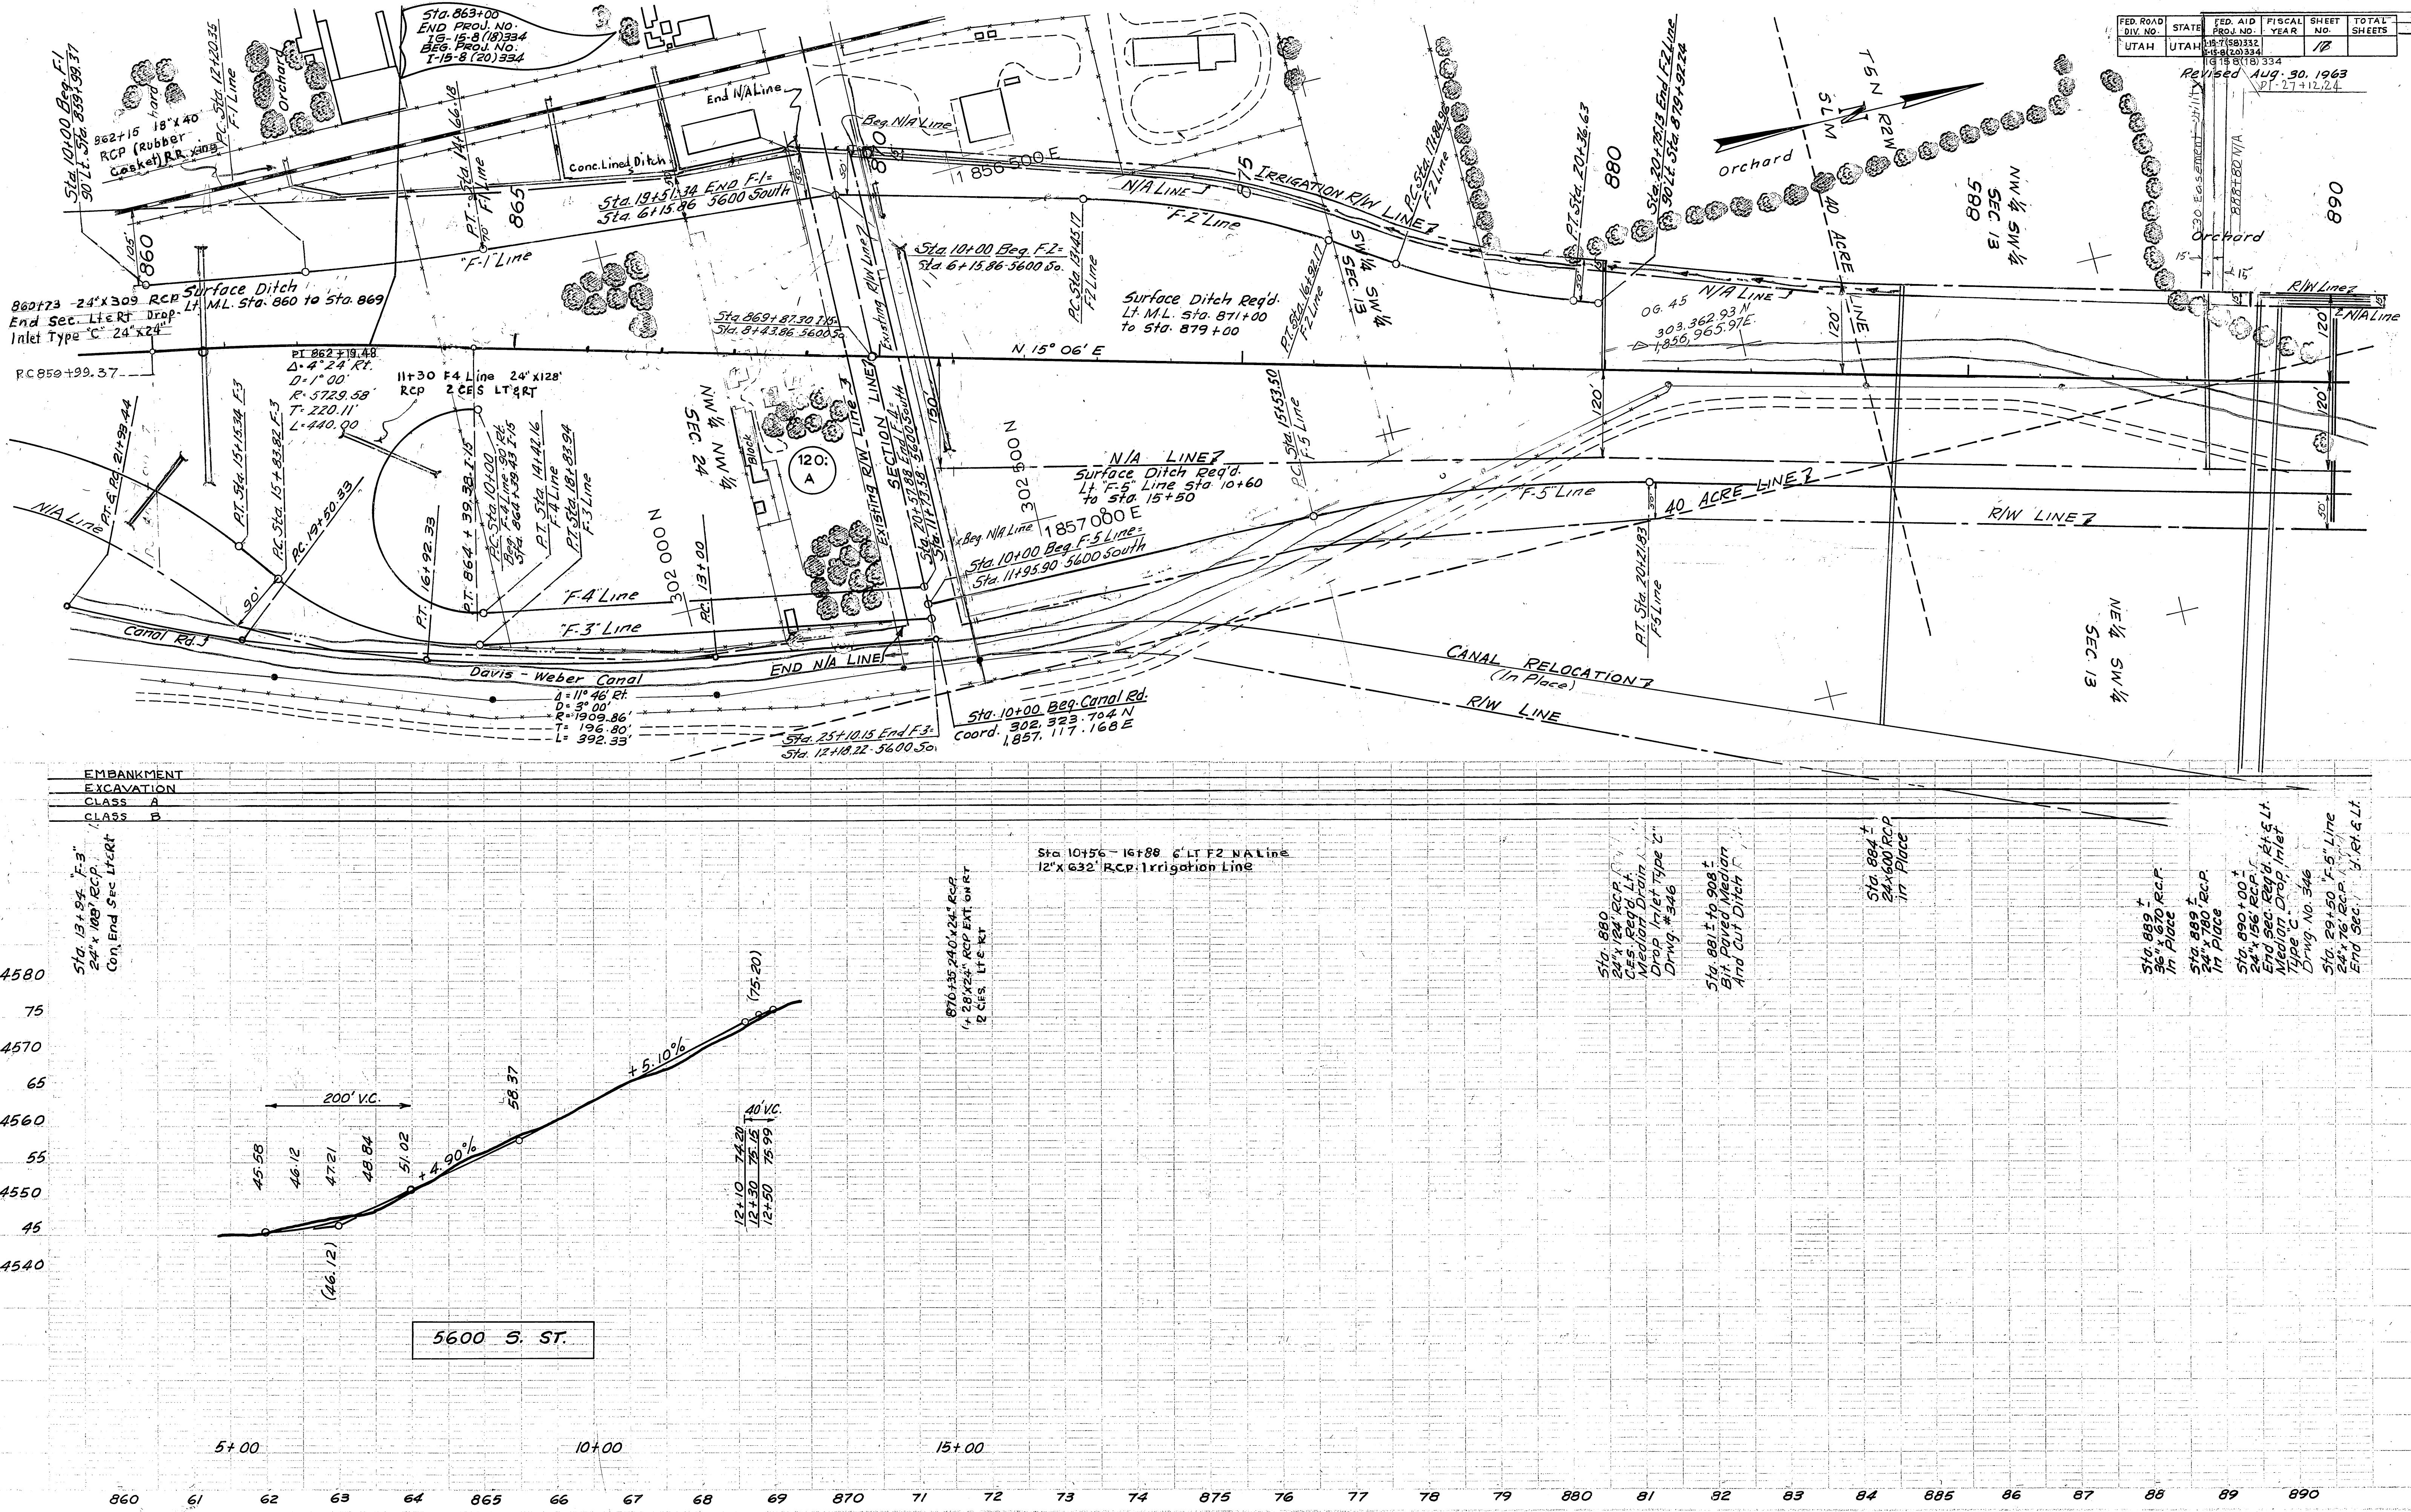

7-14-66 B					
D.ROAD ST. NO.	STATE	PROJ. NO.	FISCAL YEAR	SHEET NO.	TOTAL SHEETS
UTAH	UTAH	115-7(58)332 115-8(201)334		18	
		IG 15 8(18)334			


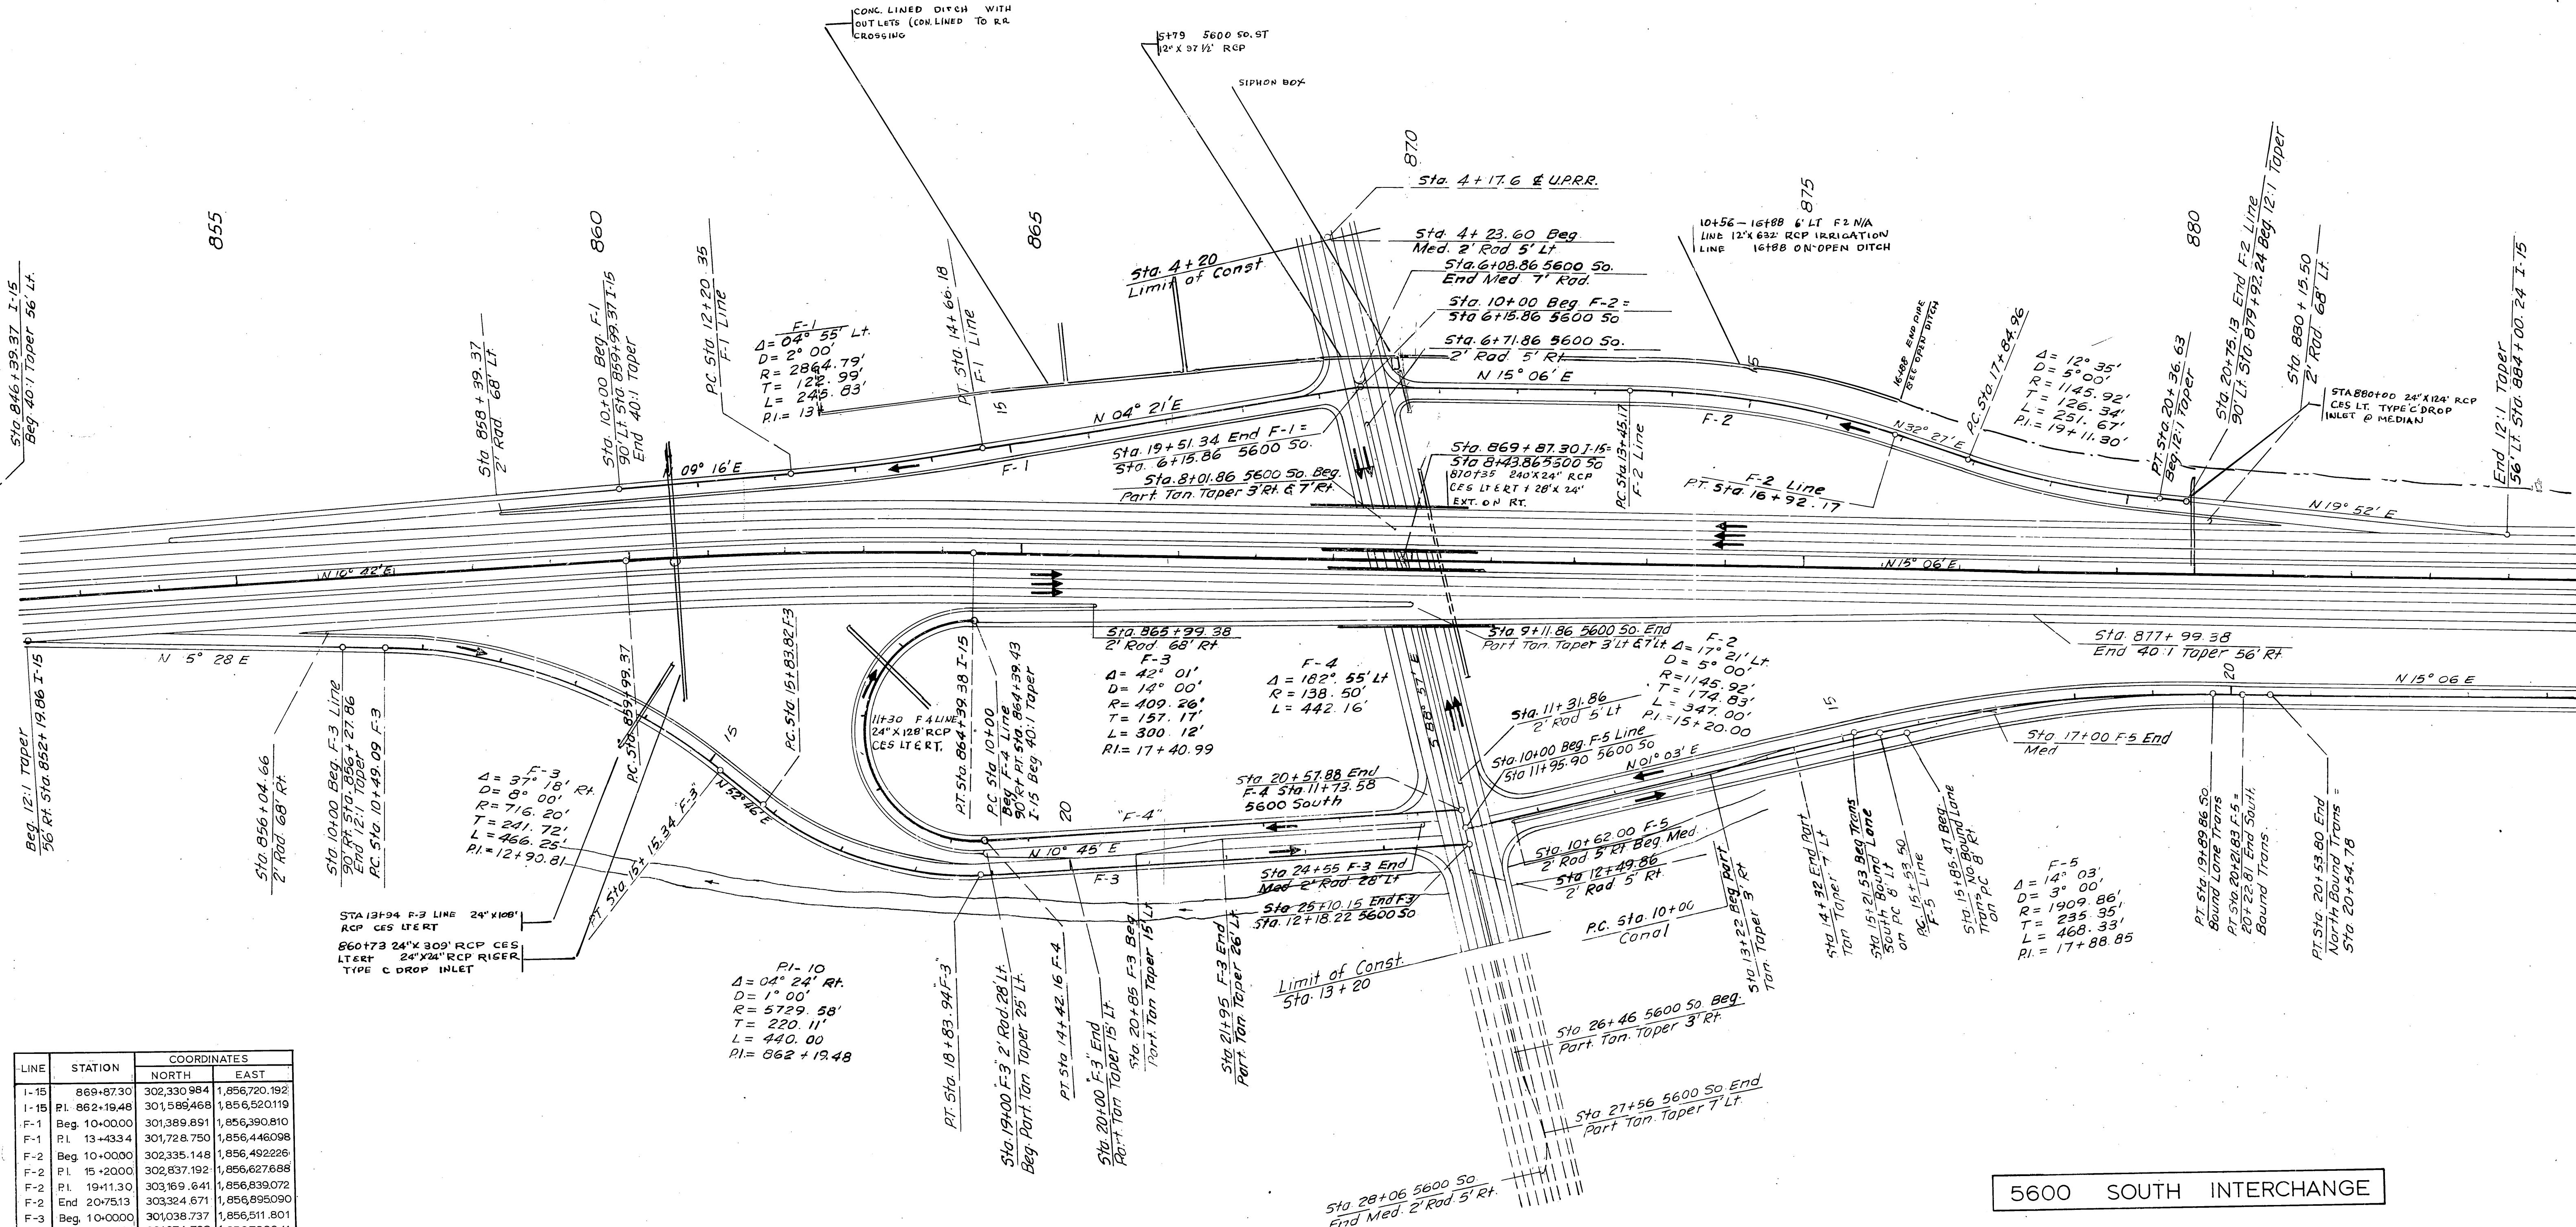


LINE	STATION	COORDINATES	
		NORTH	EAST
I-15	869+87.30	302,330.984	1,856,720.192
I-15	P.I. 862+19.48	301,589.468	1,856,520.119
F-1	Beg. 10+00.00	301,389.891	1,856,390.810
F-1	P.I. 13+43.34	301,728.750	1,856,446.098
F-2	Beg. 10+00.00	302,335.148	1,856,492.226
F-2	P.I. 15+20.00	302,837.192	1,856,627.688
F-2	P.I. 19+11.30	303,169.641	1,856,839.072
F-2	End 20+75.13	303,324.671	1,856,895.090
F-3	Beg. 10+00.00	301,038.737	1,856,511.801
F-3	P.I. 12+90.81	301,271.703	1,856,789.941
F-3	P.I. 17+40.99	301,554.492	1,856,948.371
F-3	End 25+10.15	302,324.124	1,857,094.490
F-4	Beg. 10+00.00	301,778.586	1,856,664.362
F-4	Cen. Curve	301,745.862	1,856,789.941
F-4	End 20+57.88	302,324.942	1,857,049.857
F-5	Beg. 10+00.00	302,324.529	1,857,072.176
F-5	P.I. 17+88.85	303,113.246	1,857,086.632

5600 SOUTH INTERCHANGE



ROAD NO.	PROJ. NO.	STATE	FISCAL YEAR	SHEET NO.	TOTAL SHEETS
	I-15-7(58)332				
	I-15-8(20)334			19	
	IG 15 8(18)334				


Rev 8-30-63

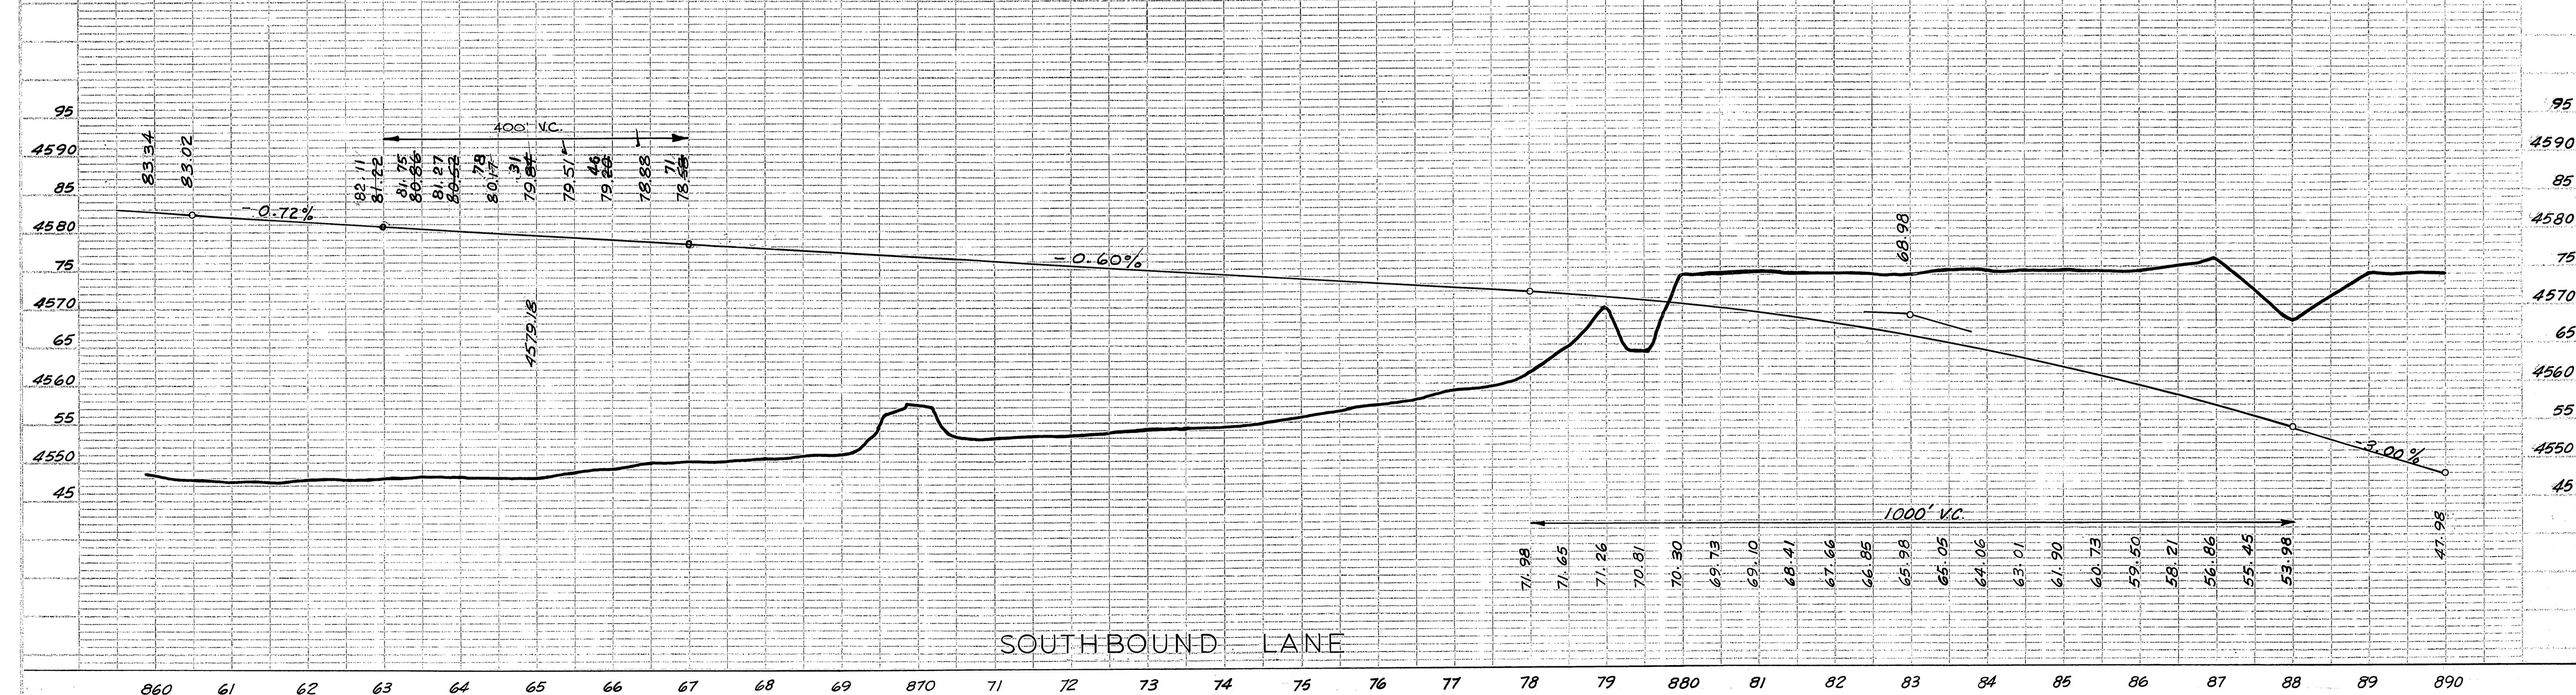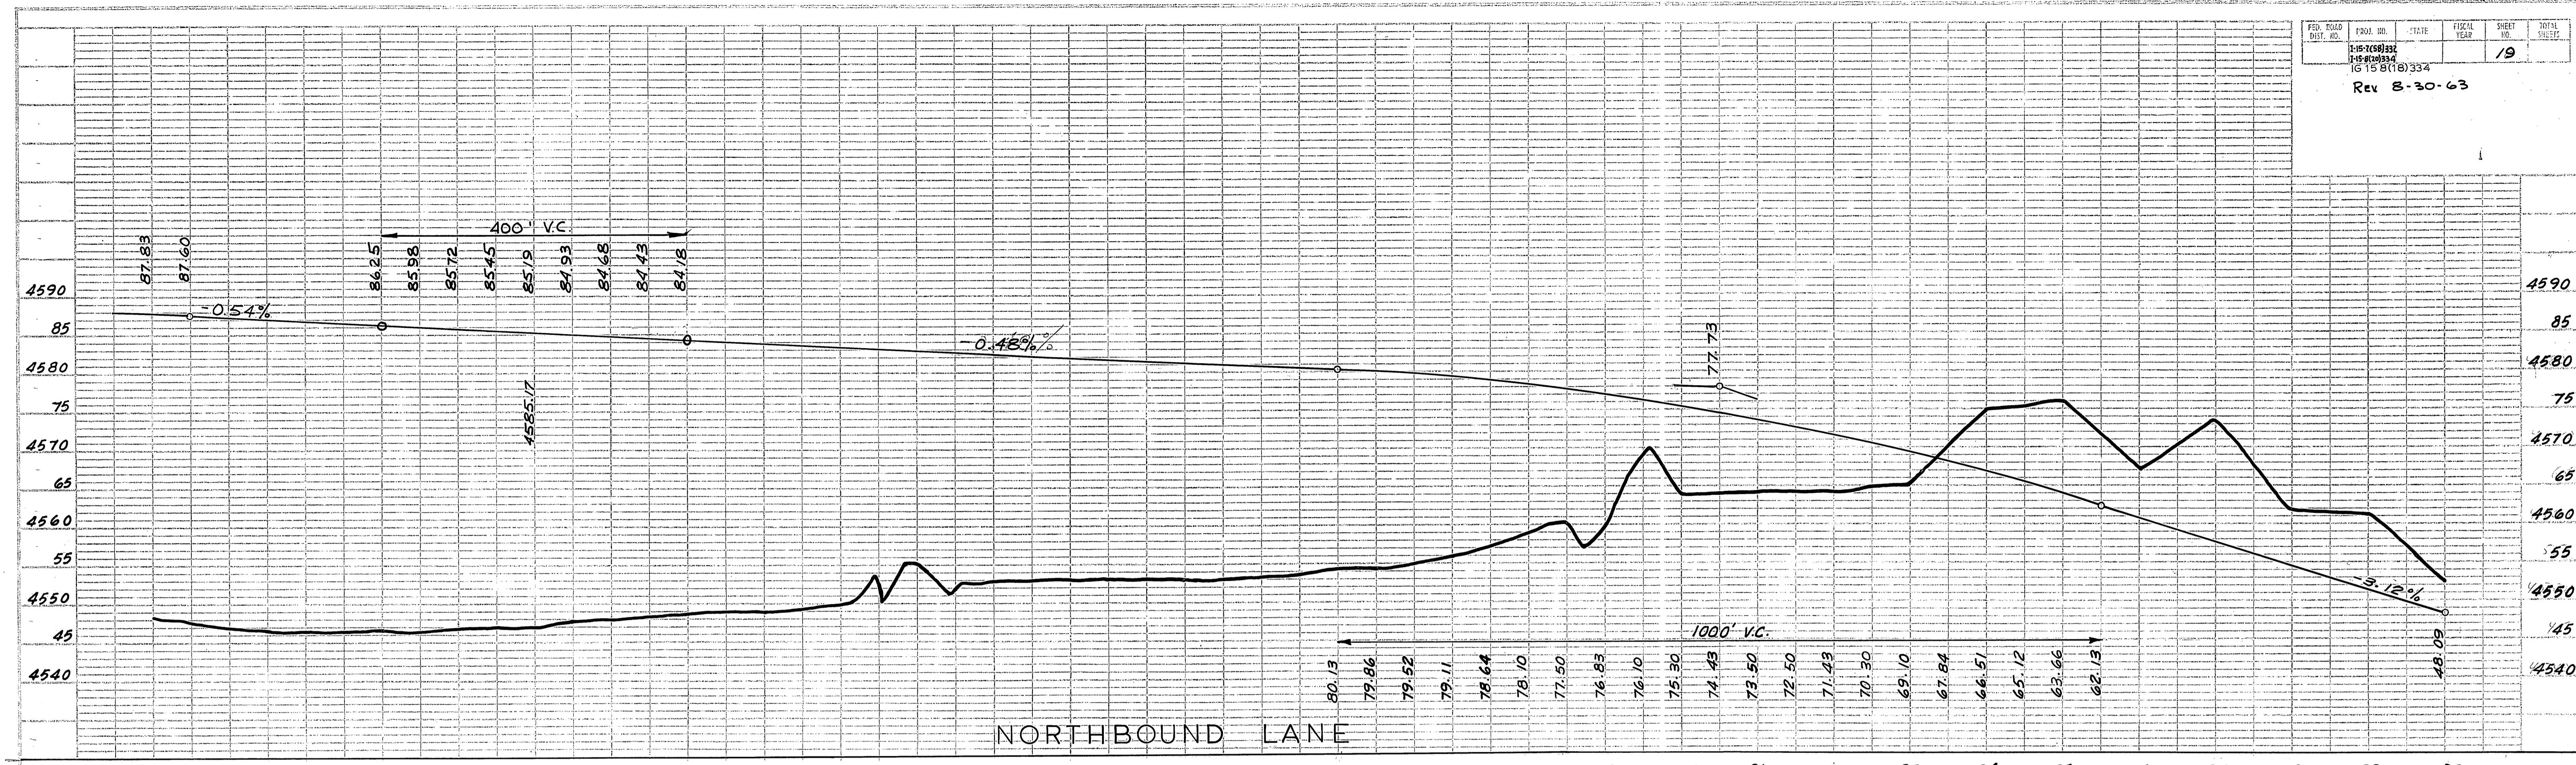


FED. ROAD MST. NO.	PCJL NO.	STATE	YEAR	SHEET	TOTAL SHEETS
I-5-7(58)332				20	20
I-5-8(20)334					
IG-5-8(18)334					

5600 SOUTH RAMPS

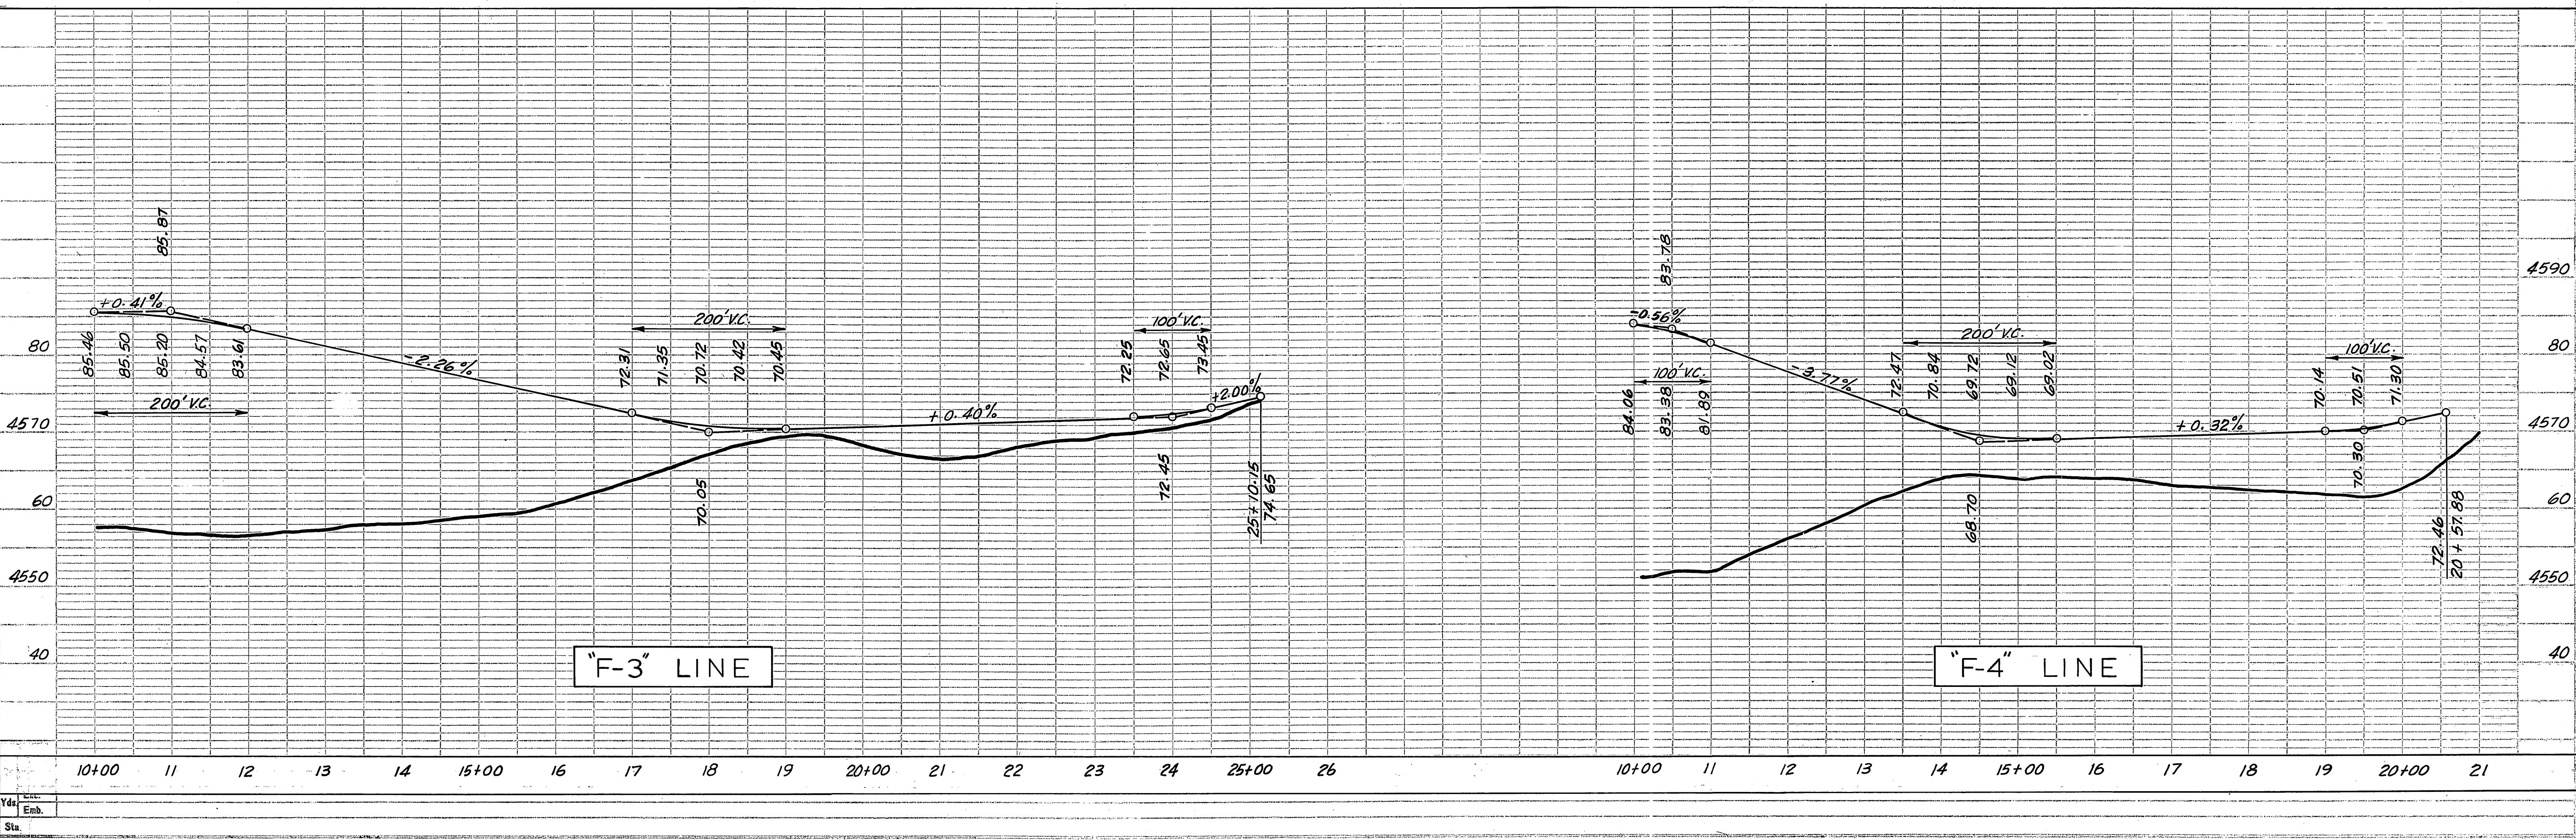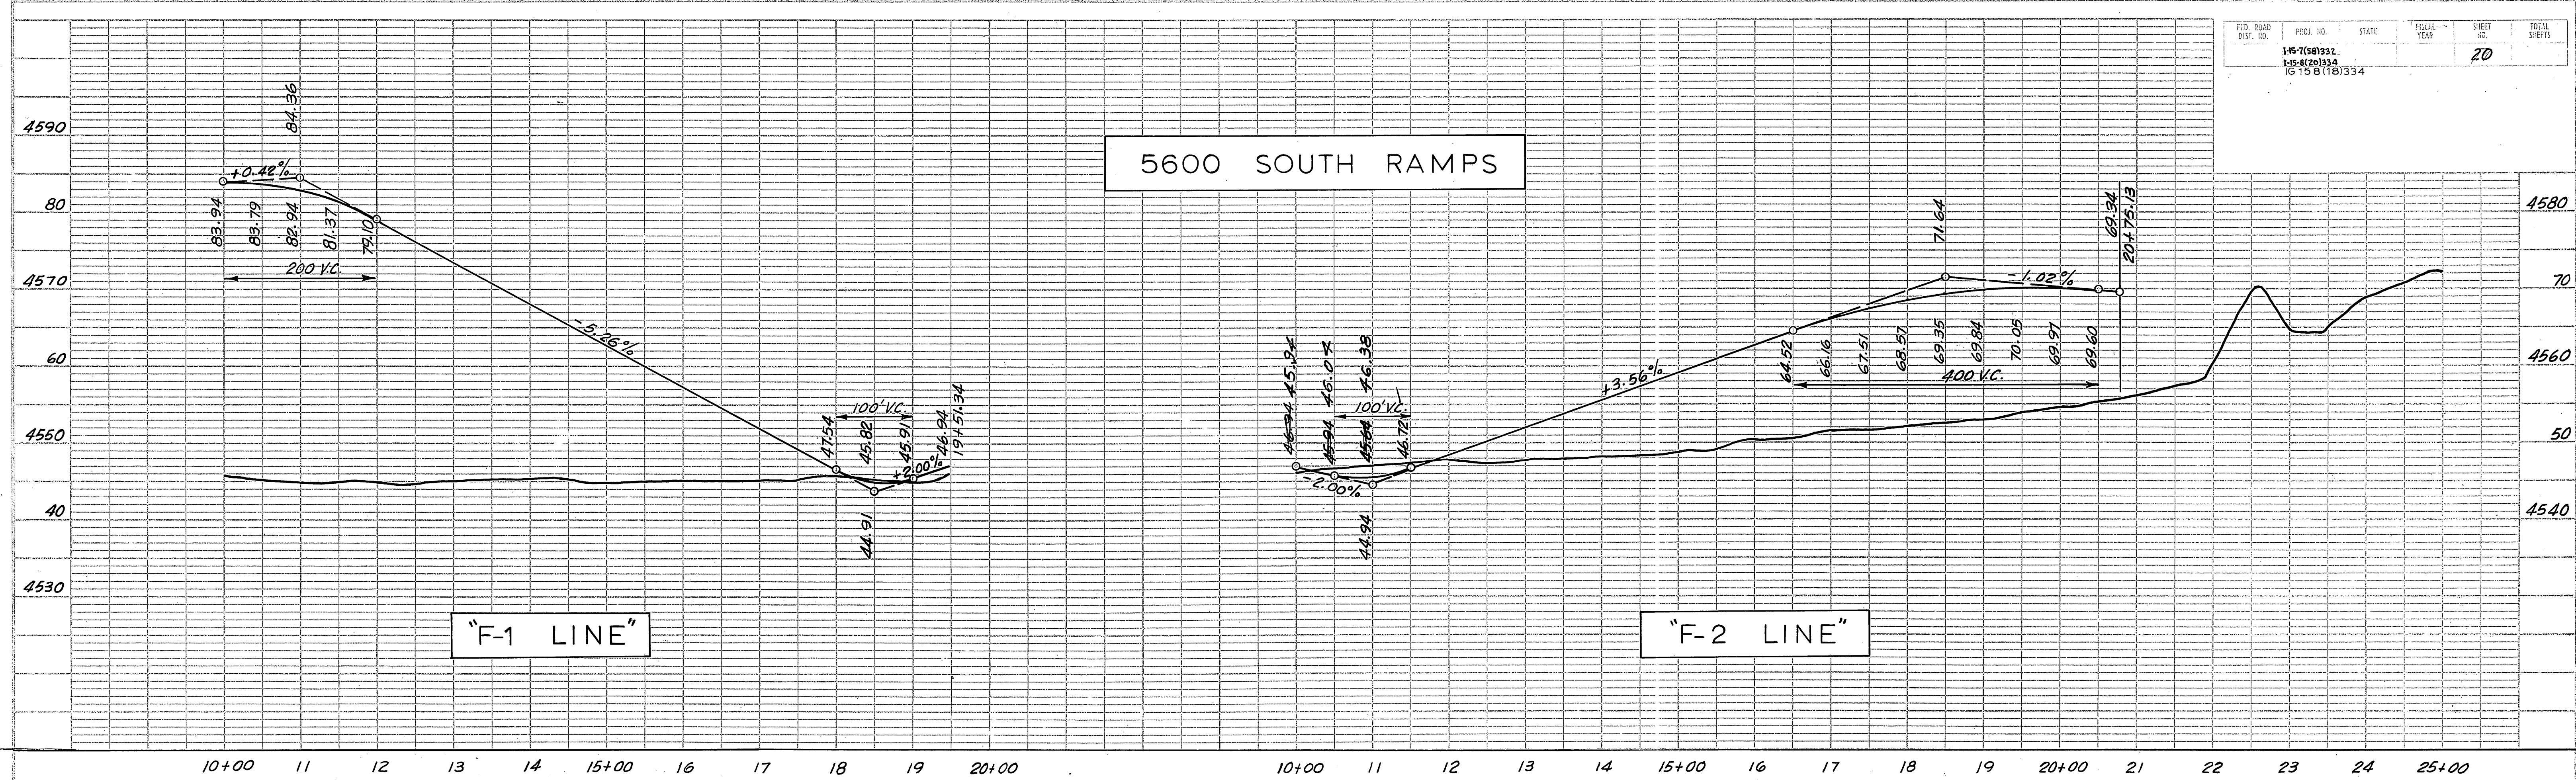

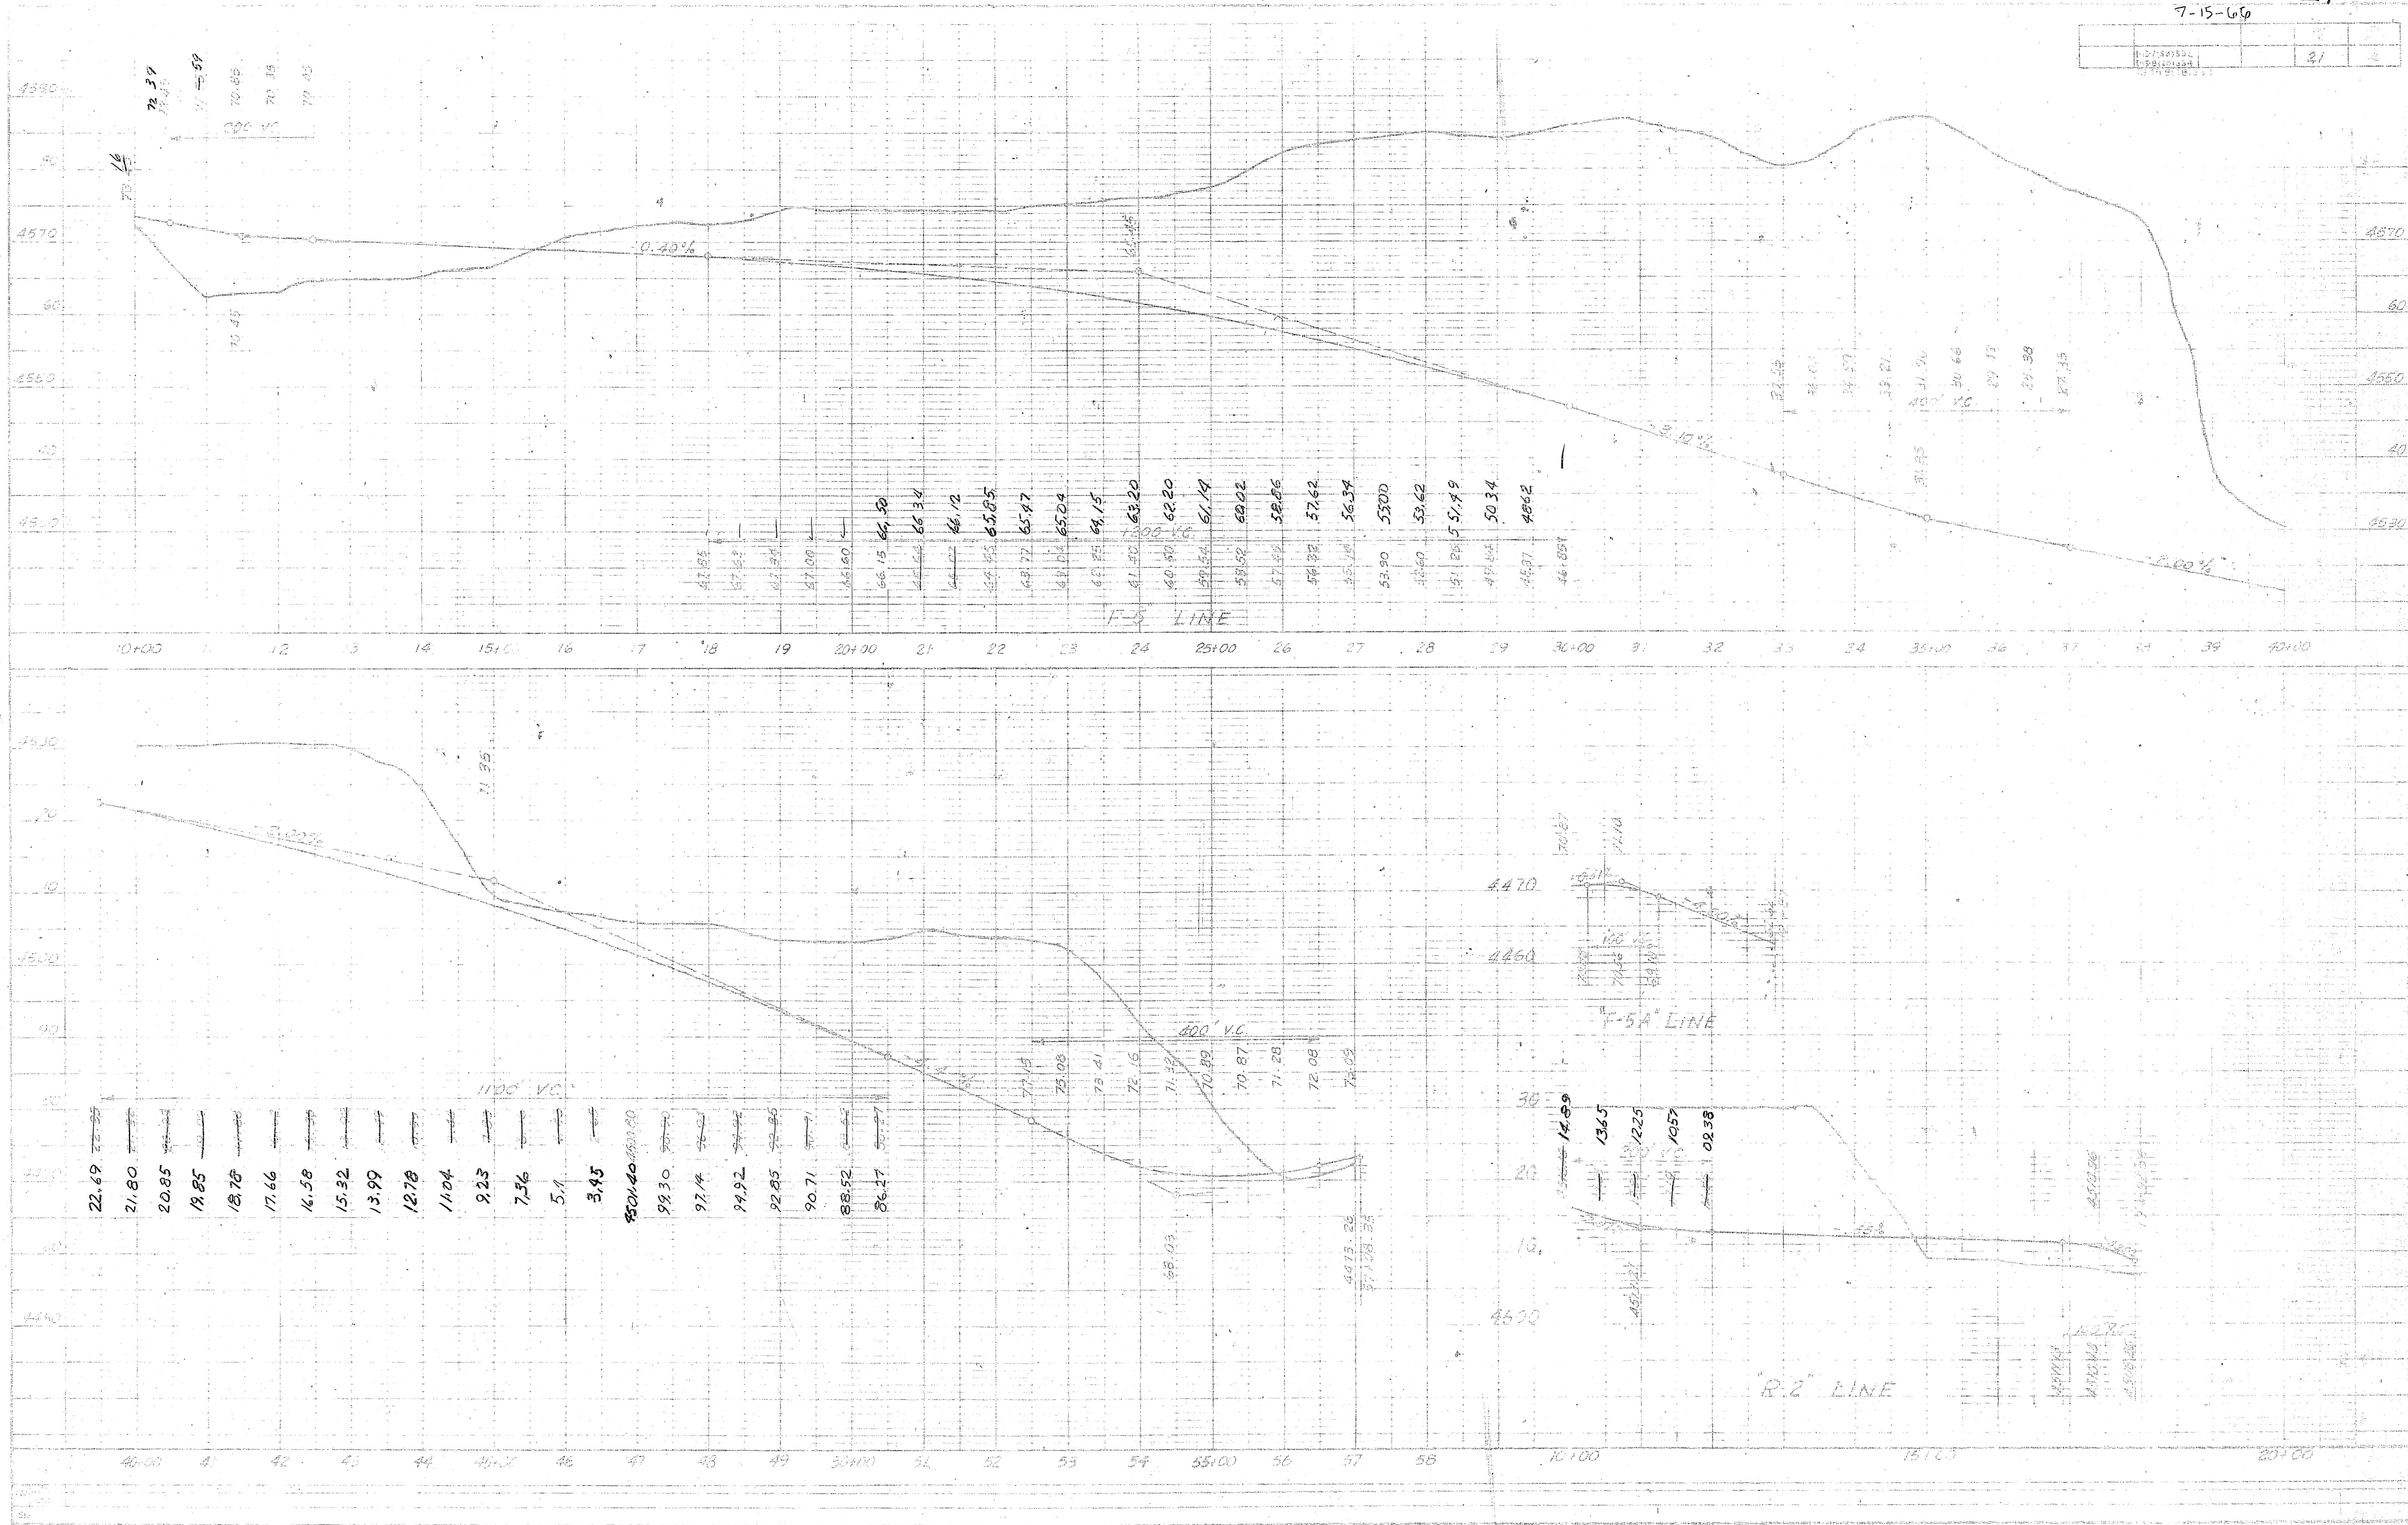

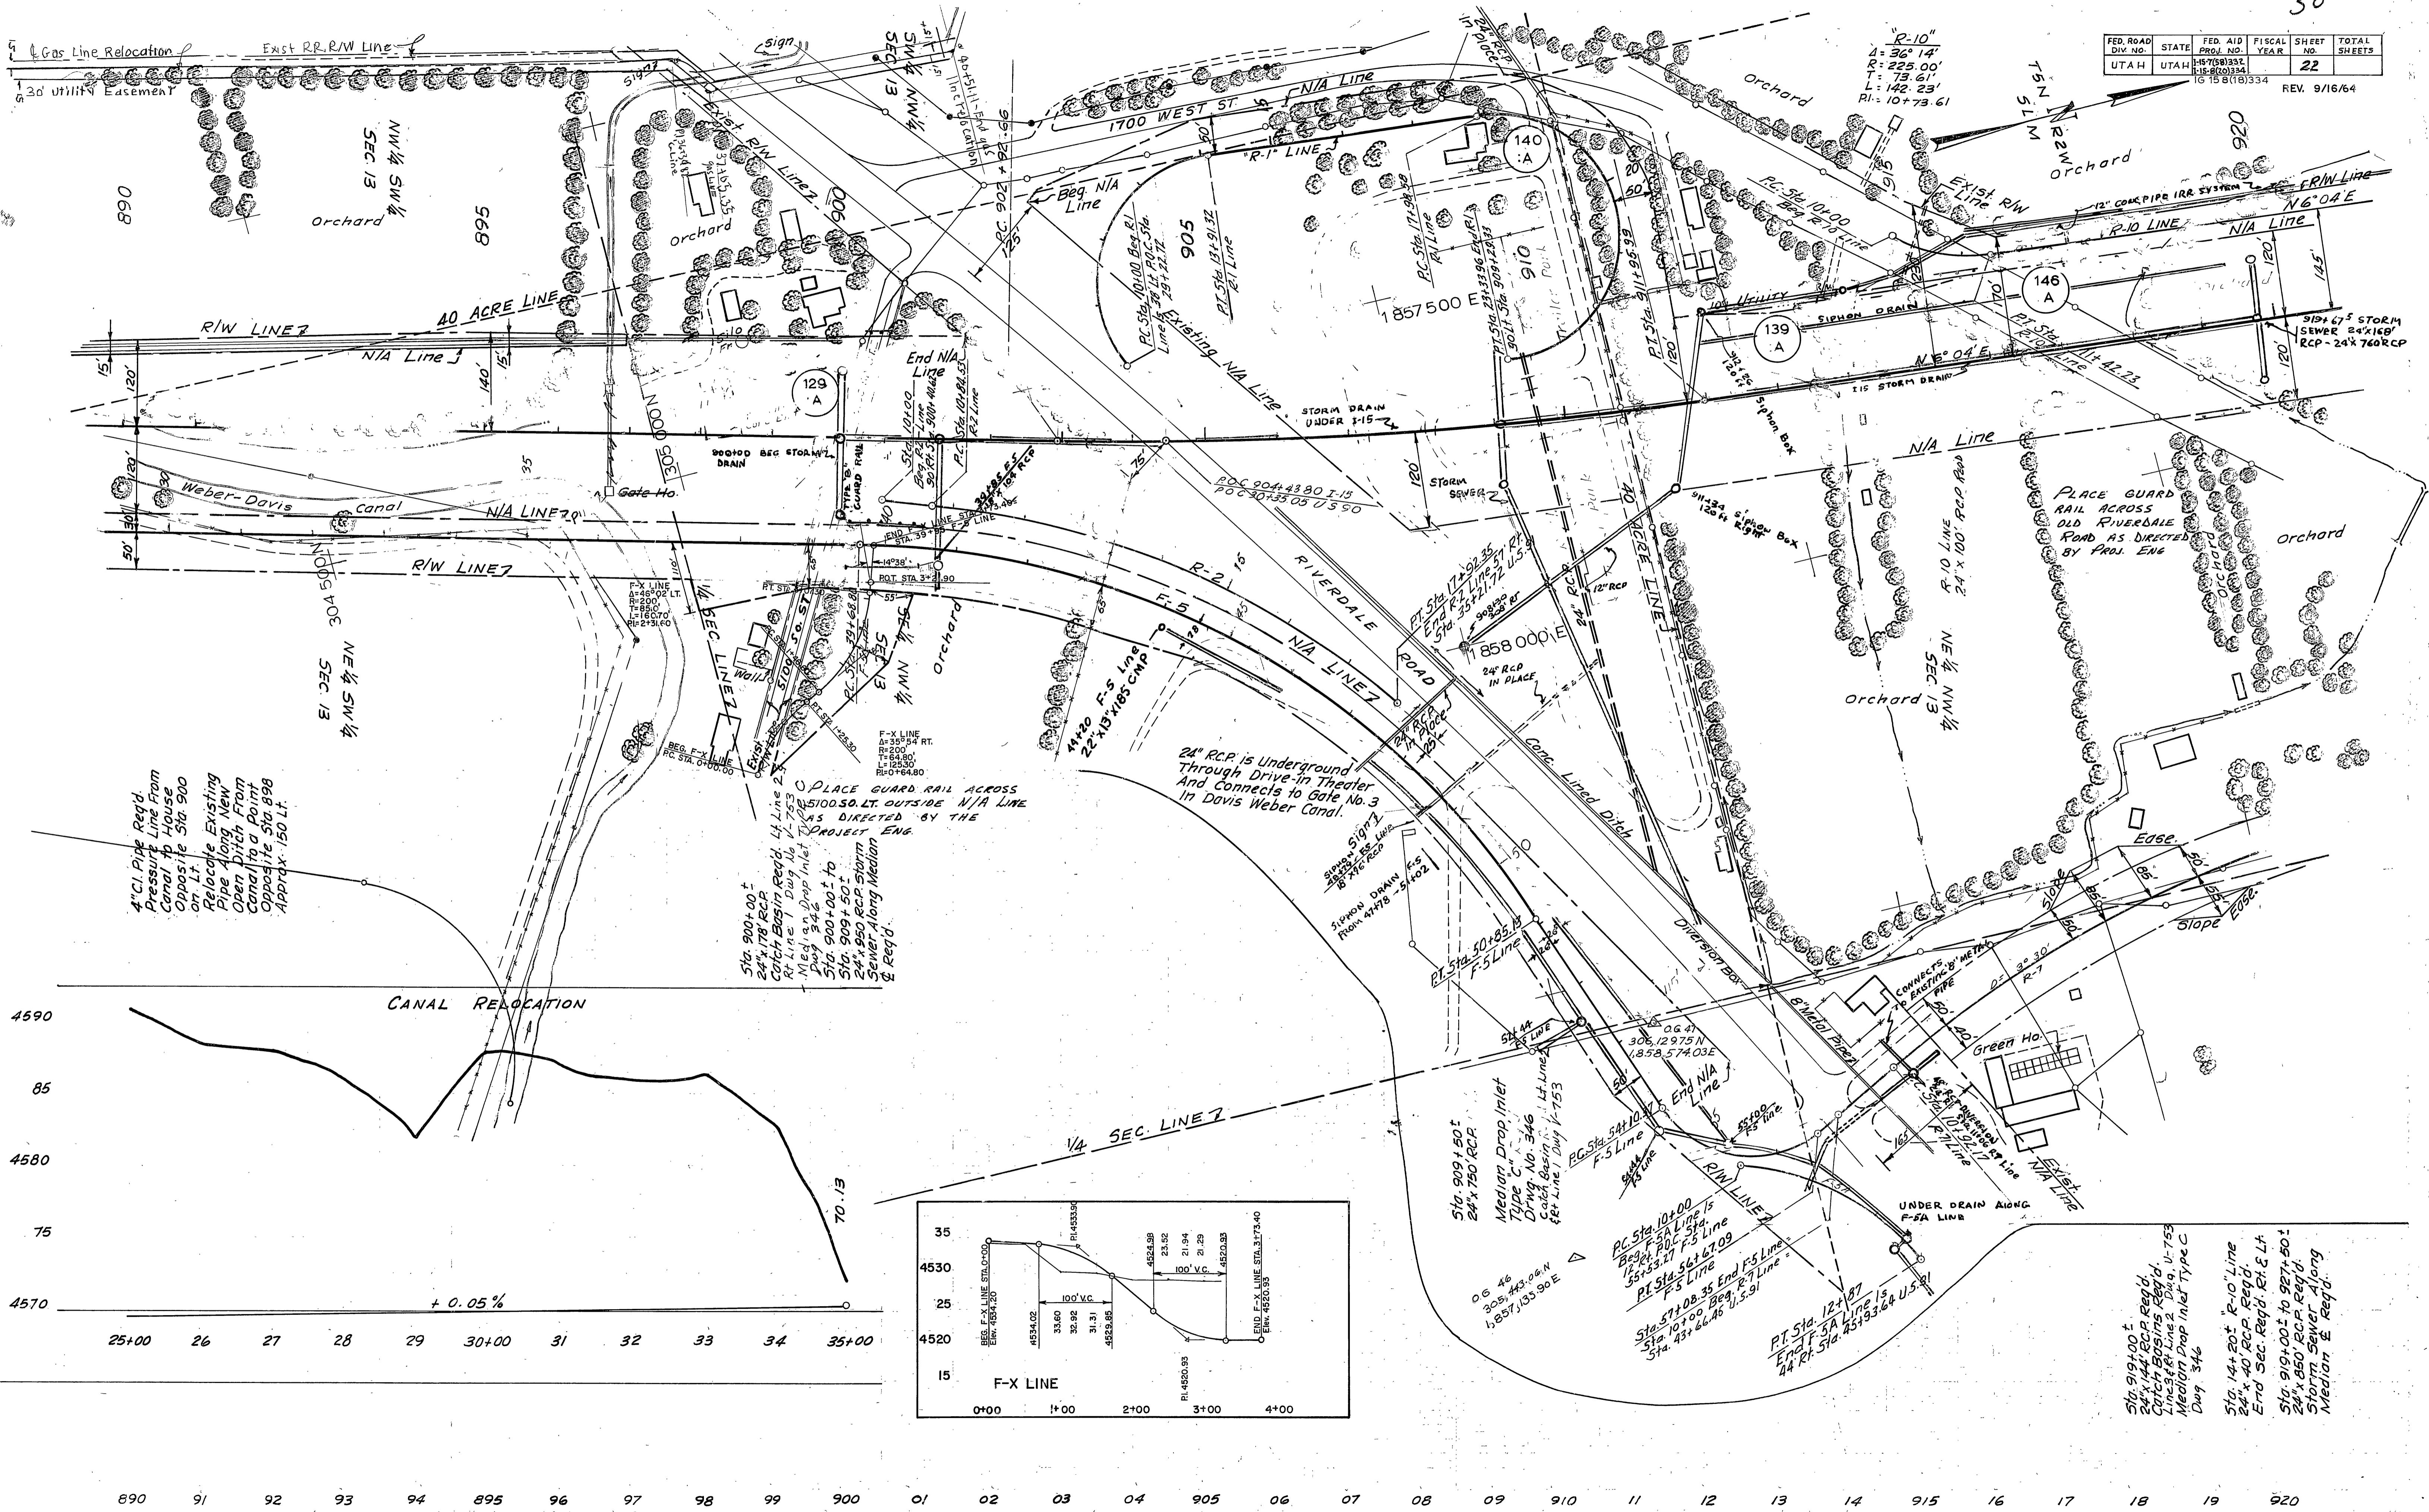

2

Ac. 7-18-66 B.					
ROAD BT. NO.	STATE	PROJ. NO.	FISCAL YEAR	SHEET NO.	TOTAL SHEETS
UTAH	UTAH	1-15-7(58)332 1-15-8(20)334		24	

